

MT. SAN JACINTO COLLEGE COMMUNITY COLLEGE DISTRICT

REQUEST FOR PROPOSALS (RFP) #2019-023 MATERIALS TESTING AND SPECIAL INSPECTION SERVICES for TEMECULA VALLEY CAMPUS

RFP Issue Date: Monday, May 13, 2019

RFP Due:

Thursday, June 6, 2019 at 10:00 AM

Submit Response to: Carole Ward

cward@msjc.edu

Contract Coordinator

and

Tammy Cunningham tcunningham@msjc.edu

Director of Procurement and General

Services

Questions and Clarifications

All questions must be submitted via e-mail

to: Carole Ward cward@msjc.edu and

Tammy

Cunningham tcunningham @msjc.edu

MT. SAN JACINTO COMMUNITY COLLEGE DISTRICT 1499 N. State Street, San Jacinto, CA 92583

NOTICE CALLING FOR REQUEST FOR PROPOSALS (RFP No. 2019-023) MATERIALS TESTING AND SPECIAL INSPECTION SERVICES FOR TEMECULA VALLEY CAMPUS

NOTICE IS HEREBY GIVEN that sealed proposals will be received at Mt. San Jacinto Community College District, Purchasing Office, until June 6, 2019, 10:00 a.m. local time, for all work necessary and incidental to:

Materials Testing and Special Inspection Services

Proposal shall be delivered and addressed to the Mt. San Jacinto Community College District, Attn: Tammy Cunningham – Director of Procurement and General Services, 1499 N. State Street, Room 223, San Jacinto, Ca 92583, and shall be labeled "Materials Testing and Special Inspection Services, RFP No. 2019-023", at or before June 6, 2019, 10:00 a.m.

The receiving time in the Purchasing Department will be governing time for acceptability of proposals. Proposals must bear original signatures and figures. No oral, telegraphic, electronic facsimile, or telephone proposals or modifications will be considered unless specified. It is the responsibility of the firm to see that the proposal submitted shall have sufficient time to be received by the Mt. San Jacinto Community College District, **Purchasing Office, Room 223 BEFORE** the proposal Submittal Deadline. Proposals received after the scheduled RFP Submittal Deadline will be returned unopened.

RFP documents are available at the Mt. San Jacinto Community College, Purchasing Office website at http://www.msjc.edu/Purchasing/Pages/--Current-Bids.aspx. Firms are responsible to regularly check the District's website for addendums. Specifications may also be examined and obtained at no charge in the District's Purchasing Office, or by calling (951) 487-3114.

Mandatory Pre-proposal Site Visit/Review of Project Documents:

A Mandatory Pre-proposal Site Visit is scheduled for Friday, May 24, 2019 at 10:00 a.m. at the Temecula Valley Campus, located at 41888 Motorcar Parkway, Temecula CA.

PURPOSE:

The District is requesting quotes from certified Materials Testing and Special Inspectors qualified to provide services in support of the Temecula Valley Campus Renovation project. The District intends to enter into a contract based on competitive hourly rates.

The District generally utilizes the services of outside consultants to help ensure the District that its activities are in compliance will all applicable regulations and industry guideline.

Tammy Cunningham

Director of Procurement and General Services, MSJC

Published: Press Enterprise

May 16, 2019 and May 23, 2019

1. REQUEST FOR PROPOSALS

1.1 Purpose

Mt. San Jacinto Community College District (MSJC) is requesting proposals from qualified companies to provide Material and Special Inspection Services for the Temecula Valley Campus Renovation project. Mt. San Jacinto College in Temecula will be renovating an existing 350,000 square foot, five-story office building for the Mt. San Jacinto College District's new Temecula Campus. The campus will be procured via Multiple Prime Contracts to the District with C.W. Driver acting as the District's Construction Manager.

1.2 **Proposal Submission**

If your firm is interested in providing full service Material and Special Inspection Services for the Project, proposals must be delivered to the address below, no later than **10:00 AM on Thursday, June 6, 2019.** Late proposals will not be considered. The District is not responsible for late mail or postal delivery errors. Proposers shall submit one electronic version of the proposal on a flash drive (optional); one (1) printed original proposal including any supporting documentation in a sealed box or package addressed as follows:

Attention: Tammy Cunningham

Mt. San Jacinto Community College District

Purchasing Department

Building 200, Room 223

1499 N. State Street

San Jacinto, CA 92583

1.3 **Response Format**

Each Consultant is required to submit a Proposal it deems appropriate to this RFP. Submittals should be brief and concise, but provide sufficient clarity to meet the criteria in the evaluation process. Each Consultant shall submit one (1) electronic proposal on a flash drive (optional) and one (1) printed original proposal. The District will evaluate the Proposals based on the responsiveness to District requirements listed in Section 6, Selection Criteria/Evaluation Process.

NOTE for Firms teaming with Sub-Consultants: Each responding firm shall select its proposed sub-consultants based on its own criteria. However, MSJCCD reserves the right to approve sub-consultants proposed for any projects that may be awarded. Sub-Consultants do not need to complete all the Exhibits in this RFP. Carefully read each section to determine which forms the Sub-consultants need to submit.

1.4 Questions

Consultants must carefully read the entire RFP prior to submitting questions as most questions will be answered in this RFP. All questions must be submitted in writing via e-mail to Carole Ward (cward@msjc.edu) and Tammy Cunningham (tcunningham@msjc.edu). The question deadline for this RFP is **Monday, May 28, 2019 by 10:00 AM**. After this deadline, the District will not answer, address, and/or review any questions that interested Consultants might submit. Responses to all questions received prior to the deadline will be provided to all Consultants.

1.5 Request for Proposals

Pre-Qualified Consultants are in no way guaranteed to receive any work from the District. Each Proposal shall describe the Consultant's experience and expertise with respect to the services, if any, which are unique to the property or project that is the subject of this RFP. In addition, the Proposal shall set forth a detailed scope of services, a completion schedule, a schedule of professionals that will be used to supervise and staff the project, and a not-to-exceed dollar amount for the services to be performed. The District will allocate work to said Pre-qualified Consultants without having to request and evaluate additional information as to Consultant's qualifications. Consultant shall assign only trained and experienced personnel, support staff, and other Consultants to the requisite tasks. Consultant shall provide cost to perform the tasks outline in the Scope of Services referenced in this RFP.

1.6 Mandatory Pre-proposal Site Visit/Review of Project Documents:

A Mandatory Pre-proposal Site Visit is scheduled for Friday, May 24, 2019 at 10:00 a.m. at the Temecula Valley Campus, located at 41888 Motorcar Parkway, Temecula CA.

Consultant must attend job walk. Any Inspection firm submitting a proposal who fails to attend the entire mandatory job walk and conference will be deemed a non-responsive bidder and will have its proposal returned unopened. Any Inspection firm who fails to arrive on time (10:00 a.m.) will not be able to participate in the Pre-Proposal site visit.

1.7 **Pre-qualification of Bidders**

As a condition of bidding for this Project, and in accordance with California Public Contract Code Section 20651.1, prospective bidders are required to submit to the District a completed set of prequalification documents on forms provided by the District. Prequalification documents are available at the Mt. San Jacinto Community College District, Office of Procurement and General Services, Room 223, located at 1499 N. State St., San Jacinto, California 92583 or go to the Mt. San Jacinto Community College Purchasing Office website located htttp://www.msjc.edu/Purchasing/Pages/UPCCA.aspx to download the UPCCA Pre-Qualification Questionnaire. The pregualification documents must be submitted prior to 10:00 a.m. on May 29, 2019. Bids will not be accepted if a Contractor has not been pregualified where qualification is required. Contractors will be notified by telephone or e-mail of their pregualification status within a reasonable period of time after submission of their prequalification documents.

1.8 <u>DIR Registration</u>:

A Construction Inspection firm shall not be qualified to submit a proposal, subject to the requirements of Section 4104 of the Public Contract Code, or engage in the performance of any contract for public work, as defined in the Labor Code, unless currently registered and qualified to perform public works pursuant to Section 1725.5. It is not a violation of this section for an unregistered inspection firm to submit a bid that is authorized by Section 7029.1 of the Business and Professions Code or by Section 10164 or 20103.5 of the Public Contract Code, provided the construction inspection firm is registered to perform public work pursuant to Section 1725.5 at the time the contract is awarded.

This Project is a public works project as defined in Labor Code section 1720. Each contractor bidding on this Project and all subcontractors (of any tier) performing any portion of the Work must comply with the Labor Code sections 1725.5 and 1771.1 and must be properly and currently registered with DIR and qualified to perform public works pursuant to Labor Code section 1725.5 throughout the duration of the Project. For more information and up to date requirements, architects are recommended to periodically review the DI's website at www.dir.ca.gov. Inspection firm shall be solely responsible for ensuring compliance with Labor Code section 1725.5 as well as any requirements implemented by DIR applicable to its services or its subcontractors throughout the term of the Agreement and in no event shall contractor be granted increased payment from the District or any time extensions to complete the Project as a result of contractor's efforts to maintain compliance with the Labor Code or any requirements implemented by DIR. Failure to comply with these requirements shall be deemed a material breach of this Agreement and grounds for termination for cause. The contractor and all subcontractors shall furnish certified payroll records as required pursuant Labor Code section 1776 directly to the Labor Commissioner in accordance with Labor Code section 1771.4 on at least on a monthly basis (or more frequently if required by the District or the Labor Commissioner) and in a format prescribed by the Labor Commissioner. The District reserves the right to withhold contract payments if the District is notified, or determines as the result of its own investigation, that contractor is in violation of any other the requirements set forth in Labor Code section 1720 et. Seg. at no penalty or cost to the District. Monitoring and enforcement of the prevailing wage laws and related requirements will be performed by the Labor Commissioner/Department of Labor Standards Enforcement (DLSE).

2. PROPOSAL SUBMISSION

- 2.1 The proposals should include the following:
 - Cover Letter: Briefly describe the qualifications of the company and the proposed personnel for this project and provide a statement that you have reviewed the schedule listed in the RFP and agree to provide the necessary effort or staff allocation to meet the schedule listed in Section 4 of this RFP. (1 page max)
 - 2. Approach to Work: provide (i) a statement of the proposed approach to the project scope of work with a description of the tasks, sub-tasks, deliverables that will be provided, and how the staff intend to coordinate and collaborate

- with the design team to meet the project schedule, and (ii) a description of the Quality Assurance/Control (QA/QC) plan to be followed during the duration of the work. The OA/QC plan shall address the accuracy, completeness and timeliness of all testing and related reports. (1 page Max)
- 3. List of the main point of contact for the project team and key personnel. Clearly identify the individual (s) role (s) and responsibilities in the testing program. Include resumes of the proposed personnel with relevant testing experience. (1 page max per individual).
- 4. Relevant Project List: Provide project experience information of the company describing type, size, location, and any unique features or process of the project that may be relevant to this project. (1 page max).
- 5. Fee proposal: Lump Sum Fee Proposal clearly listing professional testing services and assumptions. Please also include our hourly billing rates. (include number of pages as needed).

3. Selection Criteria

- Timeliness and Completeness: To receive consideration, Responses to this RFP must be received by the Response Deadline. In addition, RFP Response will be evaluated with respect to organization, clarity, completeness, and responsiveness to this RFP.
- 2. Technical Qualifications and Competence: This includes Company and Personnel's experience, expertise, and familiarity with providing Special Testing Services required by the RFP.
- 3. Approach to Work: This includes your overall approach/methodology and QA/QC plan to meet the project schedule.
- 4. Fee: Evaluation of proposed fee structure for requested services.

4. PROJECT DESCRIPTION

4.1 Mt. San Jacinto Community College District is in need of Material and Special Inspection Services for the Temecula Valley Campus.

The selected firm will include the following as part of services:

Each Consultant must be prepared to support multiple construction projects ranging from reconstruction/modernization, retrofit, infrastructure and new construction. Each Consultant must be prepared and equipped to provide such services in a timely manner and on a relatively short notice so as to enable the District to meet critical, and at times unpredictable, time deadlines and schedules.

4.2 **SCOPE OF SERVICES**

The scope of services shall include, but not necessarily be limited to, Materials Testing and Special Inspection services. Testing and inspections are based on the applicable California Building Code (CBC) and per the requirements of the DSA and the DSA-approved project contract documents including the DSA Form 103.

- a. Provide sufficient home office organization and support, personnel and management to carry out the requirements of this RFQ in an expeditious and economical manner consistent with the best interests of the District.
- b. Perform Materials Testing and Special Inspection services consistent with the highest standard of care for professionals performing similar scopes of services. Provide senior management support for all tasks.
- c. Coordinate and cooperate with other Project team members including the District staff, Architect, Construction Manager and DSA Project Inspector.
- d. The Consultant shall work under the direction of the DSA Project Inspector/Inspector of Record (IOR) and will notify the IOR immediately of any discrepancy between construction and contract documents, deficiency of workmanship or unacceptable results. The Consultant and IOR and District representatives shall meet periodically to plan and schedule testing and inspection services.
- e. Upon completion of inspection services, the Consultant shall provide a field report to the IOR prior to leaving the project site. Formal reports shall be delivered within 7 working days to the IOR and District representatives or as determined at the preconstruction meeting. Test reports shall be signed by a Registered Civil Engineer licensed in the State of California.
- f. Laboratory Certifications and Accreditations: Testing Laboratory personnel shall be certified by ICBO for the type of work they are performing and shall be accepted by the DSA prior to performance of any work on or off the project site. The laboratory must have been in operation for a minimum of five years within the State of California. The testing laboratory shall be responsible for the quality of services provided and maintain the necessary equipment required to satisfy the testing requirements.
- g. The Consultant shall establish a 24-hour contact during construction.
- h. The Consultant shall furnish all labor, supervision, technicians, tools, equipment, supplies, reports, documentation and tests to perform all sampling and testing and insure the contractors comply with applicable regulations and procedures.
- Testing firm is to take into consideration the accelerated construction schedule. The manpower for welding inspection and all other testing requirements maybe required on multiple levels simultaneously
- j. Testing firm will include in the proposal attendance to project meetings for the first 4 months starting at the pre-construction.

5.0 WORKING CONDITIONS

Each Inspector shall be capable of working indoors and outdoors, in all weather and site conditions including, but not limited to, rain, dirt, mud, and ice. The Inspector's activities may require kneeling, bending, climbing ladders, stepping over trenches, etc.

Project Location: Mt. San Jacinto Community College District

Temecula Valley Campus 41888 Motor Car Parkway Temecula, CA 92591

- 6.1 Compliance with Laws, Workers Compensation Insurance, Hold District Harmless. The INSPECTOR shall comply with the applicable federal, state and local laws, rules, regulations and ordinances, including workers compensation insurance laws. The INSPECTOR understands that, as an independent contractor, INSPECTOR is not covered by any type of DISTRICT insurance, including workers compensation insurance. The INSPECTOR shall provide, through insurance policies or self-insurance, workers compensation insurance coverage for its employees who provide services hereunder. The DISTRICT understands that the INSPECTOR may use independent contractors, volunteers or others not covered by the INSPECTOR's worker's compensation coverage to provide services hereunder. The INSPECTOR shall advise such persons providing services hereunder at the direction of the INSPECTOR that workers compensation insurance is not provided by the District, and the INSPECTOR shall hold the DISTRICT harmless from any and all claims for damages that may be asserted by such persons.
- 6.2 Self-employment, Responsibility for Medical Insurance and Cost. If the INSPECTOR is a self-employed individual, the INSPECTOR agrees to arrange, in lieu of workers compensation insurance, for insurance for or financial responsibility for any and all medical and related treatment, and to pay the cost of such treatment, including emergency treatment that may be provided that the INSPECTOR did not arrange for which may be required due to any injuries of any type that may be sustained by the INSPECTOR while performing services under this AGREEMENT. The INSPECTOR shall, prior to commencing services herein, provide the DISTRICT with satisfactory evidence of medical coverage as set forth in Paragraph 1.5, below. Cancellation or lack of medical coverage for the INSPECTOR shall not relieve the INSPECTOR or INSPECTOR's financial responsibility for the cost of medical and related treatment.
- 6.3 Professional Liability (Errors and Omissions). The INSPECTOR shall carry and maintain during the term of this AGREEMENT a policy of Professional Liability Insurance (Errors and Omissions) with a limit of not less than \$500,000 per occurrence. The DISTRICT reserves the right to waive this insurance requirement and if so waived, the INSPECTOR shall hold the DISTRICT harmless from any and all claims for damages.
- 6.4 Auto Liability. The INSPECTOR shall confirm that all individual inspection staff shall carry and maintain personal Auto Liability for owned, hired and non-owned vehicles, for injury damage and loss, including but not limited to, premises and operations, contractual liability and personal injury that may arise from and in connection with the performance or nonperformance of INSPECTOR's services herein. The INSPECTOR shall hold the DISTRICT harmless from any and all claims for injury, damage, and loss.
- 6.5 Evidence of Coverage, Cancellation or Material Changes. Not later than ten (10) calendar days after the date of execution of this AGREEMENT and, in any case, prior to commencement of any of the INSPECTOR's services herein, the INSPECTOR shall furnish certificates of insurance evidencing the insurance coverage required above, including endorsements, to the DISTRICT's Department administering the

Agreement which certificates shall provide that such insurance shall not be terminated or expire or be materially changed without thirty (30) calendar days written notice to the Department, and INSPECTOR shall maintain such insurance from the time that the INSPECTOR commences performance of services hereunder until INSPECTOR's completion of such services. Within sixty (60) calendar days of the commencement of this Agreement, the INSPECTOR shall furnish certified copies of the policies and all endorsements.

- 6.6 Additional Named Insureds. All insurance policies, except for Workers Compensation shall contain additional endorsements naming the DISTRICT and its officers, employees, agents and volunteers as additional named insureds with respect to liabilities arising out of the performance of services hereunder.
- 6.7 Waiver of Subrogation Rights. INSPECTOR shall require the carriers of the coverages required above to waive all rights of subrogation against the DISTRICT, its officers, employees, agents, volunteers, contractors and subcontractors.
- 6.8 Policies Primary and Non-Contributory. All policies required above shall be primary and non-contributory with any insurance or self-insurance programs carried or administered by the DISTRICT.
- 6.9 Insurance Review. The above insurance requirements are subject to periodic review by the DISTRICT. The DISTRICT's Risk Manager is authorized, but not required, to reduce or waive any of the above insurance requirements whenever the Risk Manager determines that any of the above insurance is not available, is unreasonably priced, or is not needed to protect the interests of the DISTRICT. In addition, if the Risk Manager determines that heretofore unreasonably priced or unavailable types of insurance coverage or coverage limits become reasonably priced or available, the Risk Manager is authorized, but not required, to change the above insurance requirements to require additional types or insurance coverage or coverage limits, provided that any such change is reasonable in light of past claims against the DISTRICT, inflation, or any other item reasonably related to the DISTRICT's risk. Any such reduction or waiver for the entire term of the Agreement and any change requiring additional types or insurance coverage or higher coverage limits shall be made by amendment to the Agreement. INSPECTOR agrees to execute any such amendment with thirty (30) calendar days of receipt.

7.0 EVALUATION & RECOMMENDATION CRITERIA:

7.1 Evaluation

Proposals will be evaluated by an evaluation panel consisting of individuals selected by the District. At the District's discretion, some, one, or all of the responding firms may be requested to participate in an oral interview. The interview will be used as another opportunity to clarify any issues with a given proposal and explore the approaches that may be used to satisfy all the District's requirements. The District reserves the right to request that some or all of the responding firms consent to being interviewed by selected District personnel and/or representatives and/or to submit additional written information. The District reserves the right to extend the Response Deadline and/or send out additional RFPs.

This RFP and any potential future RFP's associated with this solicitation, does not commit the District to award a contractual agreement to any vendor or to pay any costs incurred in the preparation of RFP Responses. The District reserves the right at its sole discretion to: (i) waive or correct any defect or informality in any response, (ii) withdraw this RFP, (iii) reissue this RFP, (iv) reject any and/or all RFP's, (v) prior to submission deadline for RFPs. Modify all or any portion of the selection procedures including deadlines for accepting responses, services to be provided under RFP, or the requirements for contents or format of the RFPs, (vi) waive irregularities, (vii) procure any services specified in this RFP by any other means, (viii) determine that no projects will be pursued and/or (ix) terminate or change the contracting process articulated in this RFP because of unforeseen circumstances.

The District shall not be responsible in any manner for the cost associated with preparing a response/proposal and/or participating in an interview. The RFP's, including all drawings, plans, photos, and narrative materials, shall become the property of the District upon the District's receipt of same. The District shall have the right to copy, reproduce, publicize and/or dispose of each RFP in any way that the District may choose. The District reserves the right to negotiate the terms and conditions of any agreement for services that may hereafter be let by the District. The proposals will be evaluated by an evaluation panel consisting of individuals selected by the District. Selection of this proposal will not preclude nor guarantee the selected firm consideration for future District projects.

8.0 District Schedule

The schedule currently anticipated by the District is shown in the Preliminary Schedule below. Please note that although the timeframes indicated below represent current expectations, they are approximate and subject to change.

Issue RFP for Services 5/13/19

Mandatory Project Walk Through
RFI Deadline

RFP Responses Due

5/24/19 @ 10:00 a.m.
5/28/19 by 10:00 a.m.
6/6/19 @ 10:00 a.m.

Review/Evaluate 6/10/19
Board of Trustees Approval 6/27/19
Commence Inspection Work 8/1/19

<u>Duration of Design Services (including CA services)</u>

Baration of Booign Cornece	thiolading of tools
Planning	TBD
Design	TBD
DSA Review and Approval	TBD
Bid and Award	TBD
Construction	TBD
Closeout	TBD

9.0 GENERAL

9.1 Responsible Charge

All licensed professionals in responsible charge of the work MUST be directly employed by responding Consultant and NOT employed as a sub-consultant.

9.2 District's Agreement

The Consultant, upon selection, will be required to enter into the District's Services Agreement ("Agreement"), provided as Exhibit D –Services Agreement for reference. Consultant shall be familiar with the District's indemnity clause and insurance requirements and must have the ability to secure insurance coverage and provide Certificated Proof of Insurance in conformance with the Agreement.

9.3 Compliance with all Applicable Laws

Consultants response must set forth Consultant's understanding of all applicable Health and Safety laws, guidelines, and requirements including Cal/OSHA Title 8, the EPA (Environmental Protection Agency), the Education Code, the Chancellor's Office, and DSA regulations (including the new Inspection Card requirements and PR 13-01), and local ordinances and/or other applicable zoning or planning ordinances/regulations, relative to the work to be undertaken as well as Consultant's ability to comply with the same and the methodology by which Consultant will do so. The proposal must confirm that the nature of the Work to be completed will meet all the aforementioned requirements for said Work as set by the applicable codes and regulations and all other applicable ordinances and guidelines.

9.4 Working Conditions

Each Consultant shall be capable of working indoors, in all weather and site conditions including, but not limited to, rain, dirt, mud, and ice. The Consultant's activities may require kneeling, bending, climbing ladders, and other similar physical activities.

9.5 Disabled Veteran Business Enterprise Participation Goals

The Mt. San Jacinto Community College District supports a participation goal of at least 3 percent (3%) of overall dollar amount expended each year to Disabled Veteran's Business Enterprises (DVBE). If Consultant is selected to provide services to the District, Consultant will be required to sign and return a Certification form (copy included with previous RFQ document) certifying that they will provide the District with information regarding the use of any DVBE contractors or consultants on the project. Information about DVBE resources can be found on the Executive Branch's website at http://www.dgs.ca.gov/default.htm or by calling the Office of Small Business and DVBE Certification at 916-375-4940. The DVBE documentation will be required if the Consultant is chosen to provided services as a result of an RFP process.

10.0 PROPOSAL STATEMENT

10.1 Firm Information

Provide a cover letter and introduction, including the company name, address, telephone number, and e-mail address of the person (s) authorized to represent the institution regarding all matters related to Consultant's proposal. A person authorized to bind the Firm to all commitments made in Consultant's proposal shall sign this letter.

10.2 Current Workload and Availability

State Consultant's ability to provide the required Inspection services in a timely manner, and indicate if those types of services are offered exclusively. Provide a list of current and anticipated commitments that involve any of the personnel (Project Team) that Consultant intends to assign to this project, and define the anticipated start and completion dates of the involvement of those personnel in such other projects.

10.3 Project Team and Sub-Consultants

Provide identification of Consultant's Project Team (including sub-consultants) and the District's main point of contact utilizing an organization chart. Identify the following key information for each team member: firm name, contact information, discipline, specific expertise, and experience in architectural and/or engineering services, especially as it relates to school sites/facilities and similar project types.

Utilize Exhibit A – Team Member Resume Form to provide additional detailed resumes of each team member, all of whom will be part of the designated team, thoroughly knowledgeable, regularly attentive, and fully available to work directly with the District.

Utilize Exhibit B – Team Member Experience Form to provide a minimum of five (5) relevant projects completed within the last five (5) years for EACH proposed team member (both for the prime Consultant as well as any sub-consultant). Prime consideration will be given to Consultants who propose team members with experience in community college projects of similar size, type, and difficulty, and which involve the same review and approval processes as those required by the DSA and other agencies having jurisdiction.

Any sub-consultants designated by the Consultant shall be subject to approval by the District in writing prior to performing any work on behalf of the Consultant. The District has the sole discretion to reject any sub-consultants proposed by the Consultant whether designated by Consultant in its RFP or not. Any replacement sub-consultants shall be subject to the District's prior written approval.

The members of the designated team shall not be charged unless agreed upon by the District. The District has the right to request additional sub-consultants in the future if those listed in this RFP are changed. All licensed professionals in responsible charge of the work MUST be directly employed by Consultant and NOT employed as a sub-consultant.

10.4 Billing Rates

Consultant shall propose an all-inclusive fixed fee for all the services described in this RFP. Consultant's proposed fee must include and account for all direct labor costs, fringe benefits, insurance, overhead, profit, and all other expenses the Consultant will incur in providing the required Inspection services.

Utilizing *Exhibit C – Billing Rate Form*, provide billing rates for all personnel and/or categories of employees (including sub-consultants) as well as any overhead or other special charges. If applicable, Consultant's RFP Response should include estimates for certain standardized components of the Inspection service process. All rates must include any escalation anticipated by Consultant during the entire duration of the *Service Agreement*. All other services not included herein shall be negotiable as required.

All proposed reimbursable expenses shall be directly related to the services required for the Project and must be supported by proper documentation and prior District authorization. Reimbursement shall not exceed cost plus 5%. Consultant shall review *Exhibit D –Service Agreement* for acceptable reimbursable items.

10.5 Services Agreement

Consultant shall review the District's *Service Agreement*, attached as *Exhibit D*, and shall note in its Proposal any suggested language revisions. Suggested language revisions <u>not</u> noted in Consultant's Proposal will <u>not</u> be considered by the District.

10.6 Evaluation

Proposals will be evaluated by an evaluation panel consisting of individuals selected by the District. At the District's discretion, some, one, or all of the responding firms may be requested to participate in an oral interview. The interview will be used as another opportunity to clarify any issues with a given proposal and explore the approaches that may be used to satisfy all the District's requirements. The District reserves the right to request that some or all of the responding firms consent to being interviewed by selected District personnel and/or representatives and/or to submit additional written information. The District reserves the right to extend the Response Deadline and/or send out additional RFPs.

This RFP and any potential future RFP's associated with this solicitation, does not commit the District to award a contractual agreement to any vendor or to pay any costs incurred in the preparation of RFP Responses. The District reserves the right at its sole discretion to: (i) waive or correct any defect or informality in any response, (ii) withdraw this RFP, (iii) reissue this RFP, (iv) reject any and/or all RFP's, (v) prior to submission deadline for RFPs. Modify all or any portion of the selection procedures including deadlines for accepting responses, services to be provided under RFP, or the requirements for contents or format of the RFPs, (vi) waive irregularities, (vii) procure any services specified in this RFP by any other means, (viii) determine that no projects will be pursued and/or (ix) terminate or change the contracting process articulated in this RFP because of unforeseen circumstances.

The District shall not be responsible in any manner for the cost associated with preparing a response/proposal and/or participating in an interview. The RFP's, including all drawings, plans, photos, and narrative materials, shall become the property of the District upon the District's receipt of same. The District shall have the right to copy, reproduce, publicize and/or dispose of each RFP in any way that the District may choose. The District reserves the right to negotiate the terms and conditions of any agreement for services that may hereafter be let by the District.

Exhibit A

Team Member Re	esume Form		
Proposed Consultant	t Name	Title	
Firm Name		Proposed Position	
Years w/Firm Education Specific to P	Years w/Previous Firm osition (School/Year/Degree/Sub	Years w/Community Colleges oject):	Availability
Other Training/Experie equivalent)	ence w/MSJCCD. DSA, Community	College Chancellors Office and other St	rate Agencies (or
Credentials/Certification and certifications, licenses,	ons/Licenses/Registrations/Accro , etc. that are expired or not from the st	editations (related to position and years tate of California.	s acquired): Note: Do not list
Skills Relevant to the P	roposed Project:		
List of Community Coll	ege Districts Consultant has work	red for:	

Team Membe	er Experience Fo	rm			
Provide a minimu Use multiple shee	um of five (relevant) a ets as necessary.	nd similar projects t	ypes completed w	ithin the last five	years.
Background					
Proposed Team N	vlember Name		Title		
Firm Name (at tir	ne of Project)				
Project Details					
Project Name			Client Distric	t	
Project Lead Nan	ne Title		Phone	E-M	lail
Address					
DSA PROJECT =	DSA CERTIFIED (Yes/No)	Project Scope (1)	School Type (2)	Project Start Date	Project Completion Date
Total Cost	= Change Orders	Cost of Change Orders	-		
Change Order No	otes Include descripti	on and reason:			
Team Member T	itle and Duties for th	is Project:			
responsibilities in commissioning req	Firms role, responsibilit detail, demonstration juirements of public sch lifornia building code re	n of how this projenced buildings in Califo	ect experience cor ornia and demonstra	ntributes to thor ation of how this p	ough knowledge of

- (1) Project Scope RE Renovation/Remodel/Repurpose, ADD Addition/Expansion, New New Construction, FIX Repair, PLAN Planning
- (2) School Type ES-Elementary School, MS-Middle School, KS-Kindergarten-8th Grade School, HS-High School, CCD-Community College, HE-Other College, NS-Non-school/Other

Exhibit C

Billing Rate Form		
Firm Name		
Billing Rates Do rates include travel charges? Note, all fees and rates must be		an acceptable reimbursable expense.
Job Title	Personnel Name	Hourly Rate
		+
Consultant's proposed ALL INCL	USIVE NOT-TO EXCEED FEE:	\$
Estimate of Reimbursable Exper	nses in the fee stated above:	\$
Authorized Signature		

CONSULTANT SERVICES AGREEMENT

This AGREEMENT is made and entered into this day of in the year 20 by and between the MT. SAN JACINTO COMMUNITY COLLEGE DISTRICT, hereinafter referred to as "DISTRICT," and, hereinafter referred to as "CONSULTANT." This AGREEMENT shall include all terms and conditions set forth herein. The DISTRICT and the CONSULTANT are sometimes referred to herein individually as a "PARTY" and collectively as the "PARTIES." This AGREEMENT is made with reference to the following facts:
WHEREAS, DISTRICT desires to obtain services for MATERIALS TESTING AND SPECIAL INSPECTION SERVICES AT TEMECULA VALLEY CAMPUS hereinafter collectively referred to as the "PROJECT"; and
WHEREAS , CONSULTANT is fully licensed to provide materials testing and special inspection services in conformity with the laws of the State of California;
NOW, THEREFORE, the PARTIES hereto agree as follows:
ARTICLE I SCOPE AND SERVICES AND RESPONSIBILITIES
1. <u>Services to be Provided by the CONSULTANT</u> . The CONSULTANT shall provide to the DISTRICT on the terms set forth herein all the services articulated in the CONSULTANT's proposal which is attached hereto and incorporated herein as EXHIBIT "A" (the "CONSULTANT's WORK PLAN") Where the CONSULTANT's WORK PLAN consists of a proposal or quote submitted in response to a Request for Proposals ("RFP") from the DISTRICT, the CONSULTANT's WORK PLAN shall be considered to include the DISTRICT's RFP. The DISTRICT and CONSULTANT expressly agree to incorporate the terms and conditions of the DISTRICT's RFP into this AGREEMENT by this reference and the PARTIES understand that the RFP shall constitute a binding part this AGREEMENT. In the even of a discrepancy, inconsistency, or other difference between the terms of the RFP or the CONSULTANT's WORK PLAN with this AGREEMENT, the PARTIES agree that the terms of this AGREEMENT shall govern and control.
2. <u>Classification</u> : To the extent it is determined under applicable law that CONSULTANT fails to meet the statutory prerequisites for classification as a professional expert operating under a personal services agreement, CONSULTANT resigns any and all rights and privileges derived from this AGREEMENT and any resulting relationship, which resignation is deemed accepted under such circumstances by the DISTRICT.
3. <u>Contract Term.</u> The effective period of this AGREEMENT is to bethrough
4. <u>CONSULTANT's Certifications, Representations and Warranties.</u> CONSULTANT makes the following certifications, representations, and warranties for the benefit of the DISTRICT and CONSULTANT acknowledges and agrees that the DISTRICT, in deciding to engage CONSULTANT pursuant to this AGREEMENT, is relying upon the truth and validity of the following certifications representations and warranties and their effectiveness throughout the term of this AGREEMENT and the course of CONSULTANT's engagement hereunder:

1

services contemplated by this AGREEMENT and, to the extent required by any applicable laws,

CONSULTANT is qualified in all respects to provide to the DISTRICT all of the

CONSULTANT has all such licenses and/or governmental approvals as would be required to carry out and perform for the benefit of the DISTRICT, such services as are called for hereunder.

- b. CONSULTANT, in providing the services and in otherwise carrying out its obligations to the DISTRICT under this AGREEMENT, shall, at all times, comply with all applicable federal, state, and local laws, rules, regulations, and ordinances, including workers' compensation and equal protection and non-discrimination laws.
- c. The CONSULTANT will perform its services hereunder in a professional manner, using the degree of care and skill ordinarily exercised by, and consistent with, the current professional practices and standards of a professional practicing in California. The CONSULTANT will furnish, at its expense, those services that are set forth in this AGREEMENT and **EXHIBIT** "A" and represents that the services set forth in said EXHIBIT are within the technical and professional areas of expertise of the CONSULTANT or any subconsultant the CONSULTANT has engaged or will engage to perform the service(s). The DISTRICT shall request in writing if the DISTRICT desires the CONSULTANT to provide services in addition to, or different from, the services described in **EXHIBIT** "A". The CONSULTANT shall advise the DISTRICT in writing of any services that, in the CONSULTANT's opinion, lie outside of the technical and professional expertise of the CONSULTANT.
- 5. CONSULTANT has been selected to perform the work herein because of the skills and expertise of key individuals. Services under this AGREEMENT shall be performed only by competent personnel under this supervision of and/or in the employment of the CONSULTANT. CONSULTANT shall conform to DISTRICT's reasonable requests regarding assignment of personnel. All personnel, including those assigned at DISTRICT's request, shall be supervised by CONSULTANT.
- by the DISTRICT, unless said personnel cease to be employed by CONSULTANT. In either case, DISTRICT shall be allowed to interview and approve replacement personnel. CONSULTANT agrees that reassignment of any of the listed personnel during the AGREEMENT period shall only be with other professional personnel who have equivalent experience and shall require prior consultation and written approval by the DISTRICT. Any costs associated with reassignment of personnel shall be borne exclusively by CONSULTANT and CONSULTANT shall not charge the DISTRICT for the cost of training or "bringing up to speed" replacement personnel. If any designated lead or key person fails to perform to the satisfaction of the DISTRICT, then upon written notice the CONSULTANT shall immediately remove that person from the PROJECT and provide a temporary replacement. CONSULTANT shall within thirty (30) work days, provide a permanent replacement person acceptable to the DISTRICT. DISTRICT may condition its approval of replacement personnel upon a reasonable transition period wherein new personnel will learn the PROJECT and get "up to speed" at CONSULTANT's cost.
- 7. CONSULTANT represents that the CONSULTANT has no existing interest and will not acquire any interest, direct or indirect, which would create a conflict of interest in violation of any applicable laws, and that no person having any such interest shall be employed by CONSULTANT.

ARTICLE II COMPENSATION TO THE CONSULTANT

- 1. The DISTRICT shall compensate the CONSULTANT as follows:
- a. The DISTRICT agrees to pay the CONSULTANT in accordance with the fee, rate and/or price schedule information set forth in **EXHIBIT "A"** for the services performed pursuant

to	this	AGREEMENT.	In	no	event	shall	the	total	payment	to	CONSULTANT	exceed
							DOI	LLAR	S (\$) for per	forming
the	e serv	ices required by th	is A	GRI	EEME	VT and	l EX	HIBI'	Г "А".		_	

- b. CONSULTANT shall invoice costs monthly, or another periodic basis approved by the DISTRICT, for the services provided pursuant to this AGREEMENT from the time the CONSULTANT begins work on the PROJECT. All costs must be supported by an invoice, receipt, or other acceptable documentation as determined by the DISTRICT.
- c. Except as expressly provided herein, CONSULTANT agrees that no other compensation, fringe benefits, or other remuneration is due to CONSULTANT by the DISTRICT for services rendered under this AGREEMENT. CONSULTANT shall not apply for or receive statutory benefits available to employees of the DISTRICT because CONSULTANT is not an employee of the DISTRICT; rather, CONSULTANT is operating under a personal services agreement pursuant to Education Code section 88003.1(b)(2) and has only the rights defined by this AGREEMENT.
- 2. The CONSULTANT shall submit one (1) invoice monthly to the DISTRICT for the fees incurred during the billing period and reimbursable expenses (if any). Invoices for fees must reflect the date of the service, identify the individual performing the service, state the hours worked and rate charged, and describe the service performed. Invoices requesting reimbursement for reimbursable expenses incurred during the billing period must clearly list items for which reimbursement is being requested and be accompanied by proper documentation (e.g. receipts, invoices) including a copy of the DISTRICT's authorization notice for invoiced item(s). Invoices requesting payment for overtime must reflect straight time and overtime hours being charged, and must include a copy of the DISTRICT's written authorization to incur additional overtime expense. No payments will be made by the DISTRICT to the CONSULTANT for monthly invoices requesting reimbursable expenses or overtime absent the prior written authorization of the DISTRICT. The DISTRICT shall make payment to the CONSULTANT of the approved invoiced amount within forty-five (45) days of the DISTRICT's receipt of the approved invoice.
- 3. The DISTRICT may withhold, or on account of subsequently discovered evidence, nullify the whole or a part of any payment to such extent as may be necessary to protect the DISTRICT from loss, including costs and attorneys' fees, on account of: (1) defective or deficient work product not remedied; (2) failure of the CONSULTANT to make payments properly to its employees or subconsultants; or (3) failure of CONSULTANT to perform its services in a timely manner so as to conform to the PROJECT schedule or other time constraints.

ARTICLE III REIMBURSABLE EXPENSES

- 1. Reimbursable expenses are in addition to compensation for basic and extra services, and shall be paid to the CONSULTANT at one and one-tenth (1.1) times the expenses incurred by the CONSULTANT, the CONSULTANT's employees and consultants for the following specified items unless otherwise approved by the DISTRICT in writing:
 - a. Approved reproduction of reports and/or other documents otherwise not covered in this AGREEMENT and approved in advance by DISTRICT.
 - b. Fees advanced for securing approval of authorities in connection with the services rendered pursuant to this AGREEMENT.

EXHIBIT "D" - Page 4 of 11

- c. Express shipping, overnight mail, messenger, courier, or delivery services approved in advance by the DISTRICT.
- d. Mileage at IRS Rate if site exceeds more than 25 miles from the DISTRICT.
- e. Out of town travel approved in advance by DISTRICT.

2.	Reimbursable expe	enses are estim	ated to be _				DOL	LARS
(\$), and this amo	unt shall not b	e exceeded	without 1	the prior	written	approval	of the
DISTRICT.								

ARTICLE IV TERMINATION

- 1. This AGREEMENT may be terminated by either PARTY upon fourteen (14) days written notice to the other PARTY in the event of a substantial failure of performance by such other PARTY, including insolvency of CONSULTANT; or if the DISTRICT should decide to abandon or indefinitely postpone the PROJECT.
- 2. In the event of a termination based upon abandonment or postponement by DISTRICT, the DISTRICT shall pay to the CONSULTANT for all services performed and all expenses incurred under this AGREEMENT supported by documentary evidence, including payroll records, and expense reports up until the date of the abandonment or postponement plus any sums due the CONSULTANT for Board approved extra services. In ascertaining the services actually rendered hereunder up to the date of termination of this AGREEMENT, consideration shall be given to both completed work and work in process of completion and to complete and incomplete drawings and other documents whether delivered to the DISTRICT or in the possession of the CONSULTANT. In the event termination is for a substantial failure of performance, all damages and costs associated with the termination, including increased consultant and replacement consultant costs shall be deducted from payments to the CONSULTANT.
- 3. In the event a termination for cause is determined to have been made wrongfully or without cause, then the termination shall be treated as a termination for convenience in accordance with Article IV, Paragraph 4 below, and CONSULTANT shall have no greater rights than it would have had if a termination for convenience had been effected in the first instance. No other loss, cost, damage, expense or liability may be claimed, requested or recovered by CONSULTANT.
- 4. This AGREEMENT may be terminated without cause by DISTRICT upon twenty (20) days written notice to the CONSULTANT. In the event of a termination without cause, the DISTRICT shall pay to the CONSULTANT for all services performed and all expenses incurred under this AGREEMENT supported by documentary evidence, including payroll records, and expense reports up until the date of notice of termination plus any sums due the CONSULTANT for Board approved extra services. In ascertaining the services actually rendered hereunder up to the date of termination of this AGREEMENT, consideration shall be given to both completed work and work in process of completion and to other documents whether delivered to the DISTRICT or in the possession of the CONSULTANT.
- 5. In the event of a dispute between the PARTIES as to performance of the work or the interpretation of this AGREEMENT, or payment or nonpayment for work performed or not performed, the PARTIES shall attempt to resolve the dispute. Pending resolution of this dispute, CONSULTANT agrees to continue the work diligently to completion. If the dispute is not resolved, CONSULTANT agrees it will neither rescind the AGREEMENT nor stop the progress of the work, but CONSULTANT's sole remedy shall be to submit such controversy to determination by a court having competent jurisdiction of the dispute,

after the PROJECT has been completed, and not before. The PARTIES may agree in writing to submit any dispute between the PARTIES to arbitration. The DISTRICT agrees to pay the CONSULTANT the undisputed amounts due under this AGREEMENT.

6. The PARTIES understand and agree that Article IV of this AGREEMENT shall govern all termination rights and procedures between the PARTIES. Any termination provision that is attached to this AGREEMENT as an Exhibit shall be void and unenforceable between the PARTIES.

ARTICLE V ADDITIONAL CONSULTANT SERVICES

- 1. CONSULTANT shall notify the DISTRICT in writing of the need for additional services required due to circumstances beyond the CONSULTANT's control. CONSULTANT shall obtain written authorization from the DISTRICT before rendering such services. The DISTRICT may require CONSULTANT to perform additional services which are, in the DISTRICT's discretion, necessary. Compensation for such services shall be negotiated and approved in writing by the DISTRICT. Such services shall include:
 - a. Making material revisions in reports or other documents when such revisions are required by the enactment or revision of laws, rules or regulations subsequent to the preparation and completion of such documents.
 - b. Preparing reports and other documentation and supporting data, and providing other services in connection with PROJECT modifications required by causes beyond the control of the CONSULTANT which are not the result of the direct or indirect negligence, errors or omissions on the part of CONSULTANT;
 - c. If the DISTRICT requests additional shifts to complete the services articulated in **EXHIBIT "A"** where the requests for additional shifts does not arise from the direct or indirect negligence, errors or omissions on the part of CONSULTANT and the CONSULTANT's compensation is expressly conditioned on the lack of fault of the CONSULTANT;
 - d. Providing any other services not otherwise included in this AGREEMENT or not customarily furnished in accordance with the generally accepted practice in the CONSULTANT's industry.

ARTICLE VI ACCOUNTING RECORDS OF THE CONSULTANT

1. Records of the CONSULTANT's direct personnel and reimbursable expenses pertaining to any extra services provided by the CONSULTANT, which are in addition to those services already required by this AGREEMENT, and any records of accounts between the DISTRICT and CONSULTANT shall be kept on a generally recognized accounting basis and shall be available to the DISTRICT or DISTRICT's authorized representative at mutually convenient times.

ARTICLE VII REPORTS AND/OR OTHER DOCUMENTS

1. The reports and/or other documents that are prepared, reproduced, maintained and/or managed by the CONSULTANT or CONSULTANT's consultants in accordance with this AGREEMENT (regardless of medium, format, etc.) shall be and remain the property of the DISTRICT (hereinafter "PROPERTY"). The DISTRICT may provide the CONSULTANT with a written request for the return of its PROPERTY at any time. Upon CONSULTANT's receipt of the DISTRICT's written request, CONSULTANT shall return the requested PROPERTY to the DISTRICT within five (5) calendar days. Failure to comply with any such written request shall be deemed a material breach of this AGREEMENT.

ARTICLE VIII INDEMNITY & INSURANCE

- 1. To the fullest extent permitted by law, CONSULTANT agrees to indemnify, and hold DISTRICT entirely harmless from all liability arising out of:
 - a. <u>Workers' Compensation and Employers Liability</u>: Any and all claims under Workers' Compensation acts and other employee benefit acts with respect to CONSULTANT's employees or CONSULTANT's subconsultant's employees arising out of CONSULTANT's work under this AGREEMENT; and
 - b. <u>General Liability</u>: Liability for damages for (1) death or bodily injury to person; (2) injury to, loss or theft of property; (3) any failure or alleged failure to comply with any provision of law or (4) any other loss, damage or expense arising under either (1), (2), or (3) above, sustained by the CONSULTANT or the DISTRICT, or any person, firm or corporation employed by the CONSULTANT or the DISTRICT upon or in connection with the PROJECT, except for liability resulting from the sole or active negligence, or willful misconduct of the DISTRICT, its officers, employees, agents or independent consultants who are directly employed by the DISTRICT;
 - c. <u>Professional Liability</u>: Any loss, injury to or death of persons or damage to property caused by any act, neglect, default or omission of the CONSULTANT, or any person, firm or corporation employed by the CONSULTANT, either directly or by independent contract, including all damages due to loss or theft, sustained by any person, firm or corporation including the DISTRICT, arising out of, or in any way connected with the services performed by CONSULTANT in accordance with this AGREEMENT, including injury or damage either on or off DISTRICT property; but not for any loss, injury, death or damages caused by the sole or active negligence, or willful misconduct of the DISTRICT.
 - d. The CONSULTANT, at its own expense, cost, and risk, shall defend any and all claims, actions, suits, or other proceedings, arising out of Article VIII, Paragraphs 1 (a) and (b) above, that may be brought or instituted against the DISTRICT, its officers, agents or employees, on any such claim or liability, and shall pay or satisfy any judgment that may be rendered against the DISTRICT, its officers, agents or employees in any action, suit or other proceedings as a result thereof.
 - e. The PARTIES understand and agree that Article VIII, Section 1 of this AGREEMENT shall be the sole indemnity, as defined by California Civil Code §2772, governing this AGREEMENT. Any other indemnity that is attached to this AGREEMENT as an Exhibit shall be void and unenforceable between the PARTIES.

- f. Any attempt to limit the CONSULTANT's liability to the DISTRICT in an attached Exhibit shall be void and unenforceable between the PARTIES. In no event shall the CONSULTANT's liability be limited to any amount including, but not limited to, the amount of fees received by the CONSULTANT for performing services related to this AGREEMENT.
- 2. CONSULTANT shall purchase and maintain policies of insurance with an insurer or insurers, qualified to do business in the State of California and acceptable to DISTRICT which will protect CONSULTANT and DISTRICT from claims which may arise out of or result from CONSULTANT's actions or inactions relating to the AGREEMENT, whether such actions or inactions be by themselves or by any subconsultant or by anyone directly or indirectly employed by any of them, or by anyone for whose acts any of them may be liable. The aforementioned insurance shall include coverage for:
 - a. The CONSULTANT shall carry Workers' Compensation and Employers Liability Insurance in accordance with the laws of the State of California. However, such amount shall not be less than ONE MILLION DOLLARS (\$1,000,000).
 - b. Comprehensive general and auto liability insurance with limits of not less than ONE MILLION DOLLARS (\$1,000,000) combined single limit, bodily injury and property damage liability per occurrence, including:
 - 1. Owned, non-owned and hired vehicles;
 - 2. Blanket contractual;
 - 3. Broad form property damage;
 - 4. Products/completed operations; and
 - 5. Personal injury.
 - c. Professional liability insurance, including contractual liability, with limits of ONE MILLION DOLLARS (\$1,000,000), per claim. Such insurance shall be maintained during the term of this AGREEMENT and renewed for a period of at least five (5) years thereafter and/or at rates consistent with the time of execution of this AGREEMENT adjusted for inflation. In the event that CONSULTANT subcontracts any portion of CONSULTANT's duties, CONSULTANT shall require any such subconsultant to purchase and maintain insurance coverage as provided in this subparagraph. Failure to maintain professional liability insurance is a material breach of this AGREEMENT and grounds for immediate termination.
 - d. Each policy of insurance required in Article VIII, Section 2 (b) above shall name DISTRICT and its officers, agents and employees as additional insureds; shall state that, with respect to the operations of CONSULTANT hereunder, such policy is primary and any insurance carried by DISTRICT is excess and non-contributory with such primary insurance; shall state that not less than thirty (30) days written notice shall be given to DISTRICT prior to cancellation; and, shall waive all rights of subrogation. CONSULTANT shall notify DISTRICT in the event of material change in, or failure to renew, each policy. Prior to commencing work, CONSULTANT shall deliver to DISTRICT certificates of insurance as evidence of compliance with the requirements herein. In the event CONSULTANT fails to secure or maintain any policy of insurance required hereby, DISTRICT may, at its sole discretion, secure such policy of insurance in the name of and for the account of CONSULTANT, and in such event CONSULTANT shall reimburse DISTRICT upon demand for the cost thereof.

ARTICLE IX MISCELLANEOUS

- 1. CONSULTANT, in the performance of this AGREEMENT, shall be and act as an independent contractor. CONSULTANT understands and agrees that CONSULTANT and all of CONSULTANT's employees shall not be considered officers, employees or agents of the DISTRICT, and are not entitled to benefits of any kind or nature normally provided employees of the DISTRICT and/or to which DISTRICT's employees are normally entitled, including, but not limited to, State Unemployment Compensation or Workers' Compensation. CONSULTANT assumes the full responsibility for the acts and/or omissions of CONSULTANT's employees or agents as they relate to the services to be provided under this AGREEMENT. CONSULTANT shall assume full responsibility for payment of any applicable prevailing wages and all federal, state and local taxes or contributions, including unemployment insurance, social security and income taxes for the respective CONSULTANT's employees.
- 2. Nothing contained in this AGREEMENT shall create a contractual relationship with or a cause of action in favor of any third party against either the DISTRICT or CONSULTANT.
- 3. The DISTRICT and CONSULTANT, respectively, bind themselves, their partners, officers, successors, assigns and legal representatives to the other PARTY to this AGREEMENT with respect to the terms of this AGREEMENT. CONSULTANT shall not assign this AGREEMENT.
 - 4. This AGREEMENT shall be governed by the laws of the State of California.
- 5. This AGREEMENT shall not include or incorporate the terms of any general conditions, conditions, master agreement or any other boilerplate terms or form documents prepared by the CONSULTANT. The attachment of any such document to this AGREEMENT as **EXHIBIT** "A" shall not be interpreted or construed to incorporate such terms into this AGREEMENT unless the DISTRICT approves of such incorporation in a separate writing signed by the DISTRICT. Any reference to such boilerplate terms and conditions in the proposal or quote submitted by the CONSULTANT shall be null and void and have no effect upon this AGREEMENT. Proposals, quotes, statement of qualifications and other similar documents prepared by the CONSULTANT may be incorporated into this AGREEMENT as **EXHIBIT** "A" but such incorporation shall be strictly limited to those portions describing the CONSULTANT's scope of work, rate and price schedule and qualifications.
- 6. The PARTIES have had the opportunity to, and have to the extent each deemed appropriate, obtained legal counsel concerning the content and meaning of this AGREEMENT. Each of the PARTIES agrees and represents that no promise, inducement or agreement not herein expressed has been made to effectuate this AGREEMENT. This AGREEMENT represents the entire AGREEMENT between the DISTRICT and CONSULTANT and supersedes all prior negotiations, representations or agreements, either written or oral. This AGREEMENT may be amended or modified only by an agreement in writing signed by both the DISTRICT and the CONSULTANT.
- 7. The rule of construction that any ambiguities are to be resolved against the drafting PARTY shall not be employed in the interpretation of this AGREEMENT. It is expressly understood and agreed that the PARTIES to this AGREEMENT have participated equally, or have had equal opportunity to participate, in the drafting hereof.
 - 8. Time is of the essence with respect to all provisions of this AGREEMENT.

- 9. If either PARTY becomes involved in litigation arising out of this AGREEMENT or the performance thereof, each PARTY shall bear its own litigation costs and expenses, including reasonable attorney's fees.
- 10. All exhibits referenced herein and attached hereto shall be deemed incorporated into and made a part of this AGREEMENT by each reference as though fully set forth in each instance in the text hereof unless otherwise excluded by the terms of this AGREEMENT. In the event that the provisions of any exhibit conflict with the terms of this AGREEMENT, the terms of this AGREEMENT shall control.
- 11. This AGREEMENT may be executed in any number of counterparts, each of which shall be deemed an original, and the counterparts shall constitute one and the same instrument, all of which shall be sufficient evidence of this AGREEMENT.
- 12. Confidentiality. The CONSULTANT shall not disclose or permit the disclosure of any confidential information, except to its agents, employees and other consultants who need such confidential information in order to properly perform their duties relative to this AGREEMENT.
- 13. Severability. If any portion of this AGREEMENT is held as a matter of law to be unenforceable, the remainder of this AGREEMENT shall be enforceable without such provisions.
- 14. Notices. All notices or demands to be given under this AGREEMENT by either PARTY to the other shall be in writing and given either by: (a) personal service; or (b) by U.S. Mail, mailed either by registered, overnight, or certified mail, return receipt requested, with postage prepaid. Service shall be considered given when received if personally served or if mailed on the fifth day after deposit in any U.S. Post Office. The address to which notices or demands may be given by either PARTY may be changed by written notice given in accordance with the notice provisions of this Paragraph. At the date of this AGREEMENT, the addresses of the PARTIES are as follows:

To the DISTRICT:

Mt. San Jacinto Community College District

Attn: Beth Gomez 1499 N. State Street San Jacinto, CA 92583

Telephone: 951-487-3013

To the CONSULTANT:

<<Name of Contractor>>

Attn: <<Name>>

<< Address>>

<<City, State, Zip>>

Telephone:

Email:

- 15. Tobacco Prohibited. Any tobacco use (smoking, chewing, etc.) by anyone, is prohibited at all times on any DISTRICT property.
- 16. Profanity on any DISTRICT property is prohibited, including, but not limited to, racial, ethic, or sexual slurs or comments which could be considered harassment.
- 17. Appropriate dress is mandatory. Therefore, tank tops, cut-offs and shorts are not allowed. Additionally, what is written or pictured on clothing must comply with the requirements of acceptable language as stated above in Paragraph 16.
- 18. Images. If applicable, the CONSULTANT is prohibited from capturing on any visual medium images of any property, logo, student, or employee of the DISTRICT, or any image that represents the DISTRICT without express written consent from the DISTRICT.

EXHIBIT "D" - Page 10 of 11


- 19. Prevailing Wages. If applicable and required, CONSULTANT shall pay, and shall cause all subconsultants of every tier to pay, not less than the specified prevailing wage rates, to the extent applicable, to all workers employed to perform work or services under this AGREEMENT. CONSULTANT shall fully indemnify and defend the DISTRICT from any claims arising from CONSULTANT's failure to meet and prevailing wage requirements.
- 20. In accordance with California Education Code section 81655, this AGREEMENT is not a valid or enforceable obligation against the DISTRICT until approved or ratified by motion of the Governing Board of the DISTRICT duly passed and adopted.


The PARTIES, through their authorized representatives, have executed this AGREEMENT as of the day and year first written above.

< <name consultant="" of="">></name>	MT. SAN JACINTO COMMUNITY COLLEG DISTRICT
Ву	By
Print Name	Beth Gomez
Title	Vice President, Business Services
Date	Date
Address	
Phone_	
Fax	
Tax ID#	
Email	

EXHIBIT "D" - Page 11 of 11

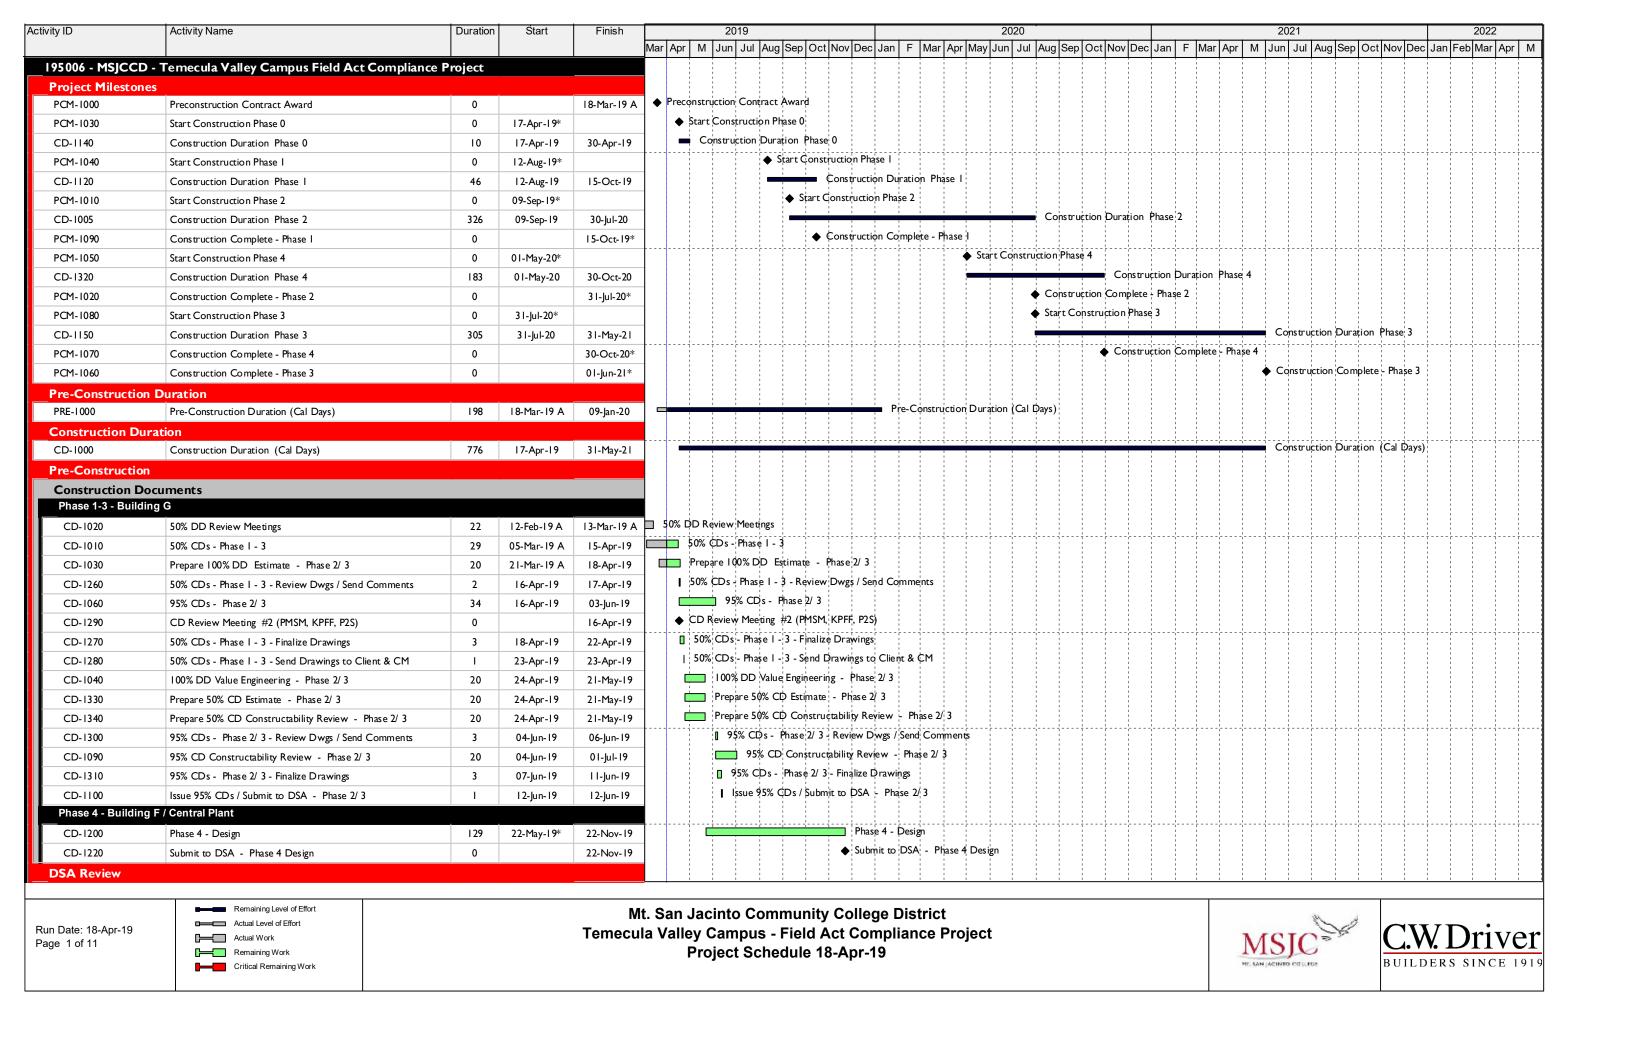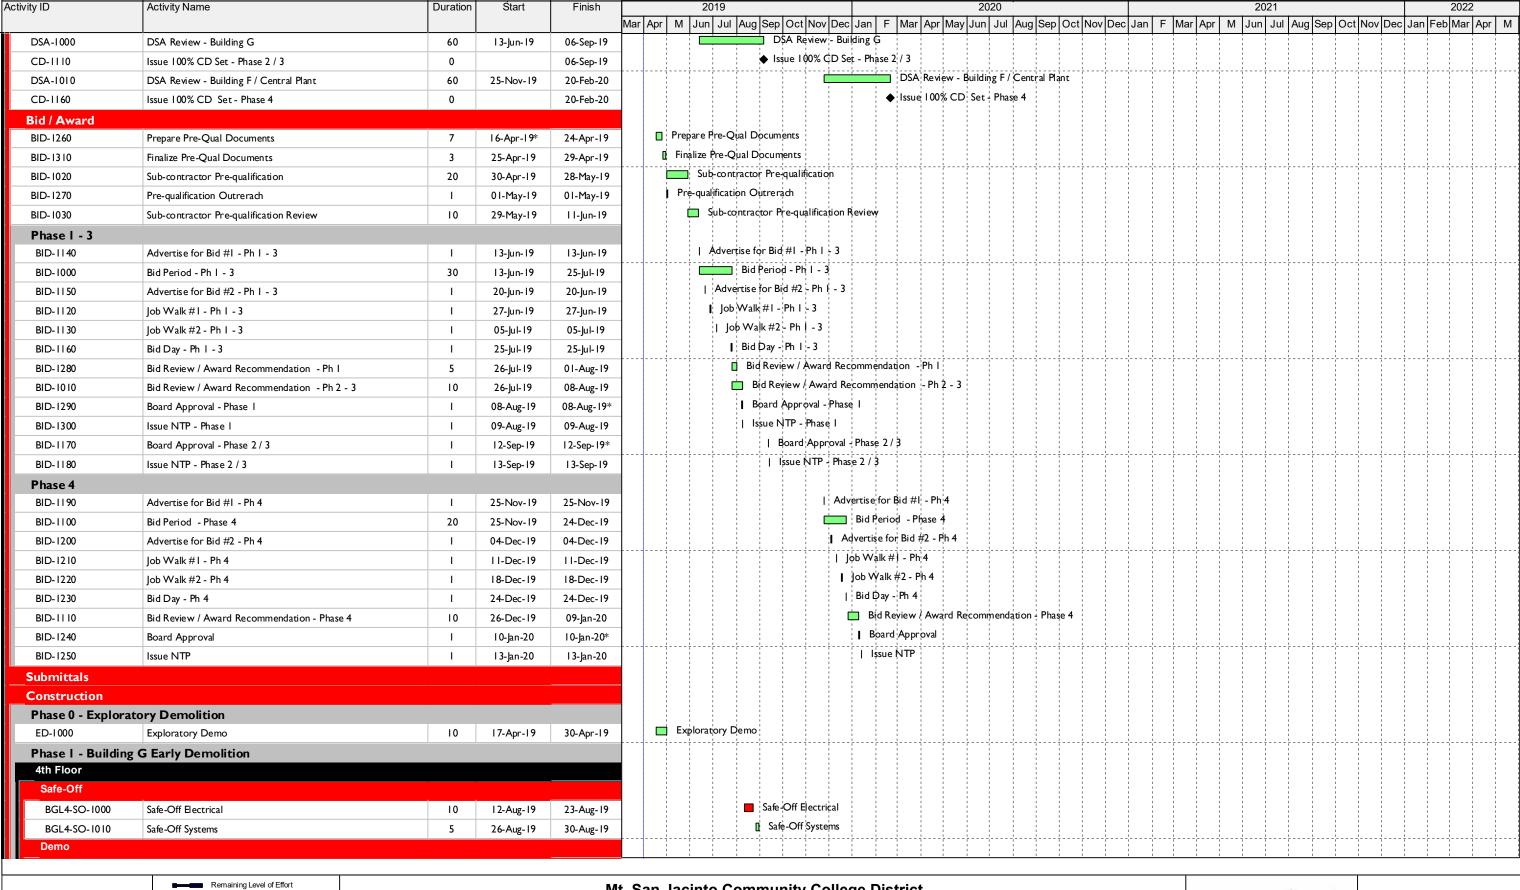CONSULTANT 'S WORK PLAN, SCOPE OF SERVICES, AND COMPENSATION





Run Date: 18-Apr-19 Page 2 of 11 Actual Level of Effort

Actual Work

Remaining Work

Critical Remaining Work





Activity ID	Activity Name	Duration	Start	Finish	2019	2020 2021 2022
					Mar Apr M Jun Jul	Aug Sep Oct Nov Dec Jan F Mar Apr May Jun Jul Aug Sep Oct Nov Dec Jan F Mar Apr May Jun Jul Aug Sep Oct Nov Dec Jan F Mar Apr M Jun Jul Aug Sep Oct Nov Dec Jan Feb Mar Apr I
BGL4-DEMO-1000	Demo Walls	7	26-Aug-19	04-Sep-19		□ Demo Walls
BGL4-DEMO-1010	Demo Ceilings	7	03-Sep-19	I I-Sep-19		■ Demo Ceilings
BGL4-DEMO-1020	Demo & Removel HVAC	7	10-Sep-19	18-Sep-19		■ Demo & Removel HVAC
BGL4-DEMO-1030	Fire Sprinkler Removal	7	19-Sep-19	27-Sep-19		■ Fire Sprinkler Removal
BGL4-DEMO-1040	Fireproofing Removal	7	30-Sep-19	08-Oct-19		☐ Fireproofing Removal
BGL4-DEMO-1050	4th Floor Ready for Seismic Upgrades	0		08-Oct-19		♦ 4th Floor Ready for Seismic Upgrades
5th Floor						
Safe-Off						
BGL5-SO-1000	Safe-Off Electrical	10	26-Aug-19	09-Sep-19		□ Safe-Off Electrica
BGL5-SO-1010	Safe-Off Systems	5	10-Sep-19	16-Sep-19		□ \$afe-Off Systems
Demo						
BGL5-DEMO-1000	Demo Walls	7	17-Sep-19	25-Sep-19		□ Demo Walls
BGL5-DEMO-1010	Demo Ceilings	7	24-Sep-19	02-Oct-19		□ Demo Çeilings
BGL5-DEMO-1020	Demo & Removel HVAC	7	01-Oct-19	09-Oct-19		□ Demo & Removel HVAC
BGL5-DEMO-1030	Fire Sprinkler Removal	7	10-Oct-19	18-Oct-19		☐ Fire Sprinkler Removal
BGL5-DEMO-1040	Fireproofing Removal	7	21-Oct-19	29-Oct-19		☐ Fireproofing Removal
BGL5-DEMO-1050	5th Floor Ready for Seismic Upgrades	0		29-Oct-19		♦ 5th Floor Ready for Seismic Upgrades
1st Floor						
Safe-Off						
BGL1-SO-1000	Safe-Off Electrical	7	10-Sep-19	18-Sep-19		□ Safe-Off Electrical
BGL1-SO-1010	Safe-Off Systems	5	19-Sep-19	25-Sep-19		□ Safe-Off Systems
Demo						
BGL1-DEMO-1000	Demo Walls	7	19-Sep-19	27-Sep-19		□ Demo Walls
BGL1-DEMO-1010	Demo Ceilings	7	26-Sep-19	04-Oct-19		📋 Demo Çeilings
BGL1-DEMO-1020	Demo & Removel HVAC	7	03-Oct-19	11-Oct-19		☐ Demo'& Removel HVAC
BGL1-DEMO-1030	Fire Sprinkler Removal	7	14-Oct-19	22-Oct-19		☐ Fire Sprinkler Removal
BGL1-DEMO-1040	Fireproofing Removal	7	23-Oct-19	31-Oct-19		☐ Fireproofing Removal
SOG				,		
BG-SOG-ED-1000	Sawcut / Remove Floors	20	01-Nov-19	03-Dec-19		Sawcut / Remove Floors ♦ I st Floor Ready for Seismic Upgrades
BGL1-DEMO-1050	1st Floor Ready for Seismic Upgrades	0		03-Dec-19		♦ 1st Floor Ready for Seismic Upgrades
3rd Floor						
Safe-Off						
BGL3-SO-1000	Safe-Off Electrical	10	10-Sep-19	23-Sep-19		□ Safe-Off Electrical
BGL3-SO-1010	Safe-Off Systems	5	26-Sep-19	02-Oct-19		□ Safe-Off Systems
Demo						
BGL3-DEMO-1000	Demo Walls	7	24-Sep-19	02-Oct-19		□ Demo Walls
BGL3-DEMO-1010	Demo Ceilings	7	01-Oct-19	09-Oct-19		□ Demo Ceilings
BGL3-DEMO-1020	Demo & Removel HVAC	7	08-Oct-19	16-Oct-19		□ Demo & Removel HVAC
BGL3-DEMO-1030	Fire Sprinkler Removal	7	17-Oct-19	25-Oct-19	ļļ	☐ Fire Sprinkler Removal
BGL3-DEMO-1040	Fireproofing Removal	7	28-Oct-19	05-Nov-19		☐ Fireproofing Removal
BGL3-DEMO-1050	3rd Floor Ready for Seismic Upgrades	0		05-Nov-19		♦ 3rd Floor Ready for Seismic Upgrades
2nd Floor						
Safe-Off —						
		Т				
	Remaining Level of Effort			R/I	t Can Inginto Co	ammunity College District

Run Date: 18-Apr-19 Page 3 of 11 Remaining Level of Effort

Actual Level of Effort

Actual Work

Remaining Work

Critical Remaining Work





Stivity ID	Activity Name	Duration	Start	FILISH	NATURAL NATIONAL CONTRACTOR AND CONT	au Daa Jan E laa da laa	2020	بادعا دياي	IDeal III	_ N4::: A	Z0Z			D	202	
BGL2-SO-1000	Safa Off Floatrical	10	24 50- 10	07.0-+ 10	Mar Apr M Jun Jul Aug Sep Oct I	ov Dec Jan F Mar Apr M -Off Electrical	iay Jun Jul Aug	Sep Oct No	/ Dec Jan	F Mar Apr	M Jun C	ul Aug Se	poctN	ov Dec Ja	in Feb Mar	Apr M
BGL2-SO-1000 BGL2-SO-1010	Safe-Off Electrical Safe-Off Systems	5	24-Sep-19 08-Oct-19	07-Oct-19	<u> </u>	e-Off Systems										1 1
Demo	Sale-Off Systems	3	08-Oct-19	14-Oct-19		Sin Systems										
BGL2-DEMO-1000	Demo Walls	7	08-Oct-19	16-Oct-19		mo Walls										
BGL2-DEMO-1010	Demo Ceilings	7	15-Oct-19	23-Oct-19		emo Ceilings										
BGL2-DEMO-1020	Demo & Removel HVAC	7	22-Oct-19	30-Oct-19		Demo & Removel HVAC										
BGL2-DEMO-1030	Fire Sprinkler Removal	7	31-Oct-19	08-Nov-19	.	Fire Sprinkler Removal										
BGL2-DEMO-1040	Fireproofing Removal	7	11-Nov-19	20-Nov-19		Fireproofing Removal										
BGL2-DEMO-1050	2nd Floor Ready for Seismic Upgrades	0	11110717	20-Nov-19	-	◆ 2nd Floor Ready for Seismic	Upgrades									
Stair 5 Demo	, , , , , , , , , , , , , , , , , , , ,															
Demo		,		-												
BGS5-Demo-1000	Level 5 Deck Demo & Safety Rail Install	5	03-Oct-19	09-Oct-19	. J□ Le	el 5 Deck Demo & Safety Rail In	stal	 			 -					i i
BGS5-Demo-1010	Level 4 Deck Demo & Safety Rail Install	5	10-Oct-19	16-Oct-19	1	vel 4 Deck Demo & Safety Rail I	nstall									
BGS5-Demo-1020	Level 3 Deck Demo & Safety Rail Install	5	17-Oct-19	23-Oct-19	1	evel 3 Deck Demo & Safety Rail	Install									
BGS5-Demo-1030	Level 2 Deck Demo & Safety Rail Install	5	24-Oct-19	30-Oct-19		Level 2 Deck Demo & Safety Ra	il Install									
BGS5-Demo-1040	SOG Demo & Safe-Off	5	31-Oct-19	06-Nov-19		SOG Demo & Safe-Off										
BGS5-Demo-1050	Stair 5 Ready for Seismic Upgrades	0		06-Nov-19		Stair 5 Ready for Seismic Upgra	ades		-,,							1 1
Exterior		,														
Demo																
BGExt-Demo-1000	Set Scaffolding GL 24	7	19-Sep-19	27-Sep-19		affolding GL 24										
BGExt-Demo-1010	Remove Formawall Panels & Store GL 24	10	30-Sep-19	I I-Oct-19		nove Formawall Panels & Store	i i i				<u> </u>					
BGExt-Demo-1020	Remove Curtain Wall & Store Stair 4	7	14-Oct-19	22-Oct-19		emove Curtain Wall & Store \$ta	1 1 1									
BGExt-Demo-1030	Remove Curtain Wall & Store Stair 3	7	23-Oct-19	31-Oct-19		Remove Curtain Wall & Store S	i i i									
BGExt-Demo-1040	Remove Curtain Wall & Store GL D	7	01-Nov-19	11-Nov-19		Remove Curtain Wall & Store	i i i									
BGExt-Demo-1050	Remove Glass Doors Main Lobby	5	12-Nov-19	19-Nov-19		Remove Glass Doors Main L	obby									
Roof											<u> </u>					<u> </u>
Demo	1															
BGRoof-Demo	Roof Demo	30	30-Sep-19	08-Nov-19	J	Roof Demo										
	eismic Upgrades, Sitework & Floors I, 4 8	k 5 Build Out														
Seismis Upgrades																
4th Floor Structural Steel								· 			 -					
	Seed Delivery			00 0-: 10	▲ C+c	l Delivery										
BGL4-SSU-1000 BGL4-SSU-1010	Steel Delivery	0	09 0-+ 10	08-Oct-19 05-Nov-19	4 1 1 1 1 1	Steel Strengthening										
BGL4-SSU-1010 BGL4-SSU-1020	Steel Strengthening Erect Beams	10	09-Oct-19 06-Nov-19	20-Nov-19		Erect Beams										
BGL4-SSU-1020 BGL4-SSU-1030	Fireproffing	7	21-Nov-19	03-Dec-19	1	Fireproffing										
5th Floor	ттерголице	,	∠ 1-1 NUV=1 /	03-Dec-17	·											
Structural Steel																
BGL5-SSU-1000	Steel Delivery	0		05-Nov-19		Steel Delivery										
BGL5-SSU-1010	Steel Strengthening	20	06-Nov-19	06-Dec-19		Steel Strengthening										
BGL5-SSU-1020	Erect Beams Roof	7	06-Dec-19	16-Dec-19		■ Erect Beams Roof										1 1
BGL5-SSU-1030	Fireproffing	7	17-Dec-19	26-Dec-19		Fireproffing										1
1st Floor																
					_	1 1 1 1 1	1 1 1	1 1 1	1 1 1	1 1	1 1 1	1 1	1 1		1 1	1 1
	Remaining Level of Effort			М	t. San Jacinto Community	College District						As .				_
Run Date: 18-Apr-19	Actual Level of Effort				la Valloy Campus - Fiold A		ot					The second	3	~~~	D .:	T 7 0 44

Actual Work Page 4 of 11 Remaining Work Critical Remaining Work Temecula Valley Campus - Field Act Compliance Project Project Schedule 18-Apr-19





ty ID	Activity Name	Duration	Start	Finish	2019 2020 2021
					Mar Apr M Jun Jul Aug Sep Oct Nov Dec Jan F Mar Apr May Jun Jul Aug Sep Oct Nov Dec Jan F Mar Apr May Jun Jul Aug Sep Oct Nov Dec Jan F Mar Apr M Jun Jul Aug Sep Oct Nov Dec Jan Fet
Structural Steel	,				
BGL1-SSU-1000	Steel Delivery	0		06-Dec-19	◆ Steel Delivery
BGL1-SSU-1010	Steel Strengthening	30	09-Dec-19	21-Jan-20	Steel Strengthening
BGL1-SSU-1030	Fireproffing	7	22-Jan-20	30-Jan-20	Fireproffing
Strengthening Foot	ings				
SOG					
BGL1-FOUND-1000	Steel Delivery	0		03-Dec-19	♦ Steel Delivery
BGL1-FOUND-1010	Install Dowels	30	04-Dec-19	I 6-Jan-20	Install Dowels
BGL1-FOUND-1020	Install Rebar	20	l 7-Jan-20	I 3-Feb-20	Install Rebar
BGL1-FOUND-1030	Pour Footings	10	I 4-Feb-20	27-Feb-20	Pour Footings
Stair 5	'				
BG-Stair5-1000	Stair Delivery	0		06-Dec-19	◆ Stair Delivery
BG-Stair5-1010	Install Stairs	20	09-Dec-19	07-Jan-20	Inștall \$tairs
BG-Stair5-1020	Install Mesh	3	08-Jan-20	I 0-Jan-20	[] Install Mesh
BG-Stair5-1030	Pour Stairs	3	I 3-Jan-20	15-Jan-20	Pour Stairs
Stair 6	! 		-		
BG-Stair6-1000	Stair Delivery	0		06-Dec-19	◆ Stair Delivery
BG-Stair6-1010	Install Stairs	10	08-Jan-20	21-Jan-20	Install Stairs
BG-Stair6-1020	Install Mesh	3	22-Jan-20	24-Jan-20	[] Install Mesh
BG-Stair6-1030	Pour Stairs	3	27-Jan-20	29-Jan-20	Il Pour Stairs
Roof			, ,	, , ,	
BGRoof-Install-1000	Roof Equipment	30	11-Nov-19	26-Dec-19	Roof Equipment
BGRoof-Install-1010	· · ·	10	27-Dec-19	10-Jan-20	Roof Patch
Exterior	1.00. 1.00.		2, 200 .,		┟ ╌╌┆╌╌┆╌╌┆╌╌┆╌╌┆╌╌┆╌╌┆╌╌┆╌╌┆╌╌┆╌╌┆╌╌┆╌╌┆
BGExt-Install-1000	Remove Scaffolding GL 24	7	28-Feb-20	09-Mar-20	Remove Scaffolding GL 24
BGExt-Install-1010	Reinstall Formawall Panels & Store GL 24	10	10-Mar-20	23-Mar-20	Reinstall Formawall Panels & Store GL 24
BGExt-Install-1020	Reinstall Curtain Wall & Store Stair 4	7	24-Mar-20	01-Apr-20	Reinstall Curtain Wall & Store Stair 4
BGExt-Install-1030	Reinstall Curtain Wall & Store Stair 3	7	02-Apr-20	10-Apr-20	Reinstall Curtain Wall & Store Stair 3
BGExt-Install-1040	Reinstall Curtain Wall & Store GL D	7	13-Apr-20	21-Apr-20	□ Reinștall Çurtain Wall & Store GL D
BGExt-Install-1050	Install Glass Doors Main Lobby	5	22-Apr-20	28-Apr-20	☐ Install Glass Doors Main Lobby
		3	22-Api -20	20-Api -20	
Interior Construct 4th Floor	ion				
BGL4-INT-1000	Commencement of Work	0	04-Dec-19	04-Dec-19	Commencement of Work
BGL4-INT-1010	Fire Sprinkler Rough-in	7	04-Dec-19	11-Dec-19	☐ Fire Sprinkler Rough-in
BGL4-INT-1010	Ductwork - Main Trunk Lines	7	12-Dec-19	11-Dec-19	Ductwork - Main Trunk Lines
BGL4-INT-1025	Lab MEP Rough-In		12-Dec-19	03-Jan-20	Lab MEP Rough-In
	-	15		-	[] Wall Layout
BGL4-INT-1030	Wall Layout	3	04-Jan-20	07-Jan-20	☐ Metal Stud Framing
BGL4-INT-1040	Metal Stud Framing	7	08-Jan-20	15-Jan-20	Soffit & Ceiling Framing
BGL4-INT-1050	Soffit & Ceiling Framing	5	16-Jan-20	21-Jan-20	I Install Door Frames
BGL4-INT-1060	Install Door Frames	4	22-Jan-20	25-Jan-20	Insulation
BGL4-INT-1070	Insulation	3	27-Jan-20	29-Jan-20	
BGL4-INT-1080	MEP Rough-in	7	27-Jan-20	03-Feb-20	☐ MEP Rough-in
BGL4-INT-1090	Drywall	7	04-Feb-20	I I-Feb-20	

Run Date: 18-Apr-19 Page 5 of 11 Actual Level of Effort

Actual Work

Remaining Work

Critical Remaining Work





Activity ID	Activity Name	Duration	Start	Finish	2019			2020					2021				2022	
					Mar Apr M Jun Jul Aug Sep Oct N	Nov Dec	Jan		ug Sep Oct Nov Dec	Jan	F Mar	Apr M	Jun Ju	Aug Sep	Oct Nov [Dec Jan	Feb Mar	Apr M
BGL4-INT-I 100	Drywall Finish	10	I 2-Feb-20	22-Feb-20				□ Drywall Finish				. ,			1 1 1			1
BGL4-INT-III0	Interior Prime Painting	7	24-Feb-20	02-Mar-20				☐ Interior Prime Painting				. 						
BGL4-INT-I I20	T-bar Ceiling	10	03-Mar-20	13-Mar-20				☐ T-bar Ceiling				. ! ! ! ! !						1
BGL4-INT-I I40	Finish Fire Sprinklers	5	I 4-Mar-20	19-Mar-20				Finish Fire Sprinklers										
BGL4-INT-I 150	Light Fixtures	7	I 4-Mar-20	21-Mar-20				Light Fixtures				<u> </u>	<u> </u>					
BGL4-INT-I 130	Grills & Registers	10	I 4-Mar-20	25-Mar-20				Grills & Registers				i i i i						
BGL4-INT-I 160	Ceiling Tiles	7	20-Mar-20	27-Mar-20				■ Ceiling Tiles										
BGL4-INT-I 170	Install Doors & Hardware	7	28-Mar-20	04-Apr-20				Install Doors & Hardy	i i i i			1 1						
BGL4-INT-I 180	Interior Window & Glazing	7	28-Mar-20	04-Apr-20				☐ Interior Window & G	Glazing									
BGL4-INT-I 190	Casework	7	28-Mar-20	04-Apr-20				☐ Casework		<u> </u>		: !!	<u> </u>		<u> </u>			
BGL4-INT-I 200	Signage	2	06-Apr-20	07-Apr-20				l Signage										
BGL4-INT-1210	Carpet	5	06-Apr-20	10-Apr-20				[] Carpet										
BGL4-INT-I 220	Finish Fire Alarm	7	08-Apr-20	15-Apr-20				☐ Finish Fire Alarm										
BGL4-INT-I 230	Finish Plumbing	5	I I-Apr-20	16-Apr-20				☐ Finish Plumbing				, 						1
BGL4-INT-I 240	Expose MEP Paint	7	I 6-Apr-20	23-Apr-20				Expose MEP Paint		<u> </u>		: !!	<u> </u>		<u> </u>		<u> </u>	
BGL4-INT-I 260	Interior Paint Touch-up	3	24-Apr-20	27-Apr-20				[] Interior Paint Tou	uch-up			i i						
BGL4-INT-I 250	Wood Ceilings	10	24-Apr-20	05-May-20				■ Wood Ceilings										
BGL4-INT-1270	Fire Extinguisher Cabinets	3	06-May-20	08-May-20				Fire Extinguishe	t t t t									
BGL4-INT-I 280	Fire Alarm Start-up & Testing	10	06-May-20	I 6-May-20				☐ Fire Alarm Sta	art-up & Testing			1 1						
BGL4-INT-I 290	Clean-up	5	18-May-20	22-May-20				☐ Clean-up		<u> </u>		 					 !	
BGL4-INT-I 300	Interior Substantial Completion	0	23-May-20	23-May-20				Interior Subs	tantial Completion									
5th Floor																		
BGL5-INT-I 000	Commencement of Work	0	04-Jan-20	04-Jan-20			1 1	Commencement of Work										
BGL5-INT-1010	Fire Sprinkler Rough-in	7	04-Jan-20	I I-Jan-20			i i	Fire Sprinkler Rough-in										
BGL5-INT-I 020	Ductwork - Main Trunk Lines	10	I 3-Jan-20	23-Jan-20				Ductwork - Main Trunk Lines		<u> </u>		; ;;	<u> </u>		ļļļ.		 	
BGL5-INT-I 030	Wall Layout	5	24-Jan-20	29-Jan-20			1 1	■ Wall Layout										
BGL5-INT-I 040	Metal Stud Framing	10	30-Jan-20	I 0-Feb-20			•	Metal \$tud Framing										
BGL5-INT-I 050	Soffit & Ceiling Framing	5	I I-Feb-20	I 5-Feb-20				Soffit & Ceiling Framing										
BGL5-INT-I 060	Install Door Frames	4	17-Feb-20	20-Feb-20				■ Install Door Frames			į							
BGL5-INT-1070	Insulation	3	21-Feb-20	24-Feb-20				[Insulation		ļ			ļ ļ		ļļļ.		ļ 	
BGL5-INT-I 080	MEP Rough-in	10	21-Feb-20	03-Mar-20				MEP Rough-in										
BGL5-INT-1090	Drywall	10	04-Mar-20	I 4-Mar-20				■ Drywall										
BGL5-INT-I 100	Drywall Finish	10	I 4-Mar-20	25-Mar-20				Drywall Finish				i i						
BGL5-INT-I I I 0	Interior Prime Painting	7	26-Mar-20	02-Apr-20				Interior Prime Painting	g									
BGL5-INT-I 120	T-bar Ceiling	10	03-Apr-20	14-Apr-20	.	.	- - -	☐ T-bar Ceiling		ļ ļ.			¦		ļļ.		 	
BGL5-INT-I 140	Finish Fire Sprinklers	5	I 5-Apr-20	20-Apr-20				☐ Finish Fire Sprinkle	ers			i i i i						
BGL5-INT-I 150	Light Fixtures	7	I 5-Apr-20	22-Apr-20				Light Fixtures				; ; ; ; ;					 	
BGL5-INT-I 130	Grills & Registers	10	I 5-Apr-20	25-Apr-20				Grills & Registers										
BGL5-INT-I 160	Ceiling Tiles	5	2 I-Apr-20	25-Apr-20				Ceiling Tiles				i i i i i i i i i i i i i i i i i i i						
BGL5-INT-I 170	Install Doors & Hardware	7	27-Apr-20	04-May-20	1		- -	📙 Install Doors & I	iiii			; }	ļ ļ		ļļ.		 	
BGL5-INT-I 180	Interior Window & Glazing	7	27-Apr-20	04-May-20				☐ Interior Windov	w & Glazing			i i i i i i						
BGL5-INT-I 190	Casework	7	27-Apr-20	04-May-20				☐ Casework				; ; ; ; ;						
BGL5-INT-I 200	Signage	2	05-May-20	06-May-20			1	∣ Signage	<u> </u>	<u> </u>		. ! ! ! ! !						

Run Date: 18-Apr-19 Page 6 of 11 Remaining Level of Effort

Actual Level of Effort

Actual Work

Remaining Work

Critical Remaining Work





Activity ID	Activity Name	Duration	Start	Finish	2019	2020 2021 2022
					Mar Apr M Jun Jul Aug Sep Oct Nov Dec J	Jan F Mar Apr May Jun Jul Aug Sep Oct Nov Dec Jan F Mar Apr M Jun Jul Aug Sep Oct Nov Dec Jan Feb Mar Apr M
BGL5-INT-I2I	0 Carpet	5	05-May-20	09-May-20		[] Carpet
BGL5-INT-I 22	0 Finish Fire Alarm	7	07-May-20	I 4-May-20		☐ Finish Fire Alarm
BGL5-INT-I 23	0 Finish Plumbing	5	I I-May-20	I 5-May-20		0 Finish Plumbing
BGL5-INT-I 24	0 Expose MEP Paint	7	I 5-May-20	22-May-20		☐ Expose MEP Paint
BGL5-INT-I 26	0 Interior Paint Touch-up	3	23-May-20	27-May-20		I Interior Paint Touch-up
BGL5-INT-I 25	0 Wood Panels Ceiling	20	23-May-20	l 6-Jun-20		Wood Panels Ceiling
BGL5-INT-I 27	0 Fire Extinguisher Cabinets	3	l 7-Jun-20	l 9-Jun-20		Fire Extinguisher Cabinets
BGL5-INT-I 28	0 Fire Alarm Start-up & Testing	10	l 7-Jun-20	27-Jun-20		☐ Fire Alarm Start-up & Testing
BGL5-INT-I 29	0 Clean-up	10	29-Jun-20	l I-Jul-20		□ Clean-up
BGL5-INT-I 30	0 Interior Substantial Completion	0	l 8-Jul-20	l 8-Jul-20		I Interior Substantial Completion
Labs						
BGL5-INT 100	00 Drywall Ready for Paint	0		25-Mar-20		◆ Drywall Ready for Paint
BGL5-INT 10 I	Paint Walls / Ceilings / Soffits - Primer / Ist Coat	5	26-Mar-20	01-Apr-20		Paint Walls / Ceilings / Soffits - Primer / Ist Coat
BGL5-INT 102	Paint Exposed Overhead	7	26-Mar-20	03-Apr-20		Paint Exposed Overhead
BGL5-INT 105	Install Ceiling / Soffit HVAC Trim	2	02-Apr-20	03-Apr-20		I Install Ceiling / Soffit HVAC Trim
BGL5-INT 106	Install Acoustic Ceiling Grid / Device Tiles - Offices	3	02-Apr-20	06-Apr-20		Install Acoustic Ceiling Grid / Device Tiles - Offices
BGL5-INT 107	70 Install Surface Mounted Piping	4	02-Apr-20	07-Apr-20		🗓 Install Surface Mounted Piping
BGL5-INT 108	Install Ceiling / Soffit Electrical Trim	5	02-Apr-20	08-Apr-20		🖪 Install Ceiling / Soffit Electrical Trim
BGL5-INT 109	00 Install Glazing	5	06-Apr-20	10-Apr-20		[] Install Glazing
BGL5-INT110	Install Acoustic Ceiling Grid / Device Tiles - Clouds	8	06-Apr-20	15-Apr-20		nstall Acoustic Ceiling Grid / Device Tiles - Clouds
BGL5-INT I I 2	20 Install Acoustic Ceiling HVAC Trim	5	10-Apr-20	16-Apr-20		□ Install Acoustic Ceiling HVAC Trim
BGL5-INT I I 3	Install Acoustic Ceiling Sprinkler Trim	5	10-Apr-20	16-Apr-20		□ Install Acoustic Ceiling Sprinkler Trim
BGL5-INT I I 4	Install Acoustic Ceiling Electrical Trim	10	10-Apr-20	23-Apr-20		Install Acoustic Ceiling Electrical Trim
BGL5-INT I 19	Install Kitchen Casework	4	24-Apr-20	29-Apr-20		■ Install Kitchen Casework
BGL5-INT 12 I	0 Install Lab Casework Electrical	4	30-Apr-20	05-May-20		🛮 Install Lab Casework Electrical
BGL5-INT 122	20 Install Lab Casework Plumbing	4	30-Apr-20	05-May-20		■ Install Lab Casework Plumbing
BGL5-INT 103	Install MEP Casework	10	06-May-20	19-May-20		Install MEP Casework
BGL5-INT I I I	0 Install Casework Electrical	20	I 3-May-20	I 0-Jun-20		Install Casework Electrical
BGL5-INT I I 5	Install Casework Plumbing	5	20-May-20	27-May-20		☐ Install Casework Plumbing
BGL5-INT I I 6	Install Fume Hoods	7	20-May-20	29-May-20		☐ Install Fume Hoods
BGL5-INT 117	70 Install Non-MEP Casework	10	20-May-20	03-Jun-20		Install Non-MEP Casework
BGL5-INT 18	Install Fume Hoods HVAC	5	01-Jun-20	05-Jun-20		☐ Install Fume Hoods HVAC
BGL5-INT 120	00 Install Casework Countertops & Splashes	5	04-Jun-20	I 0-Jun-20		☐ Install Casework Countertops & Splashes
BGL5-INT 123	Install Casework Countertop Plumbing	8	09-Jun-20	l 8-Jun-20		☐ Install Casework Countertop Plumbing
BGL5-INT 124	10 Install Doors	5	l I-Jun-20	l 7-Jun-20		□ Install Doors
BGL5-INT 125	Install Flooring	10	I I-Jun-20	24-Jun-20		Install Flooring
BGL5-INT 126	Install Floor Box Trim	10	I 8-Jun-20	0 I - Jul-20		Install Floor Box Trim
BGL5-INT 127	70 Final Paint	6	25-Jun-20	02-Jul-20		☐ Final Paint
BGL5-INT 128	Install Electrical Trim & Wiremold	10	26-Jun-20	l 0-Jul-20		Install Electrical Trim & Wiremold
BGL5-INT 129	Install Door Hardware	4	06-Jul-20	09-Jul-20		[] Install Door Hardware
BGL5-INT 130	00 Install Ceiling Tiles	5	06-Jul-20	I 0-Jul-20		■ Install Ceiling Tiles
BGL5-INT I3 I	0 Install Wall Base / Carpeting	5	06-Jul-20	I 0-Jul-20	1	■ Install Wall Base / Carpeting
BGL5-INT 133	Install Acoustic Wall Panels	5	I 3-Jul-20	l 7-Jul-20		■ Install Acoustic Wall Panels
		, ,				

Run Date: 18-Apr-19 Page 7 of 11 Remaining Level of Effort

Actual Level of Effort

Actual Work

Remaining Work

Critical Remaining Work





Activity ID	Activity Name	Duration	Start	Finish	2019	2020 2021 2022
					Mar Apr M Jun Jul Aug Sep Oct Nov Dec	Jan F Mar Apr May Jun Jul Aug Sep Oct Nov Dec Jan F Mar Apr M Jun Jul Aug Sep Oct Nov Dec Jan Feb Mar Apr M
Coolers/Storage						
DCK-L1-1210	Walk-In Cooler Install	23	I 6-Mar-20	15-Apr-20		Walk-in Cooler Install
DCK-L1-1400	Pour Topping Slab	2	I 6-Apr-20	17-Apr-20		Pour Topping Slab
1st Floor						
BGL1-INT-1000	Commencement of Work	0	28-Feb-20	28-Feb-20		Commencement of Work
BGL1-INT-1010	Fire Sprinkler Rough-in	7	28-Feb-20	06-Mar-20		Fire Sprinkler Rough-in
BGL1-INT-1020	Ductwork - Main Trunk Lines	7	07-Mar-20	I 4-Mar-20		■ Ductwork Main Trunk Lines
BGL1-INT-1030	Wall Layout	3	I 6-Mar-20	18-Mar-20		■ Wall Layout
BGL1-INT-1040	Metal Stud Framing	7	I 9-Mar-20	26-Mar-20		■ Metal Stud Framing
BGL1-INT-1050	Soffit & Ceiling Framing	5	27-Mar-20	01-Apr-20		Soffit & Ceiling Framing
BGL1-INT-1060	Install Door Frames	4	02-Apr-20	06-Apr-20		🗓 Install Door Frames
BGL1-INT-1070	Insulation	3	07-Apr-20	09-Apr-20		I Insulation
BGL1-INT-1080	MEP Rough-in	7	07-Apr-20	I 4-Apr-20		■ MEP Rough-in
BGL1-INT-1090	Drywall	7	10-Apr-20	17-Apr-20		■ Drywall
BGL1-INT-1 100	Drywall Finish	10	I 6-Apr-20	27-Apr-20		Drywall Finish
BGLI-INT-I I I 0	Interior Prime Painting	7	28-Apr-20	05-May-20		■ Interior Prime Painting
BGL1-INT-1 120	T-bar Ceiling	5	06-May-20	I I-May-20		■ T-bar Ceiling
BGL1-INT-1130	Grills & Registers	5	I 2-May-20	I 6-May-20		Grills & Registers
BGL1-INT-1 140	Finish Fire Sprinklers	5	I 2-May-20	I 6-May-20		Finish Fire Sprinklers
BGL1-INT-1 150	Light Fixtures	7	I 2-May-20	I 9-May-20		☐ Light Fixtures
BGL1-INT-I 160	Ceiling Tiles	5	18-May-20	22-May-20		■ Ceiling Tiles
BGL1-INT-I 170	Install Doors & Hardware	7	23-May-20	01-Jun-20		☐ Install Doors & Hardware
BGL1-INT-1180	Interior Window & Glazing	7	23-May-20	01-Jun-20		☐ Interior Window & Glazing
BGL1-INT-1 190	Casework	7	23-May-20	01-Jun-20		■ Casework
BGL1-INT-1200	Signage	2	02-Jun-20	03-Jun-20		¶ Signage
BGL1-INT-1210	Carpet	5	02-Jun-20	06-Jun-20		□ Carpet
BGL1-INT-1220	Finish Fire Alarm	7	04-Jun-20	I I-Jun-20		☐ Finish Fire Alarm
BGL1-INT-1230	Finish Plumbing	5	I 0-Jun-20	I 5-Jun-20		■ Finish Plumbing
BGL1-INT-1240	Paint Expose MEP	5	I 0-Jun-20	I 6-Jun-20		■ Paint Expose MEP
BGL1-INT-1270	Fire Extinguisher Cabinets	3	I 6-Jun-20	I 8-Jun-20		Fire Extinguisher Cabinets
BGL1-INT-1250	Wood Ceilings	5	I 7-Jun-20	23-Jun-20		■ Wood Ceilings
BGL1-INT-1260	Interior Paint Touch-up	3	24-Jun-20	26-Jun-20		■ Interior Paint Touch-up
BGL 1-INT-I 280	Fire Alarm Start-up & Testing	10	27-Jun-20	I 0-Jul-20		Fire Alarm Start-up & Testing
BGL1-INT-1290	Clean-up	5	I I-Jul-20	l 6-Jul-20		■ Clean-up
BGL1-INT-1300	Interior Substantial Completion	0	l 7-Jul-20	l 7-Jul-20		Interior Substantial Completion
Stair 5						
BG-Stair5-1040	Commencement of Work	0	30-Jan-20	30-Jan-20		Commencement of Work
BG-Stair5-1050	Fire Sprinkler Rough-in	7	30-Jan-20	06-Feb-20		☐ Fire Sprinkler Rough-in
BG-Stair5-1070	Wall Layout	5	07-Feb-20	I 2-Feb-20	_	□ Wall Layout
BG-Stair5-1080	Metal Stud Framing	10	13-Feb-20	24-Feb-20		☐ Metal Stud Framing
BG-Stair5-1090	Soffit & Ceiling Framing	5	25-Feb-20	29-Feb-20		[] Soffit & Ceiling Framing
BG-Stair5-I 100	Install Door Frames	4	02-Mar-20	05-Mar-20		[] Install Door Frames
BG-Stair5-1110	Insulation	6	06-Mar-20	I 2-Mar-20		☐ Insulation

Run Date: 18-Apr-19 Page 8 of 11 Remaining Level of Effort

Actual Level of Effort

Actual Work

Remaining Work

Critical Remaining Work





y ID	Activity Name	Duration	Start	Finish		2019	2020	20					022
					Mar Apr M	1 Jun Jul Aug Sep Oct Nov	Dec Jan F Mar Apr May Jun Jul Aug Sep Oct Nov Dec Jan F I	ar Apr M Jun	Jul Aug	Sep Oct	Nov Dec	Jan Feb Ma	lar Apr
BG-Stair5-I I20	MEP Rough-in	7	06-Mar-20	13-Mar-20	ļļ <u>.</u>		☐ MEP Rough-in		 		<u> </u>		
BG-Stair5-I I30	Drywall	10	13-Mar-20	24-Mar-20			☐ Drywall						
BG-Stair5-I I40	Drywall Finish	15	25-Mar-20	10-Apr-20			□ Drywall Finish						
BG-Stair5-I I50	Interior Painting	7	II-Apr-20	18-Apr-20			☐ Interior Painting						
BG-Stair5-I 160	Interior Window & Glazing	20	20-Apr-20	15-May-20			Interior Window & Glazing				. ! !		
Stair 6													
BG-Stair6-1040	Commencement of Work	0	I 6-Jan-20	I 6-Jan-20			Commencement of Work						
BG-Stair6-1050	Fire Sprinkler Rough-in	7	I 6-Jan-20	23-Jan-20	1		☐ Fire Sprinkler Rough-in						
BG-Stair6-1070	Wall Layout	3	24-Jan-20	27-Jan-20			[] Wall Layout						
BG-Stair6-1080	Metal Stud Framing	7	28-Jan-20	04-Feb-20	1		☐ Metal Stud Framing						
BG-Stair6-1090	Soffit & Ceiling Framing	5	05-Feb-20	I 0-Feb-20	1		☐ Soffit & Ceiling Framing						
BG-Stair6-I 100	Install Door Frames	4	I I-Feb-20	I 4-Feb-20	† <u> </u>		nstall Door Frames	;;;		; i	i		
BG-Stair6-1110	Insulation	3	15-Feb-20	18-Feb-20	1		[] Insulation						
BG-Stair6-I I20	MEP Rough-in	7	15-Feb-20	22-Feb-20	1		☐ MEP Rough-in						
BG-Stair6-I I30	Drywall	7	19-Feb-20	26-Feb-20	1		Drywall Drywall						
BG-Stair6-I I40	Drywall Finish	10	27-Feb-20	09-Mar-20	1		Drywall Finish				. ! !		
BG-Stair6-1150	Interior Painting	7	10-Mar-20	17-Mar-20	 		☐ Interior Painting			};			
BG-Stair6-I I60	Install Glass Rail	20	18-Mar-20	14-Apr-20	1		nstall Glass Rail					1 1	
Interior Finishes				· F: =v	1								
GCB-1360	Punch & Sign-off Roof Level	10	l I-Jan-20	22-Jan-20	1		☐ Punch & Sign-off Roof Level						
GCB-1340	Punch & Sign-off Level 4	10	23-May-20	04-Jun-20	1		Punch & Sign-off Level 4						
GCB-1370	Punch & Sign-off Level I	10	17-Jul-20	30-Jul-20	 		Punch & Sign-off Level I			}}			
GCB-1370	Punch & Sign-off Level 5	10	1 8-Jul-20	29-Jul-20	1		□ Punch & Sign-off Level 5						
		10	1 0-ju1-20	27-jui-20			ADA Site Work						
Site ADA Upgrade SITE-ADA-1000	ADA Site Work	40	06-Jan-20	28-Feb-20									
		70	00-ja11-20	20-1 60-20							. ! !		
Phase 3 - Bldg G F Seismis Upgrades	loors 2 & 3 Build Out				ļ 								
3rd Floor					•				-			1 1	
Structural Steel													
	C. 101:			21 1 22			◆ Stee Delivery						
BGL3-SSU-1000	·												
BGL3-SSU-1010	Steel Strengthening	30	22-Jan-20	03-Mar-20	ļļ .		Steel Strengthening			ļļ!			
BGL3-SSU-1030	Fireproffing	7	04-Mar-20	12-Mar-20			☐ Fireproffing				. ! !		
2nd Floor											. ! !		
Structural Steel												1 1	
BGL2-SSU-I 000	Steel Delivery	0		03-Mar-20			◆ Steel Delivery						
BGL2-SSU-1010	Steel Strengthening	30	04-Mar-20	14-Apr-20	ļļ		\$teel \$trengthening				; ;		
BGL2-SSU-1030	Fireproffing	7	15-Apr-20	23-Apr-20			☐ Fireproffing						
Interior Construction	1												
3rd Floor													
BGL3-INT-I 000	Commencement of Work	0	3 I-Jul-20	3 I-Jul-20			Commencement of Work						
BGL3-INT-1010	Fire Sprinkler Rough-in	7	3 I-Jul-20	07-Aug-20			☐ Fire Sprinkler Rough-in						
BGL3-INT-I 020	Ductwork - Main Trunk Lines	7	08-Aug-20	I 5-Aug-20			☐ Ductwork - Main Trunk Lines			1 1 7			
BGL3-INT-1030	Wall Layout	3	17-Aug-20	19-Aug-20	1		[] Wall Layout						
DGE3-1141-1030	,												

Run Date: 18-Apr-19 Page 9 of 11 Actual Level of Effort

Actual Work

Remaining Work

Critical Remaining Work

Mt. San Jacinto Community College District Temecula Valley Campus - Field Act Compliance Project Project Schedule 18-Apr-19





BGL3-INT-1040 Metal Stud Framing 7 20-Aug-20 27-Aug-20 BGL3-INT-1050 Soffit & Ceiling Framing 7 28-Aug-20 04-Sep-20 BGL3-INT-1060 Install Door Frames 4 05-Sep-20 10-Sep-20 BGL3-INT-1070 Insulation 3 11-Sep-20 14-Sep-20 BGL3-INT-1080 MEP Rough-in 7 11-Sep-20 18-Sep-20 BGL3-INT-1090 Drywall Finish 7 25-Sep-20 02-Oct-20 BGL3-INT-1100 Drywall Finish 7 25-Sep-20 02-Oct-20 BGL3-INT-1110 Interior Prime Painting 7 03-Oct-20 16-Oct-20 BGL3-INT-1120 T-bar Ceiling 5 12-Oct-20 16-Oct-20 BGL3-INT-1130 Grills & Registers 5 17-Oct-20 22-Oct-20 BGL3-INT-1140 Finish Fire Sprinklers 5 17-Oct-20 22-Oct-20	ep Oct Nov Dec Jan F Mar Apr M Jun Jul Aug Sep Oct Nov Dec Jan Feb Mar Apr M Metal Stud Framing Soffit & Ceiling Framing Install Door Frames Install Door Frames Drywall Drywall T-bar Ceiling Grills & Registers Finish Fire Sprinklers Light Fixtures Ceiling Tiles
BGL3-INT-1050 Soffit & Ceiling Framing 7 28-Aug-20 04-Sep-20	Soffit & Ceiling Framing Install Door Frames Insulation MEP Rough-in Drywall Drywall Finish Interior Prime Painting T-bar Ceiling Grills & Registers Finish Fire Sprinklers Light Fixtures
BGL3-INT-1060 Install Door Frames 4 05-Sep-20 10-Sep-20	Install Door Frames Insulation MEP Rough-in Drywall Drywall Finish Interior Prime Painting Grills & Registers Finish Fire Sprinklers Light Fixtures
BGL3-INT-1070 Insulation 3 11-Sep-20 14-Sep-20 BGL3-INT-1080 MEP Rough-in 7 11-Sep-20 18-Sep-20 BGL3-INT-1090 Drywall 5 19-Sep-20 24-Sep-20 BGL3-INT-1100 Drywall Finish 7 25-Sep-20 02-Oct-20 BGL3-INT-1110 Interior Prime Painting 7 03-Oct-20 10-Oct-20 BGL3-INT-1120 T-bar Ceiling 5 12-Oct-20 16-Oct-20 BGL3-INT-1130 Grills & Registers 5 17-Oct-20 22-Oct-20 BGL3-INT-1140 Finish Fire Sprinklers 5 17-Oct-20 22-Oct-20	Insulation MEP Rough-in Drywall Drywall Finish Interior Prime Painting T-bar Ceiling Grills & Registers Finish Fire Sprinklers Light Fixtures
BGL3-INT-1080 MEP Rough-in 7 11-Sep-20 18-Sep-20 BGL3-INT-1090 Drywall 5 19-Sep-20 24-Sep-20 BGL3-INT-1100 Drywall Finish 7 25-Sep-20 02-Oct-20 BGL3-INT-1110 Interior Prime Painting 7 03-Oct-20 10-Oct-20 BGL3-INT-1120 T-bar Ceiling 5 12-Oct-20 16-Oct-20 BGL3-INT-1130 Grills & Registers 5 17-Oct-20 22-Oct-20 BGL3-INT-1140 Finish Fire Sprinklers 5 17-Oct-20 22-Oct-20	MEP Rough-in Drywall Drywall Finish Interior Prime Painting T-bar Ceiling Grills & Registers Finish Fire Sprinklers Light Fixtures
BGL3-INT-1090 Drywall 5 19-Sep-20 24-Sep-20 BGL3-INT-1100 Drywall Finish 7 25-Sep-20 02-Oct-20 BGL3-INT-1110 Interior Prime Painting 7 03-Oct-20 10-Oct-20 BGL3-INT-1120 T-bar Ceiling 5 12-Oct-20 16-Oct-20 BGL3-INT-1130 Grills & Registers 5 17-Oct-20 22-Oct-20 BGL3-INT-1140 Finish Fire Sprinklers 5 17-Oct-20 22-Oct-20	Drywall Drywall Finish Interior Prime Painting T-bar Ceiling Grills & Registers Finish Fire Sprinklers Light Fixtures
BGL3-INT-I I00 Drywall Finish 7 25-Sep-20 02-Oct-20 BGL3-INT-I I10 Interior Prime Painting 7 03-Oct-20 10-Oct-20 BGL3-INT-I I20 T-bar Ceiling 5 12-Oct-20 16-Oct-20 BGL3-INT-I I30 Grills & Registers 5 17-Oct-20 22-Oct-20 BGL3-INT-I I40 Finish Fire Sprinklers 5 17-Oct-20 22-Oct-20	□ Drywall Finish □ Interior Prime Painting □ T-bar Ceiling □ Grills & Registers □ Finish Fire Sprinklers □ Light Fixtures
BGL3-INT-1110 Interior Prime Painting 7 03-Oct-20 10-Oct-20 BGL3-INT-1120 T-bar Ceiling 5 12-Oct-20 16-Oct-20 BGL3-INT-1130 Grills & Registers 5 17-Oct-20 22-Oct-20 BGL3-INT-1140 Finish Fire Sprinklers 5 17-Oct-20 22-Oct-20	Interior Prime Painting T-bar Ceiling Grills & Registers Finish Fire Sprinklers Light Fixtures
BGL3-INT-I I20 T-bar Ceiling 5 12-Oct-20 16-Oct-20 BGL3-INT-I I30 Grills & Registers 5 17-Oct-20 22-Oct-20 BGL3-INT-I I40 Finish Fire Sprinklers 5 17-Oct-20 22-Oct-20	☐ T-bar Ceiling ☐ Grills & Registers ☐ Finish Fire Sprinklers ☐ Light Fixtures
BGL3-INT-I I30 Grills & Registers 5 17-Oct-20 22-Oct-20 BGL3-INT-I I40 Finish Fire Sprinklers 5 17-Oct-20 22-Oct-20	☐ Grills & Registers ☐ Finish Fire Sprinklers ☐ Light Fixtures
BGL3-INT-I I40 Finish Fire Sprinklers 5 17-Oct-20 22-Oct-20	☐ Finish Fire Sprinklers ☐ Light Fixtures
	☐ Light Fixtures
BGL3-INT-I I 50 Light Fixtures 7 17-Oct-20 24-Oct-20	D. Caline Tiles
BGL3-INT-I 160 Ceiling Tiles 5 23-Oct-20 28-Oct-20	
BGL3-INT-I I70 Install Doors & Hardware 7 29-Oct-20 05-Nov-20	☐ Install Doors & Hardware
BGL3-INT-I 180 Interior Window & Glazing 7 29-Oct-20 05-Nov-20	☐ Interior Window & Glazing
BGL3-INT-I 190 Casework 7 29-Oct-20 05-Nov-20	☐ Casework
BGL3-INT-1200 Signage 2 06-Nov-20 07-Nov-20	I Signage
BGL3-INT-1210 Carpet 5 06-Nov-20 11-Nov-20	Carpet
BGL3-INT-1220 Finish Fire Alarm 7 09-Nov-20 16-Nov-20	☐ Finish Fire Alarm
BGL3-INT-1230 Finish Plumbing 5 12-Nov-20 17-Nov-20	☐ Finish Plumbing
BGL3-INT-1260 Interior Paint Touch-up 3 17-Nov-20 19-Nov-20	Interior Paint Touch-up
BGL3-INT-1270 Fire Extinguisher Cabinets 3 18-Nov-20 20-Nov-20	Fire Extinguisher Cabinets
BGL3-INT-1280 Fire Alarm Start-up & Testing 20 20-Nov-20 15-Dec-20	Fire Alarm Start-up & Testing
BGL3-INT-1290 Clean-up 5 16-Dec-20 21-Dec-20	Clean-up
BGL3-INT-I 300 Interior Substantial Completion 0 22-Dec-20 22-Dec-20	Interior Substantial Completion
2nd Floor	
BGL2-INT-I 000 Commencement of Work 0 29-Sep-20 29-Sep-20	Commencement of Work
BGL2-INT-1010 Fire Sprinkler Rough-in 7 29-Sep-20 06-Oct-20	Fire Sprinkler Rough-in
BGL2-INT-I 020 Ductwork - Main Trunk Lines 8 07-Oct-20 I 5-Oct-20	■ Ductwork - Main Trunk Lines
BGL2-INT-I 030 Wall Layout 7 I 6-Oct-20 23-Oct-20	■ Wall Layout
BGL2-INT-1040 Metal Stud Framing 15 24-Oct-20 10-Nov-20	Metal Stud Framing
BGL2-INT-1050 Soffit & Ceiling Framing 10 11-Nov-20 21-Nov-20	Soffit & Ceiling Framing
BGL2-INT-I 060 Install Door Frames 4 23-Nov-20 28-Nov-20	■ Install Door Frames
BGL2-INT-I 070 Insulation 7 30-Nov-20 07-Dec-20	☐ Insulation
BGL2-INT-I 080 MEP Rough-in 20 30-Nov-20 22-Dec-20	MEP Rough-in
BGL2-INT-1090 Drywall 10 23-Dec-20 05-Jan-21	□ Drywall
BGL2-INT-I I00 Drywall Finish 15 06-Jan-21 22-Jan-21	Drywall Finish
BGL2-INT-1110 Interior Prime Painting 7 23-Jan-21 30-Jan-21	Interior Prime Painting
BGL2-INT-I I 20 T-bar Ceiling 10 01-Feb-21 I 1-Feb-21	■ T-bar Ceiling
BGL2-INT-I 140 Finish Fire Sprinklers 5 12-Feb-21 17-Feb-21	Finish Fire Sprinklers
BGL2-INT-I I50 Light Fixtures 10 12-Feb-21 23-Feb-21	■ Light Fixtures
BGL2-INT-I I 30 Grills & Registers 10 12-Feb-21 23-Feb-21	☐ Grills & Registers
BGL2-INT-1160 Ceiling Tiles 5 18-Feb-21 23-Feb-21	■ Ceiling Tiles

Run Date: 18-Apr-19 Page 10 of 11 Remaining Level of Effort

Actual Level of Effort

Actual Work

Remaining Work

Critical Remaining Work

Mt. San Jacinto Community College District Temecula Valley Campus - Field Act Compliance Project Project Schedule 18-Apr-19





ctivity ID	Activity Name	Duration	Start	Finish	2019	2020	2021	2022
					Mar Apr M Jun Jul Aug Sep Oct Nov Dec Jar	F Mar Apr May Jun Jul Aug Sep Oct Nov Dec	Jan F Mar Apr M Jun Jul Aug Sep Oct Nov Dec J	an Feb Mar Apr
BGL2-INT-I 170	Install Doors & Hardware	7	24-Feb-21	03-Mar-21			☐ Install Doors & Hardware	
BGL2-INT-I 180	Interior Window & Glazing	7	24-Feb-21	03-Mar-21			☐ Interior Window & Glazing	
BGL2-INT-I 190	Casework	7	24-Feb-21	03-Mar-21			Casework	
BGL2-INT-I 200	Signage	2	04-Mar-21	05-Mar-21			Signage	
BGL2-INT-I2I0	Carpet	15	04-Mar-21	20-Mar-21	1		Carpet	
BGL2-INT-I 220	Finish Fire Alarm	7	06-Mar-21	I 3-Mar-2I			☐ Finish Fire Alarm	
BGL2-INT-I 240	Paint Expose MEP	10	15-Mar-21	25-Mar-21			Paint Expose MEP	
BGL2-INT-I 230	Finish Plumbing	5	22-Mar-21	26-Mar-2I			Finish Plumbing	
BGL2-INT-I 260	Interior Paint Touch-up	3	26-Mar-21	29-Mar-21			I Interior Paint Touch-up	
BGL2-INT-I 250	Wood Ceilings	20	27-Mar-21	19-Apr-21			Wood Ceilings	
BGL2-INT-I 270	Fire Extinguisher Cabinets	3	20-Apr-21	22-Apr-21			Fire Extinguisher Cabinets	
BGL2-INT-I 280	Fire Alarm Start-up & Testing	20	20-Apr-21	12-May-21			Fire Alarm \$tart-up & Testing	
BGL2-INT-I 290	Clean-up	5	13-May-21	18-May-21			Clean-up	
BGL2-INT-I 300	Interior Substantial Completion	0	19-May-21	19-May-21			Interior Substantial Completion	
Interior Finishes								
BG-INT1010	Punch & Sign-off Level 3	10	22-Dec-20	06-Jan-2 I			Punch & Sign-off Level 3	
BG-INT1000	Punch & Sign-off Level 2	10	19-May-21	31-May-21			Punch & Sign-off Level 2	
Phase 4 - Buildin	g F Central Plant Seismic Upgrades		_					
Seismis Upgrades	•							
A1000	Steel Strengthening	128	01-May-20	30-Oct-20	1	Steel Str	engthening	

Run Date: 18-Apr-19 Page 11 of 11 Remaining Level of Effort

Actual Level of Effort

Actual Work

Remaining Work

Critical Remaining Work

Mt. San Jacinto Community College District Temecula Valley Campus - Field Act Compliance Project Project Schedule 18-Apr-19





I-JOIST

INCH

INCLUDE

INFORMATION

INSPECTION INTERIOR

JOITS JOINT

LABORATORY POUND(S)

LINEAR FOOT LINEAL; LINEAR

LOW POINT

LEVEL

LIGHTWEIGHT

KIPS PER SQUARE INCH

LONG LEGS BACK-TO-BACK LONG LEG HORIZONTAL LONG LEG VERTICAL

I-JST

INCL INFO INSP INT

JST JT

KSI

LAB LB(S) or # LF

LIN LLBB LLH

LT WT

SYMBOLS ABBREVIATIONS

AB	ANCHOR BOLT	MATL	MATERIAL
ACI ADDL	AMERICAN CONCRETE INSTITUTE ADDITIONAL	MAX MB	MAXIMUM MACHINE BOLT
ADJ AESS	ADJACENT ARCHITECTURAL EXPOSED STRUCTURAL STEEL	MC MECH	MISCELLANEOUS CHANNEL SHAPE MECHANICAL
AGGR AISC	AGGREGATE AMERICAN INSTITUTE OF STEEL CONSTRUCTION	MFR MIN	MANUFACTURER MINIMUM; MINUTE
ALT	ALTERNATE	MISC	MISCELLANEOUS
ALUM ANCH	ALUMINUM ANCHOR		
ANSI APA	AMERICAN NATIONAL STANDARDS INSTITUTE AMERICAN PLYWOOD ASSOCIATION	(N) NIC	NEW NOT IN CONTRACT
APPVD APPROX	APPROVED APPROXIMATE	NORM	NORMAL
ARCH	ARCHITECTURAL; ARCHITECT	NO or # NTS	NUMBER NOT TO SCALE
ASTM AWPA	AMERICAN SOCIETY FOR TESTING AND MATERIALS AMERICAN WOOD PRESERVERS		
AWS AITC	ASSOCIATION AMERICAN WELDING SOCIETY AMERICAN INSTITUTE OF TIMBER CONSTRUCTION	O.C.	ON CENTER
&	AND AT	OD OH	OUTSIDE DIAMETER OPPOSITE HAND
@	Al	OPNG	OPENING
BLDG	BUILDING	OPP ORIG	OPPOSITE ORIGINAL
BLK BLKG	BLOCK BLOCKING	OSB	ORIENTED STRAND BOARD
BM BN	BEAM BOUNDARY		
BNDR	NAIL BOUNDARY	PARA // OR PC	PARALLEL PRECAST; PIECE
Y BOT or	BOTTOM	PERP	PERPENDICULAR
B BRC BRG	BRACE BEARING	PI P L	PLWOOD INDEX PLATE
BTWN	BETWEEN	PL PLF	PROPERTY LINE POUNDS PER LINEA FOOT
CANT	CANTILEVER	PLCS PLY	PLACES PLYWOOD
CC	CENTER TO GRAVITY	PT	POST TENSIONED
CG CIP	CENTER OF GRAVITY CAST-IN-PLACE	PJP - PP	PARTIAL JOINT PENETRATION
CJ CL	CONSTRUCTION JOINT; CONTROL JOINT CENTER LINE	PREFAB PSF	WELD PREFABRICATED POUNDS PER SQUARE FOOT
CLR CMU	CLEARANCE; CLEAR CONCRETE MASONRY UNIT	PSI PVC	POUNDS PER SQUARE INCH POLYVINYL CHLORIDE
COL	COLUMN	PVMT	PAVEMENT
COMP CONC	COMPRESSION CONCRETE	#	POUND; NUMBER
CONN CONST	CONNECTION; CONNECT CONSTRUCTION	REF	REFERENCE
R CJP - CP	COMPLETE JOINT PENETRATION WELD	REINF REQD	REINFORCE;REINFORCING REQUIRED
CTSK	COUNTERSINK; COUNTERSUNK	RF	ROOF
CU FT	CUBIC FOOT		
d DBL	PENNY (NAIL OR BAR DIA) DOUBLE	2002	CDECIAL CANTULEVED COLLIMN CYCTEM
DEPT	DEPARTMENT	SCCS SCHED	SPECIAL CANTILEVER COLUMN SYSTEM SCHEDULE
DET DF	DETAIL DOUGLAS FIR/LARCH	SECT SEP	SECTION SEPARATION
DIA or Ø DIAG	DIAMETER DIAGONAL	SHT SHTG	SHEET SHEATING
DIAPH	DIAPHRAGM	SIM	SIMILAR
DIM DN	DIMENSION DOWN	SLBB SOG	SHORT LEGS BACK-TO-BACK SLAB ON GRADE
DWG DWL	DRAWING DOWEL	SN SPCG	SHEAR NAIL SPACING
		SPECS	SPECIFICATIONS
EA EF	EACH EACH FACE	SPCL SQ SS	SPECIAL SQUARE SELECT STRUCTURAL
EJ EL or ELEV	EXPANSION JOINT ELEVATION	STAGG STD	STAGGERED STANDARD
	i.e. EL 100'-0"	STIFF STL	STIFFENERS STEEL
	i.e. PER ELEV	STRUCT	STRUCTURAL STRUCTURAL I
ELEC	ELECTRICAL	STRUCT I SW	SHEAR WALL
EMBED EN	EMBEDMENT EDGE NAIL	SYM	SYMMETRICAL
ENGR	ENGINEER	ТВ	TIE BEAM
EQ EQUIP	EQUAL;EQUIVALENT EQUIPMENT	TEMP	TEMPERATURE;TEMPORARY
ETC EW	ET CETERA EACH WAY	THK THRU	THICKNESS/THICK THROUGH
EXIST or (E) EXT	EXISTING EXTERIOR	T.O. TOC	TOP OF TOP ON CONCRETE
	EXTERIOR	TOF TOS	TOP OF FOOTING TOP OF STEEL
FDN	FOUNDATION	TOW T&B	TOP OF WALL TOP AND BOTTOM
FF	FINISHED FLOOR	T&G	TONGUE AND GROOVE
FIN FJ	FINISH FLOOR JOIST	TSG TYP	TAPERED STEEL GRIDER TYPICAL
FL FLG	FLOOR LINE FLANGE		
FLR FN	FLOOR FIELD NAIL	UBC UNO UT	UNIFORM BUILDING CODE
FOC	FACE OF CONCRETE		UNLESS NOTED OTHERWISE ULTRA-SONIC
FOM FOS	FACE OF MASONRY FACE OF STUD		TEST
FOW FP	FACE OF WALL FULL PENETRATION; FIRE		
FRMG FT	PROOFING FRAMING FOOT: FEET	VERT	VERTICAL
FTG	FOOTING	W/	WITH
GA	GAUGE	W/O WD	WITHOUT WOOD
GALV GB	GALVANIZED GRADE BEAM	WP	WORK POINT;WATERPROOF
GLB	GLUE	WT WW	WEIGHT; STRUCTURAL TEE SHAPE
GR GRND	LAMINATED BEAM GRADE	F	WELDED WIRE FABRIC
	GROUND		
HORIZ	HORIZONTAL		
HDF	HEADER		
HGR HOSP	HANGER HOSPITAL	<u>STRUCTURAL</u>	STEEL SHAPES
HP HS	HIGH POINT HIGH STRENGTH	WF C	W SHAPE AMERICAN STD
HSH HT	HORIZONTALLY SLOTTED HOLES HEIGHT	MC L WT,	CHANNEL SHAPE MISC CHANNEL
		ST,	SHAPE ANGLE SHAPE
ID I-JST	INSIDE DIAMETER I-JOIST	MT PIPE	STRUCTURAL TEE SHAPE STANDARD PIPE SHAPE EXTRA

PIPE PIPE -X PIPE

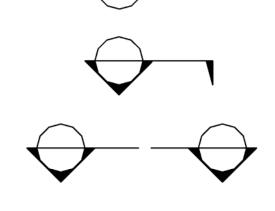
- XX HSS

STRONG PIIPE SHAPE STRUCT

STRONG PIPE SHAPE DBL

TUBING SHAPE

SECTION REFERENCE BUBBLE
DETAIL REFERENCE BUBBLE WITH ARROW



7777

77777777

-x-x-x-x-x-

BUILDING SECTION INDICATOR

DETAIL REFERENCE BUBBLE

FULL HEIGHT SECTION INDICATOR



NORTH ARROW

SLOPE $\overline{}$ EARTH LAYER

STEPPED SURFACE; FLOOR DEPRESSION

SLOPED SURFACE

INDICATES SAND OR GROUT

INDICATES GRAVEL TOP OF SLAB ELEVATION

> WELDED WIRE (WWF LAYER)

FOOTING TYPE

INDICATES MASONRY WALLS

STEEL TUBE COLUMN

STEEL PIPE COLUMN

WIDE FLANGE STEEL COLUMN

MEMBER SPLICE

TOP OF STEEL + ELEVATION

NUMBER OF EVENLY SPACED SHEAR STUDS

SPECIAL STUD SPACING SEE TYPICAL STEEL DETAILS [X -Y-Z] <3/4>

BEAM CAMBER AT MID-SPAN

BEAM LATERAL BRACE

STEPPED FOOTING

DIRECTION OF SPAN

-o----o-

(+3")

STEEL IN CROSS SECTION

SHEET INDEX

SHEET NUMBER	SHEET NAME
S-000	ABBREVIATIONS, SYMBOLS AND SHEET INDEX
S-001	GENERAL NOTES
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S-201.2	PARTIAL FOUNDATION PLAN
S-202.1	PARTIAL SECOND FLOOR PLAN
S-202.2	PARTIAL SECOND FLOOR PLAN
S-203.1	PARTIAL THIRD FLOOR PLAN
S-203.2	PARTIAL THIRD FLOOR PLAN
S-204.1	PARTIAL FOURTH FLOOR PLAN
S-204.2	PARTIAL FOURTH FLOOR PLAN
S-205.1	PARTIAL FIFTH FLOOR PLAN
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S-206.2	PARTIAL ROOF PLAN
S-301	BRACED FRAME ELEVATIONS
S-302	BRACED FRAME ELEVATIONS
S-400	PARTIAL PLANS
S-401	PARTIAL PLANS
S-500	TYPICAL CONCRETE DETAILS
S-510	CONCRETE DETAILS
S-610	STEEL DETAILS
S-611	STEEL DETAILS
S-612	STEEL DETAILS
S-620	BRACE FRAME DETAILS
S-621	BRACE FRAME DETAILS
S-622	BRACE FRAME DETAILS
S-623	BRACE FRAME DETAILS
S-624	BRACE FRAME DETAILS
S-625	BRACE FRAME DETAILS
S-801	TYPICAL METAL STUD WALL DETAILS
S-802	TYPICAL METAL STUD WALL DETAILS
S-803	TYPICAL METAL STUD WALL DETAILS
S-810	BUILDING WALL SECTIONS
S-900	PARTIAL STAIR PLAN
S-901	PARTIAL STAIR PLAN



ARCHITECT STAMP	CONSULTANT STAMP
* OC-2128 *	PROFESS /ON/A/CERT REPORT TO PROFESS /ON/A/CE

AGENCY APPROVAL

NO. DATE DESCRIPTION
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THE ARCHITECT DOES NOT REPRESENT THAT THESE PLANS OR THE SPECIFICATIONS ARE SUITABLE FOR ANY SITE OTHER THAN THE ONE FOR WHICH THEY WERE SPECIFICALLY
PREPARED. THE ARCHITECT DISCLAIMS
RESPONSIBILITY FOR THESE PLANS AND
SPECIFICATIONS IF THEY ARE USED IN WHOLE OR
IN PART AT ANY OTHER SITE

PROJECT OWNER & TITLE

MT. SAN JACINTO COMMUNITY COLLEGE DISTRICT

TEMECULA VALLEY CAMPUS

41888 Motor Car Pkwy, Temecula, CA 92591

ABBREVIATIONS, SYMBOLS AND

SHEET INDEX

S-000 DATE: Issue Date

STRUCTURAL STEEL

- STRUCTURAL STEEL SHALL BE DETAILED, FABRICATED AND ERECTED IN ACCORDANCE WITH THE AISC SPECIFICATION FOR THE DESIGN, FABRICATION AND ERECTION OF STRUCTURAL STEEL FOR BUILDINGS (LATEST EDITION), AND WITH CHAPTER 22 OF THE CODE.
- ALL STRUCTURAL STEEL SHALL CONFORM TO THE ASTM DESIGNATION AS
- INDICATED BELOW (UNO): ALL W AND WT SHAPES A992 OR A572, GRADE 50

PLATES, CONNECTION

PLATES, AND MISC A-36 A-500, GRADE B, Fy = 42 KSI ROUND SECTIONS

SQUARE / RECTANGULAR SECTIONS A-500, GRADE B, Fy = 46 KSI

A-36 ANGLES, CHANNELS

HIGH STRENGTH BOLTS (TYP FOR CONNECTIONS, UNO)

DRAG CONNECTION BOLTS A490-SC / F2280

ANCHOR BOLTS IN MASONRY A-307. UNO ANCHOR RODS IN CONCRETE F-1554 GR 36, UNO

MACHINE BOLTS

- 3. THE STRUCTURAL STEEL FABRICATOR SHALL FURNISH SHOP DRAWINGS TO THE ARCHITECT OF ALL STEEL FOR ARCHITECTS AND STRUCTURAL ENGINEERS REVIEW BEFORE FABRICATION.
- 4. BOLT HOLES USED IN STEEL SHALL BE 1/16" LARGER IN DIAMETER THAN NOMINAL
- SIZE OF BOLT USED, EXCEPT AS NOTED. 5. ALL STRUCTURAL STEEL SURFACES THAT ARE ENCASED IN CONCRETE, OR MASONRY OR SPRAY ON FIREPROOFING SHALL BE LEFT UNPAINTED.
- 6. ALL WELDING IS TO BE DONE BY CERTIFIED WELDERS USING E70XX ELECTRODES (UNO). ALL WELDS SHALL BE IN CONFORMITY WITH THE PROJECT SPECIFICATIONS AND THE CODE FOR WELDING IN BUILDING CONSTRUCTION (AWS D1.1 LATEST REVISION) OF THE AMERICAN WELDING SOCIETY. SEE SPECIAL INSPECTIONS SECTION FOR WELDING INSPECTION REQUIREMENTS.

A-325-N / F1852

- WELD LENGTHS CALLED FOR ON PLANS ARE THE NET EFFECTIVE LENGTH REQUIRED. WHERE FILLET WELD SYMBOL IS GIVEN WITHOUT INDICATION OF SIZE, USE MINIMUM SIZE WELDS AS SPECIFIED IN AISC MANUAL OF STEEL CONSTRUCTION 13TH EDITION, SECTION J2.2b.
- 8. ALL STRUCTURAL STEEL AND MISCELLANEOUS METAL EXPOSED TO THE WEATHER SHALL BE HOT DIP GALVANIZED AFTER FABRICATION. PROTECT FIELD WELDS EXPOSED TO THE WEATHER VIA PRIME AND PAINT OR BRUSH / COLD GALVANIZING. REFER TO ARCH DRAWINGS FOR STEEL
- 9. THE USE OF E70T-4 WELDING WIRE IS NOT ALLOWED FOR ANY APPLICATION. ALL WELD FILLER METAL SHALL BE OF THE LOW HYDROGEN TYPE AND SHALL HAVE A MINIMUM CHARPY V-NOTCH (CVN) VALUE OF 20 FT-LBS AT A TEMPERATURE OF (-)20F.
- 10. FOR ALL STRUCTURAL STEEL THAT IS TO REMAIN EXPOSED AND VISIBLE PER THE ARCHITECTURAL DRAWINGS, CONTRACTOR SHALL GRIND SMOOTH ALL EXPOSED WELDS AND SHALL COMPLY WITH THE SPECIFICATIONS FOR (AESS) ARCHITECTURALLY EXPOSED STRUCTURAL STEEL FOUND ON THE AISC CODE OF STANDARD PRACTICE.
- 11. WRITTEN WELDING PROCEDURE SPECIFICATIONS (WPS) PER THE RECOMMENDATIONS OF THE AMERICAN WELDING SOCIETY (AWS) SHALL BE DEVELOPED BY THE FABRICATOR/ERECTOR AND SUBMITTED FOR REVIEW TO THE ENGINEER PRIOR TO ANY WELDING OF THE STRUCTURAL STEEL. THE WELDING PROCEDURES SHALL INCLUDE ALL THE WELDED JOINTS AND CONFIGURATIONS TO BE USED ON THIS PROJECT-ONLY WPS WHICH ARE RELEVANT TO THIS PROJECT SHALL BE SUBMITTED. ALL WELDED JOINTS SHALL BE PREQUALIFIED PER AWS OR BE QUALIFIED BY TEST PER AWS. A PROCEDURE QUALIFICATION RECORD (PQR) SHALL BE INCLUDED WITH THE WPS IF THE WELDING PROCEDURE OR JOINT IS QUALIFIED BY TESTING. THE ELECTRODE MANUFACTURER AND PRODUCT/TRADE NAME SHALL BE IDENTIFIED IN THE WPS IN ADDITION TO THE AWS ELECTRODE CLASSIFICATION NAME. A COPY OF THE ELECTRODE MANUFACTURER'S TECHNICAL DATA SHEETS WITH THE RECOMMENDED WELDING PARAMETERS SHALL BE SUBMITTED WITH THE WPS.

EVENT SEED TIME HISTORY RECORDS

EARTHQUAKE NAME	STATION NAME
LANDERS	LUCERNE
TABAS, IRAN	TABAS
LOMA PRIETA	STRATOGA - ALOHA AVE
DENALI, ALASKA	TAPS PUMP STATION #10
KOBE, JAPAN	KIMA
CHI-CHI, TAIWAN	TCU089
DARFIELD, NEW ZEALAND	OFHS
EL MAYOR-CUCAPAH	MICHOACAN DE OCAMPO
HECTOR MINE	HECTOR
KOCAELI, TURKEY	YARIMCA
LOMA PRIETA	GILROY ARRAY #3

DESIGN INFORMATION:

1. ROOF LIVE LOADS (2016 CBC SECTION 1603A.1.2)

2. WIND DESIGN DATA (2016 CBC SECTION 1603A.1.4):

20 PSF (REDUCIBLE)

WIND LOADS ARE IN ACCORDANCE WITH SECTION 1609A OF THE CODE.

BASIC WIND SPEED, V = 115 MPH (3-SECOND GUST)

EXPOSURE C

THE APPLICABLE PRESSURE COEFFICIENTS ARE AS FOLLOWS:

INTERNAL PRESSURE COEFFICIENT: $GCpi = \pm 0.18$

CONSTRUCTION JOINTS

- 1. ALL CONSTRUCTION JOINTS SHALL BE CONSTRUCTED IN ACCORDANCE WITH ACI 318-14 SECTION 26.5.6 AND THE TYPICAL CONSTRUCTION JOINT DETAILS SHOWN ON THE STRUCTURAL DRAWINGS.
- 2. ALL SURFACES OF CONSTRUCTION JOINTS SHALL BE CLEANED TO REMOVE DUST, CHIPS, OR OTHER FOREIGN MATTER PRIOR TO PLACING THE ADJACENT CONCRETE
- 3. THE CONTRACTOR SHALL SUBMIT THE PROPOSED LOCATIONS OF CONSTRUCTION JOINTS TO THE STRUCTURAL ENGINEER FOR REVIEW BEFORE STARTING CONSTRUCTION.

CAST-IN-PLACE CONCRETE

- 1. ALL CONCRETE CONSTRUCTION SHALL CONFORM WITH CHAPTER 19A OF THE CODE.
- 2. REINFORCED CONCRETE WAS DESIGNED BY THE "ULTIMATE STRENGTH DESIGN METHOD."
- 3. CONCRETE MIXES SHALL BE DESIGNED BY AN APPROVED TESTING LABORATORY AND REVIEWED BY THE STRUCTURAL ENGINEER. THE COMPRESSIVE STRENGTH OF THE CONCRETE SHALL BE PROPORTIONED BASED ON SECTION 1905A OF THE CODE.
- 4. SCHEDULE OF STRUCTURAL CONCRETE STRENGTH AND TYPES (UNO):

LOCATION IN STRUCTURE	MINIMUM STRENGTH (PSI)	DENSITY (PCF)	SLUMP (IN ±1)	MAX WATER/ CEMENT RATIO
ALL CONCRETE (U.N.O)	4000	145	4	0.5
SLAB ON GRADE AND MISC CONCRETE	3000	145	4	0.5

- 5. TYPICAL PORTLAND CEMENT SHALL CONFORM TO ASTM C-150, TYPE II. PORTLAND CEMENT IN CONCRETE IN CONTACT WITH EARTH SHALL CONFORM TO ASTM C-150, TYPE V.
- 6. AGGREGATE FOR HARDROCK CONCRETE SHALL CONFORM TO ALL REQUIREMENTS AND TESTS OF ASTM C-33 AND PROJECT SPECIFICATIONS.
- 7. CONCRETE MIXING OPERATION, ETC. SHALL CONFORM TO ASTM C-94.
- 8. PLACEMENT OF CONCRETE SHALL CONFORM TO CODE SECTION 1905A AND PROJECT SPECIFICATIONS. CLEAN AND ROUGHEN TO 1/4" AMPLITUDE ALL CONCRETE SURFACES AGAINST WHICH NEW CONCRETE IS TO BE PLACED.
- 9. ALL REINFORCING BARS, ANCHOR BOLTS AND OTHER CONCRETE INSERTS SHALL BE WELL SECURED IN POSITION PRIOR TO PLACING CONCRETE.
- 10. PROVIDE SLEEVES FOR PLUMBING AND ELECTRICAL OPENINGS IN CONCRETE BEFORE PLACING. SPACE EMBEDDED SLEEVES AT A MINIMUM OF 3 DIAMETERS. DO NOT CUT ANY REINFORCING WHICH MAY CONFLICT. CORING IN CONCRETE IS NOT PERMITTED. NOTIFY THE STRUCTURAL ENGINEER IN ADVANCE OF CONDITIONS NOT SHOWN ON THE DRAWINGS. SEE THESE DRAWINGS FOR ADDITIONAL RESTRICTIONS OF THE PLACEMENT OF OPENINGS IN SLABS AND WALLS.
- 11. CONDUITS LARGER THAN 1 1/2" DIAMETER SHALL NOT BE EMBEDDED IN STRUCTURAL CONCRETE EXCEPT WHERE SPECIFICALLY APPROVED BY STRUCTURAL ENGINEER. CONDUITS SHALL NOT DISPLACE OR INTERRUPT REINFORCING BARS, SPACE EMBEDDED CONDUITS AND SLEEVES AT A MINIMUM OF 3 DIAMETERS.
- 12. NO PIPES SHALL BE EMBEDDED IN CONCRETE. USE SLEEVES FOR PIPES PASSING THROUGH CONCRETE.

REINFORCING STEEL

- 1. REINFORCING BARS SHALL CONFORM TO THE REQUIREMENTS OF CHAPTER 19A OF THE CODE, ASTM A706, GRADE 60 UNO. DEFORMATIONS SHALL BE IN ACCORDANCE WITH
- 2. BARS SHALL BE CLEAN OF RUST, GREASE, OR OTHER MATERIALS LIKELY TO IMPAIR BOND. ALL REINFORCING BAR BENDS SHALL BE MADE COLD.
- 3. WELDED WIRE FABRIC SHALL CONFORM TO ASTM A-185. PROVIDE LAPS AS PER ACI 318 SECTION 12.19, 9" MINIMUM. WWF SHALL BE SUPPORTED ON APPROVED CHAIRS.
- 4. REINFORCING BAR SPLICES SHALL BE MADE AS INDICATED ON THE DRAWINGS. MINIMUM SPLICE LENGTH FOR REINFORCING STEEL BARS IN MASONRY SHALL BE 48 BAR DIAMETERS, 24" MINIMUM. MINIMUM SPLICE LENGTH FOR REINFORCING STEEL BARS IN CONCRETE SHALL BE AS REQUIRED FOR CLASS B SPLICES PER ACI 318 SECTION 12.15.1 UNO. LAP ALL HORIZONTAL BARS AT CORNERS AND INTERSECTIONS.
- 5. ALL BARS SHALL BE MARKED SO THEIR IDENTIFICATION CAN BE MADE WHEN THE FINAL IN-PLACE INSPECTION IS MADE.
- 6. WHERE WELDING OF REINFORCING IS APPROVED BY THE STRUCTURAL ENGINEER, IT SHALL BE DONE BY AWS CERTIFIED WELDERS USING APPROVED ELECTRODES. WELDER SHALL BE APPROVED BY DSA. WELDING PROCEDURES SHALL CONFORM TO THE REQUIREMENTS OF STRUCTURAL WELDING CODE-REINFORCING STEEL AWS-D1.4, LATEST REVISION. REINFORCING BARS TO BE WELDED SHALL CONFORM TO THE REQUIREMENTS OF ASTM A-706
- 7. BARS IN SLABS SHALL BE SECURELY SUPPORTED ON WELL-CURED CONCRETE BLOCKS OR APPROVED METAL CHAIRS, PRIOR TO PLACING CONCRETE.
- 8. REINFORCING STEEL SHALL BE DETAILED IN ACCORDANCE WITH THE "ACI MANUAL OF STANDARD PRACTICE FOR DETAILING REINFORCED CONCRETE STRUCTURES." LATEST EDITION.
- 9. COMPLETE AND DETAILED REINFORCING PLACEMENT DRAWINGS SHALL BE PREPARED AND SUBMITTED TO THE ARCHITECT FOR REVIEW BY THE STRUCTURAL ENGINEER PRIOR TO FABRICATION IN ACCORDANCE WITH THE SPECIFICATIONS AND APPLICABLE CODES. THESE DRAWINGS SHALL BE AVAILABLE ON THE JOB SITE PRIOR TO PLACING OF CONCRETE.
- 10. MILL TEST REPORTS FOR GRADE 60 BARS SHALL BE SUBMITTED PRIOR TO PLACEMENT OF CONCRETE.
- 11. CONTINUOUS INSPECTION OF CONCRETE SHALL INCLUDE INSPECTION DURING INSTALLATION OF REINFORCING STEEL. INSPECTION SHALL BE SCHEDULED SO THAT PLACEMENT OF REINFORCING STEEL, CONDUIT, SLEEVES AND EMBEDDED ITEMS MAY BE CORRECTED PRIOR TO PLACEMENT OF OVERLYING GRIDS OF REINFORCING STEEL.

MINIMUM

12. CONCRETE PROTECTION FOR REINFORCEMENT:

REINFORCEMENT:

(I) CAST IN PLACE CONCRETE (NON-PRESTRESSED). THE FOLLOWING MINIMUM CONCRETE COVER SHALL BE PROVIDED FOR

	COVER,
CONCRETE CAST AGAINST AND PERMANENTLY EXPOSED TO EARTH	3
CONCRETE EXPOSED TO EARTH OR WEATHER:	
NO. 6 THROUGH NO. 18 BAR	2
NO. 5 BAR, W31 OR D31 WIRE AND SMALLER	1 1/2
CONCRETE NOT EXPOSED TO WEATHER OR IN CONTACT WITH GROUND:	
SLABS, WALLS, JOISTS:	
NO. 14 AND NO. 18 BAR	1 1/2
NO. 11 BAR AND SMALLER	3/4
BEAMS, COLUMNS:	
PRIMARY REINFORCEMENT TIES, STIRRUPS, SPIRALS	1 1/2

GENERAL

- 1. THE CONTRACTOR SHALL VERIFY ALL DIMENSIONS PRIOR TO STARTING CONSTRUCTION. THE ARCHITECT SHALL BE NOTIFIED OF ANY DISCREPANCIES OR INCONSISTENCIES.
- 2. ALL DRAWINGS AND SPECIFICATIONS ARE CONSIDERED TO BE A PART OF THE CONTRACT DOCUMENTS. THE CONTRACTOR SHALL BE RESPONSIBLE FOR THE REVIEW AND COORDINATION OF ALL DRAWINGS AND SPECIFICATIONS PRIOR TO THE START OF CONSTRUCTION. ANY DISCREPANCIES THAT OCCUR SHALL BE BROUGHT TO THE ATTENTION OF THE ARCHITECT PRIOR TO START OF CONSTRUCTION SO THAT A CLARIFICATION CAN BE ISSUED. ANY WORK PERFORMED IN CONFLICT WITH THE CONTRACT DOCUMENTS OR ANY CODE REQUIREMENTS SHALL BE CORRECTED BY THE CONTRACTOR AT THEIR OWN EXPENSE AND AT NO EXPENSE TO THE OWNER OR ARCHITECT.
- 3. NOTES AND DETAILS ON DRAWINGS SHALL TAKE PRECEDENCE OVER GENERAL NOTES AND TYPICAL DETAILS. WHERE NO DETAILS ARE GIVEN, CONSTRUCTION SHALL BE AS SHOWN FOR SIMILAR WORK.
- 4. ALL WORK SHALL CONFORM TO THE MINIMUM STANDARDS OF THE FOLLOWING CODES:
- 2016 CALIFORNIA BUILDING CODE, PART 2, VOLUME 2 OF 2, AND TITLE 24 C.C.R. 2016 EDITION AND LATEST REVISIONS REFERRED TO HERE AS "THE CODE", AND ANY OTHER REGULATING AGENCIES WHICH HAVE AUTHORITY OVER ANY PORTION OF THE WORK, INCLUDING THE STATE OF CALIFORNIA DIVISION OF INDUSTRIAL SAFETY, AND THOSE CODES & STANDARDS LISTED IN THESE NOTES AND SPECIFICATIONS.
- 5. SEE ARCHITECTURAL DRAWINGS FOR THE FOLLOWING:
- A. SIZE AND LOCATION OF ALL DOOR AND WINDOW OPENINGS, EXCEPT AS NOTED
- B. SIZE AND LOCATION OF ALL INTERIOR AND EXTERIOR NON-BEARING PARTITIONS UNLESS NOTED AND/OR DETAILED ON THE STRUCTURAL DRAWINGS
- C. SIZE AND LOCATION OF ALL CONCRETE CURBS, EQUIPMENT PADS, PITS, FLOOR DRAINS,

D. SIZE AND LOCATION OF ALL FLOOR AND ROOF OPENINGS EXCEPT AS SHOWN

- SLOPES, DEPRESSED AREAS, CHANGE IN LEVEL, CHAMFERS, GROOVES, INSERTS, ETC
- E. FLOOR AND ROOF FINISHES
- F. MISCELLANEOUS DRAINAGE AND WATERPROOFING
- G. ALL FIREPROOFING REQUIREMENTS INCLUDING FIREPROOFING OF STRUCTURAL STEEL
- H. DIMENSIONS NOT SHOWN ON STRUCTURAL DRAWINGS
- 6. SEE MECHANICAL, PLUMBING AND ELECTRICAL DRAWINGS FOR THE FOLLOWING:
- A. PIPE RUNS, SLEEVES, HANGERS, TRENCHES, WALL AND SLAB OPENINGS, ETC., EXCEPT AS SHOWN OR NOTED.
- B. ELECTRICAL CONDUIT RUNS, BOXES, OUTLETS IN WALLS AND SLABS.
- C. CONCRETE INSERTS FOR ELECTRICAL, MECHANICAL OR PLUMBING FIXTURES.
- D. SIZE AND LOCATION OF MACHINE OR EQUIPMENT BASES, ANCHOR BOLTS FOR MOTOR MOUNTS.
- 7. THE CONTRACT STRUCTURAL DRAWINGS AND SPECIFICATIONS REPRESENT THE FINISHED STRUCTURE. THEY DO NOT INDICATE THE METHOD OF CONSTRUCTION. THE CONTRACTOR SHALL PROVIDE ALL MEASURES NECESSARY TO PROTECT THE STRUCTURE DURING CONSTRUCTION. SUCH MEASURES SHALL INCLUDE, BUT NOT BE LIMITED TO, BRACING, SHORING FOR LOADS DUE TO CONSTRUCTION EQUIPMENT ETC. THE CONTRACTOR IS RESPONSIBLE FOR PROVISION OF TEMPORARY SHORING AND OTHER CONSTRUCTION AIDS, INCLUDING ALL ENGINEERING OF SUCH SYSTEMS, FOR TEMPORARY SUPPORT OF NEW AND/OR EXISTING STRUCTURAL ELEMENTS AS REQUIRED FOR ERECTION AND OTHER CONTRACTOR'S MEANS AND METHODS OF CONSTRUCTION (UNO). OBSERVATION VISITS TO THE SITE BY THE STRUCTURAL ENGINEER SHALL NOT INCLUDE INSPECTION OF THE ABOVE ITEMS.
- 8. THE CONTRACT STRUCTURAL DRAWINGS SHOW THE BUILDING IN ITS FINAL INTENDED POSITION. CONTRACTOR SHALL MAKE PROVISIONS IN THE CONSTRUCTION SEQUENCING OF THE BUILDING TO TAKE INTO ACCOUNTS SHRINKAGE, CREEP, SHORTENING, ETC.
- 9. FOR PIPES AND CONDUITS PENETRATING THROUGH OR EMBEDDED IN CONCRETE/CMU OR SLEEVED THROUGH CONCRETE/CMU, REFER TO THE CONCRETE/CMU GENERAL NOTES.
- 10. ASTM SPECIFICATIONS ON THE DRAWINGS SHALL BE THE VERSION REFERENCED IN CHAPTER 35 OF THE CODE OR AS REFERENCED IN THE APPLICABLE DESIGN STANDARD.
- 11. CONTRACTOR SHALL INVESTIGATE SITE DURING CLEARING AND EARTHWORK OPERATIONS FOR FILLED EXCAVATIONS OR BURIED STRUCTURES, SUCH AS CESSPOOLS, CISTERNS, FOUNDATIONS, ETC. IF ANY SUCH STRUCTURES ARE FOUND, THE STRUCTURAL ENGINEER AND GEOTECHNICAL ENGINEER SHALL BE NOTIFIED IMMEDIATELY.
- 12. CONSTRUCTION MATERIAL SHALL BE SPREAD OUT IF PLACED ON FRAMED ROOF OR FLOOR. LOAD SHALL NOT EXCEED THE DESIGN LIVE LOAD PER SQUARE FOOT. THE CONTRACTOR TO DESIGN AND PROVIDE ADEQUATE SHORING AND/OR BRACING WHERE STRUCTURE HAS NOT ATTAINED DESIGN STRENGTH.
- 13. FOR PROJECTS REQUIRING SHORING FOR SOIL EXCAVATION:
- a. THE CONTRACTOR SHALL VERIFY THE EXTENT AND LOCATIONS OF SITE UTILITIES PRIOR TO EXCAVATION OR SHORING. SINCE THE SURVEY WAS BASED PRIMARILY ON PUBLIC RECORDS, THERE MAY BE DISCREPANCIES BETWEEN THE LOCATION INDICATED ON THE SITE SURVEY AND ACTUAL VERIFIED LOCATIONS. IF THE ACTUAL FIELD VERIFIED LOCATION OF UTILITIES COULD RESULT IN A CONFLICT WITH THE SHORING, THE EOR FOR SHORING SHALL BE NOTIFIED IMMEDIATELY.
- b. HEAVY EQUIPMENT, CRANES AND MATERIAL STOCKPILES SHALL NOT BE LOCATED ON OR ADJACENT TO SHORING UNLESS REVIEWED BY THE EOR FOR SHORIG, AND APPROVED BY OSHPD.
- c. CONTRACTOR SHALL COORDINATE SHORING WITH DRAWINGS OF RECORD TO INSURE PROVISIONS FOR POCKETS, BLOCKOUTS, OFFSETS, STEPPED FOOTINGS AND ANY OTHER ITEMS AFFECTED BY
- d. STOCK PILING OR STORAGE OF MATERIAL ON OR NEAR SHORING BULKHEAD IS NOT PERMITTED.
- 14. WHERE NOT SHOWN ON THE DRAWINGS, CONTRACTOR TO PROVIDE FOR DESIGN AND INSTALLATION OF ALL CRIBBING, SHEATHING AND SHORING REQUIRED AND SHALL BE SOLELY RESPONSIBLE FOR ALL EXCAVATION PROCEDURES INCLUDING LAGGING, SHORING, AND PROTECTION OF ADJACENT PROPERTY, STRUCTURES, STREETS, AND UTILITIES IN ACCORDANCE WITH ALL NATIONAL, STATE AND LOCAL SAFETY ORDINANCES. BRACED SHORING DESIGN EMPLOYING TIE-BACK ANCHORS, WHEN USED, SHALL BE SUBMITTED TO SEOR AND OSHPD FOR REVIEW AND APPROVAL BY OSHPD.
- 15. AN UNDERGROUND SERVICE ALERT INQUIRY IDENTIFICATION NUMBER MUST BE OBTAINED AT LEAST TWO WORKING DAYS BEFORE STARTING WORK WITH THIS PERMIT.
- A. FOR PROJECTS IN SOUTHERN CALIFORNIA TELEPHONE NO. 1-800-422-4133. B. FOR PROJECTS IN NORTHERN CALIFORNIA TELEPHONE NO. 1-800-227-2600.
- 16. SLABS ON GRADE SHOWN ON THESE DRAWINGS ARE NOT DESIGNED AS STRUCTURAL DIAPHRAGMS.
- 17. EDGE OF SLAB DIMENSIONS TO BE COORDINATED AND VERIFIED BY THE GENERAL CONTRACTOR PRIOR TO FABRICATION.
- 18. CONTRACTOR SHALL SUBMIT TO SEOR A SET OF PLANS INDICATING LOCATION AND MAGNITUDE OF ALL LOADS (GRAVITY, SEISMIC, AND THERMAL) APPLIED TO THE STRUCTURE FROM MECHANICAL, ELECTRICAL, PLUMBING, TELECOMMUNICATION, PNEUMATIC TUBE, AND FIRE-PROTECTION SYSTEMS (DUCTS, PIPE, CONDUITS, ETC.). THESE PLANS SHALL CONSOLIDATE THE LOAD INFORMATION OF ALL SYSTEMS IN ONE COORDINATED AUTOCAD COMPUTER FILE (SHOW ALL SYSTEM INFORMATION ON THE SAME PLANS) AND SHALL BE SUBMITTED TO SEOR PRIOR TO INSTALLATION OF THESE SYSTEMS FOR THE PURPOSE OF VERIFICATION OF ADEQUACY OF LOADS APPLIED TO THE STRUCTURE. PLANS SHALL BE SUBMITTED TOGETHER WITH AN ELECTRONIC FILE INCLUDING ALL OF THE LOADS SHOWN ON PLANS BY INDICATING LEVEL, LOCATION, COORDINATES AND MAGNITUDE. INFORMATION PROVIDED IN THESE PLANS THAT IS BASED ON SEISMIC BRACING SUBMITTALS TO OSHPD SHALL BE BASED ON THE OSHPD APPROVED SUBMITTALS. CONTRACTOR SHALL ALLOW FOR SUFFICIENT TIME BETWEEN SUBMISSIONS OF THESE PLANS AND INSTALLATION OF THE ABOVE MENTIONED SYSTEMS TO RESOLVE ANY ISSUES IDENTIFIED DURING THE LOAD VERIFICATION PROCESS. CONTRACTOR SHALL RESUBMIT THIS INFORMATION FOR ALL CHANGES TO LAYOUT AND BRACING THAT OCCUR AFTER ACCEPTANCE OF THE INITIAL SUBMITTAL.
- 19. STRUCTURAL DRAWINGS, INCLUDING PLANS, SECTIONS AND DETAILS INCLUDE INDIRECT REFERENCE TO DETAILS AND OTHER INFORMATION CONTAINED ELSEWHERE IN THE CONSTRUCTION DOCUMENTS. IT IS THE RESPONSIBILITY OF THE CONTRACTOR TO REQUEST CLARIFICATIONS PRIOR TO COMMENCEMENT OF THE WORK IF THE REFERENCED INFORMATION CANNOT BE FOUND OR CLEARLY INTERPRETED AS INTENDED.



ARCHITECTS

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TEL (562) 497-2999


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FIRE PROTECTION ENGINEER 5000 East Spring Street, Suite 800 Long Beach, CA 90815

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AGENCY APPROVAL

REVISIONS DESCRIPTION DATE 100% DD SUBMITTAL 03/01/2019 03/29/2019 PROGRESS SET

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MT. SAN JACINTO **COMMUNITY COLLEGE**

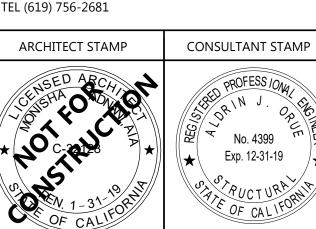PROJECT OWNER & TITLE

TEMECULA VALLEY

CAMPUS 41888 Motor Car Pkwy, Temecula, CA 92591

SHEET TITLE

DATE: Issue Date

DISTRICT

GENERAL NOTES

DRAWN BY: Author JOB NUMBER: 1800457

PARTIAL FOUNDATION PLAN

LEGEND:

STRENGTHENING OF CONC FOUNDATION SEE DETAILS

MT. SAN JACINTO

TEMECULA VALLEY CAMPUS

41888 Motor Car Pkwy,

PARTIAL

FOUNDATION PLAN

DRAWN BY: Author JOB NUMBER: 1800457

S-201.1

ARCHITECTS

802 EAST COTA STREET, SUITE A SANTA BARBARA, CA 93103 TEL (805) 963-1955

CONSULTANTS

<u>CIVIL ENGINEER</u> KPFF

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STRUCTURAL ENGINEER KPFF

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MECHANICAL ENGINEER P2S INC 5000 East Spring Street, Suite 800 Long Beach, CA 90815 TEL (562) 497-2999

ELECTRICAL ENGINEER
P2S INC 5000 East Spring Street, Suite 800

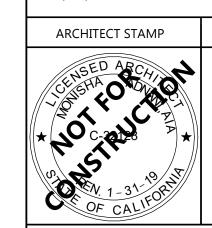
Long Beach, CA 90815 TEL (562) 497-2999

FIRE PROTECTION ENGINEER P2S INC 5000 East Spring Street, Suite 800

Long Beach, CA 90815 TEL (562) 497-2999

LABORATORY DESIGN CONSULTANT San Diego, CA 92103

3965 Fifth Avenue, Suite 400 TEL (619) 756-2681



AGENCY APPROVAL

CONSULTANT STAMP


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PROJECT OWNER & TITLE

COMMUNITY COLLEGE DISTRICT

Temecula, CA 92591 SHEET TITLE



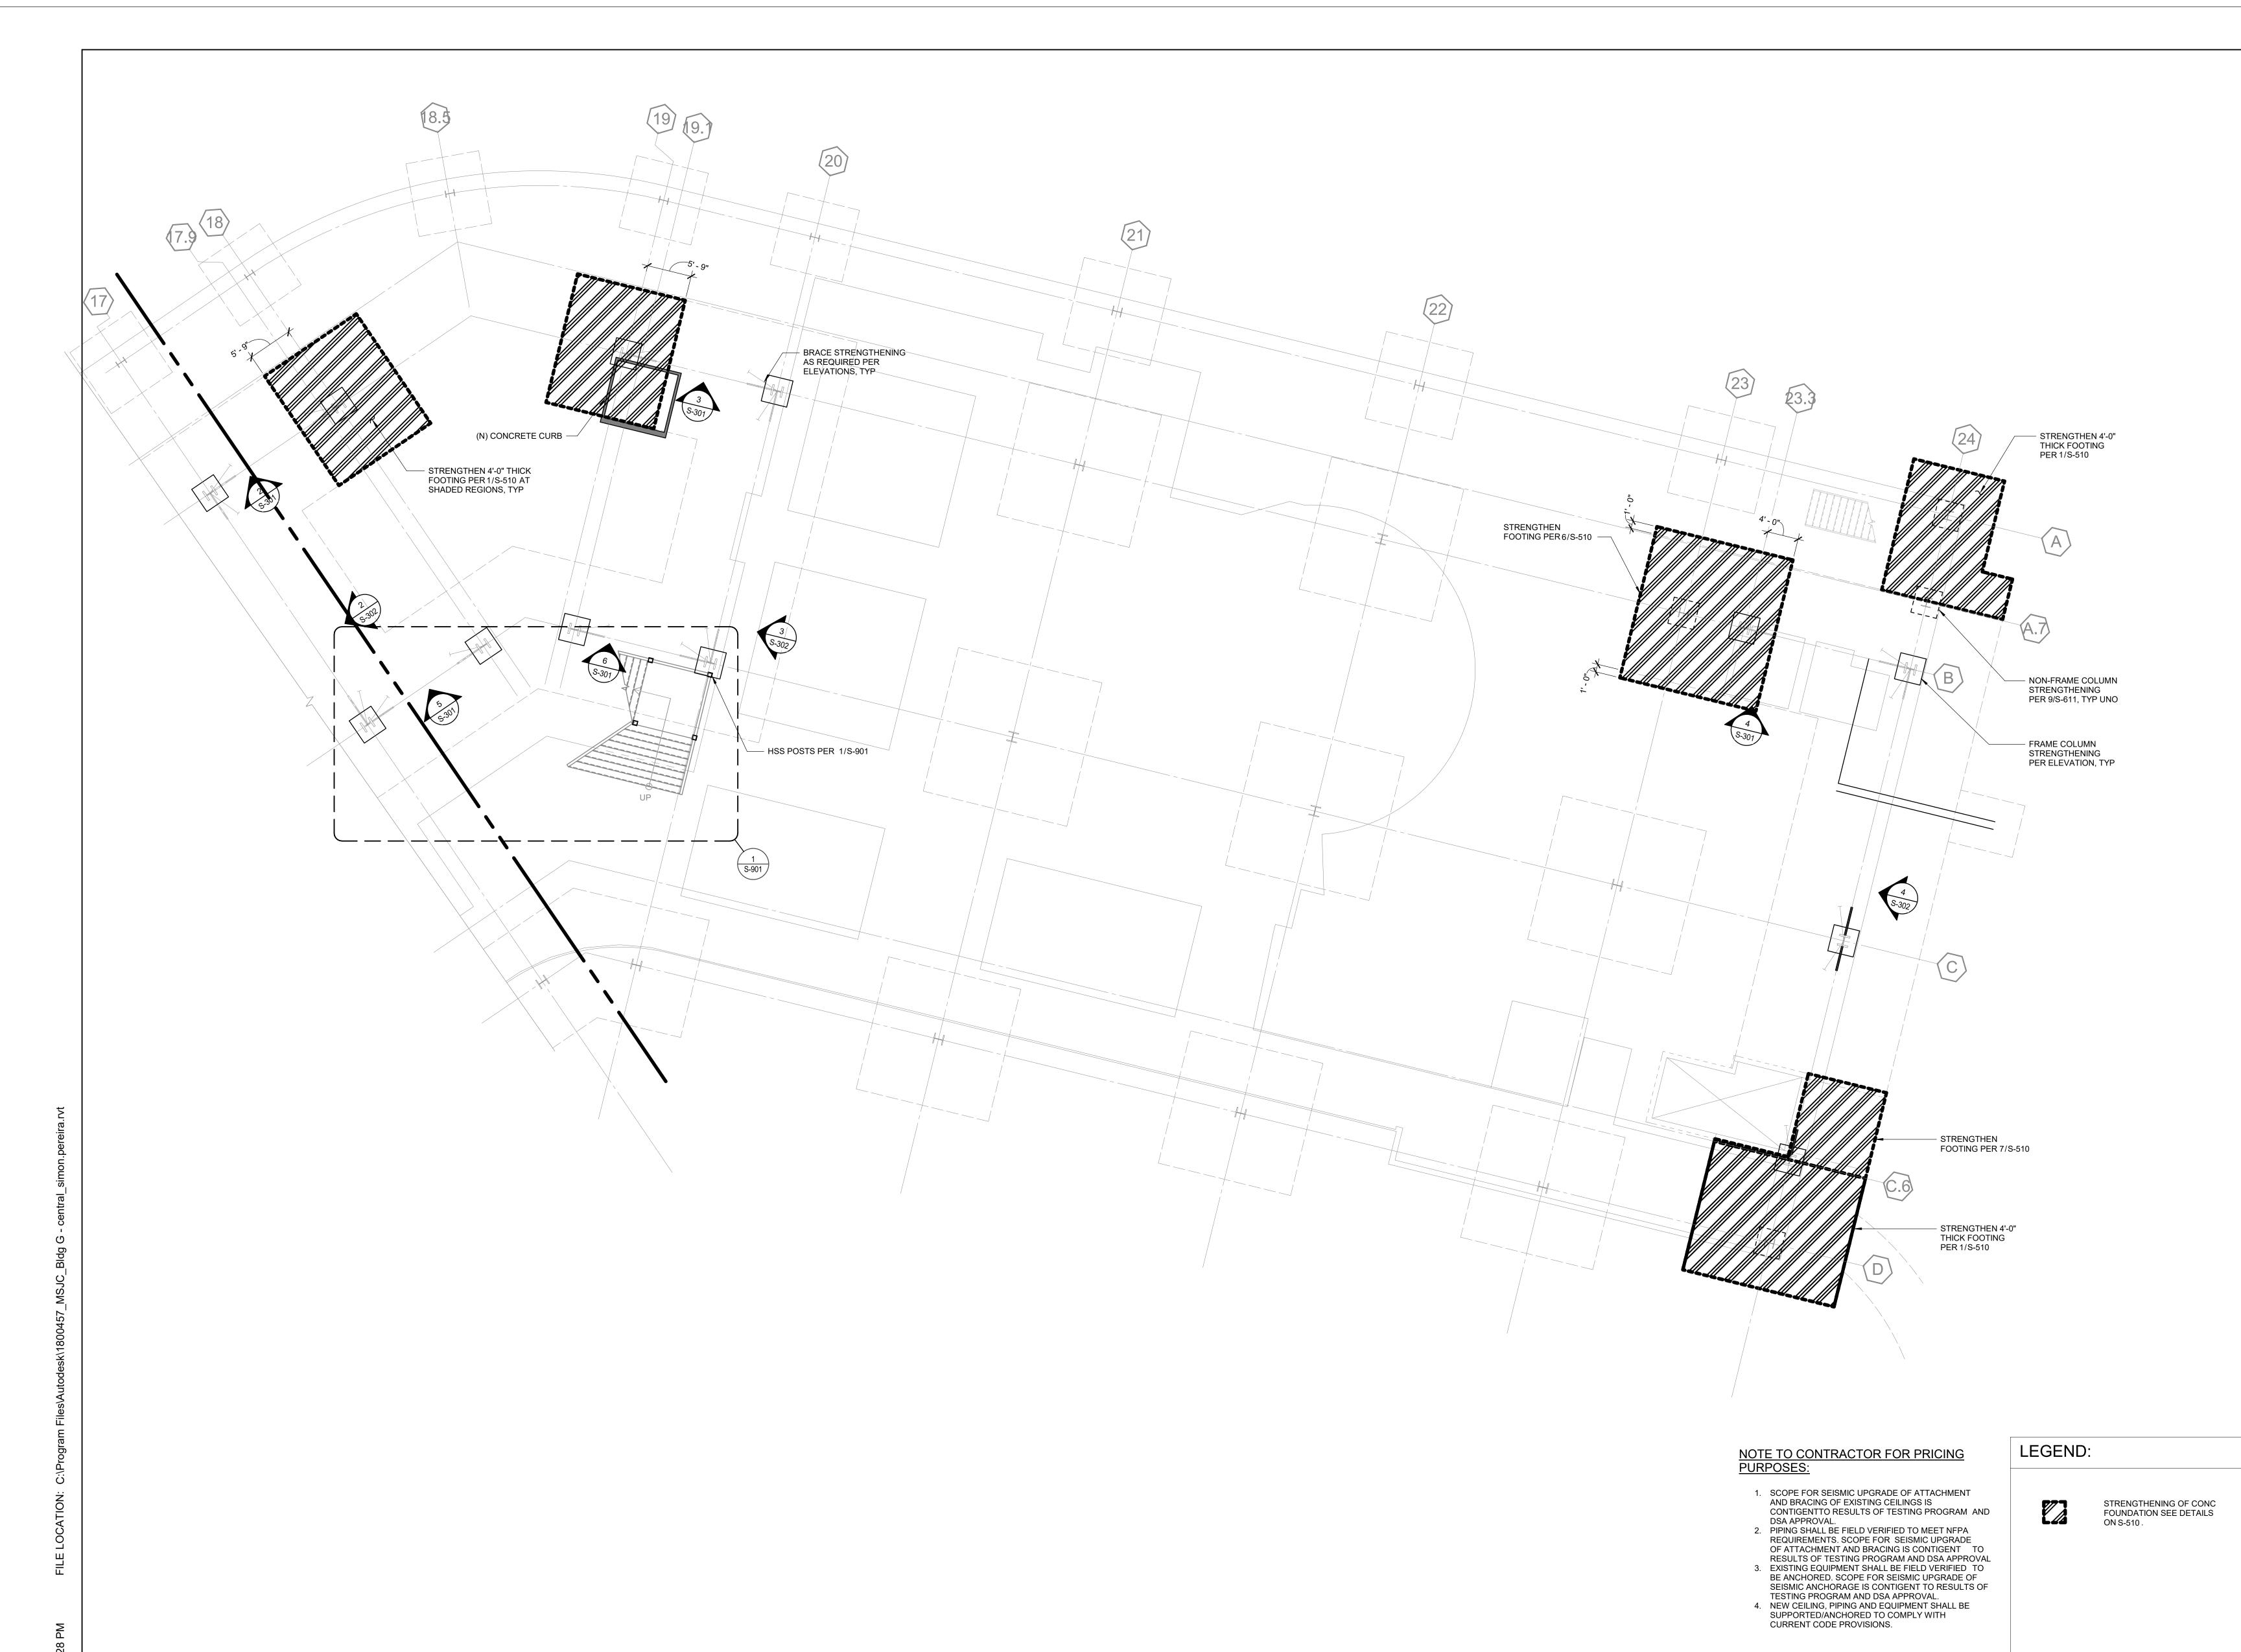PMSM ARCHITECTS ARCHITECTS 802 EAST COTA STREET, SUITE A

SANTA BARBARA, CA 93103 TEL (805) 963-1955

CONSULTANTS <u>CIVIL ENGINEER</u> KPFF

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Los Angekes, CA 90017 TEL (213) 310-8536 MECHANICAL ENGINEER P2S INC

5000 East Spring Street, Suite 800 Long Beach, CA 90815 TEL (562) 497-2999


ELECTRICAL ENGINEER P2S INC 5000 East Spring Street, Suite 800

Long Beach, CA 90815 TEL (562) 497-2999 <u>FIRE PROTECTION ENGINEER</u> P2S INC

5000 East Spring Street, Suite 800 Long Beach, CA 90815 TEL (562) 497-2999

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PROJECT OWNER & TITLE

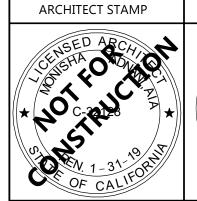MT. SAN JACINTO COMMUNITY COLLEGE DISTRICT

TEMECULA VALLEY CAMPUS

41888 Motor Car Pkwy, Temecula, CA 92591

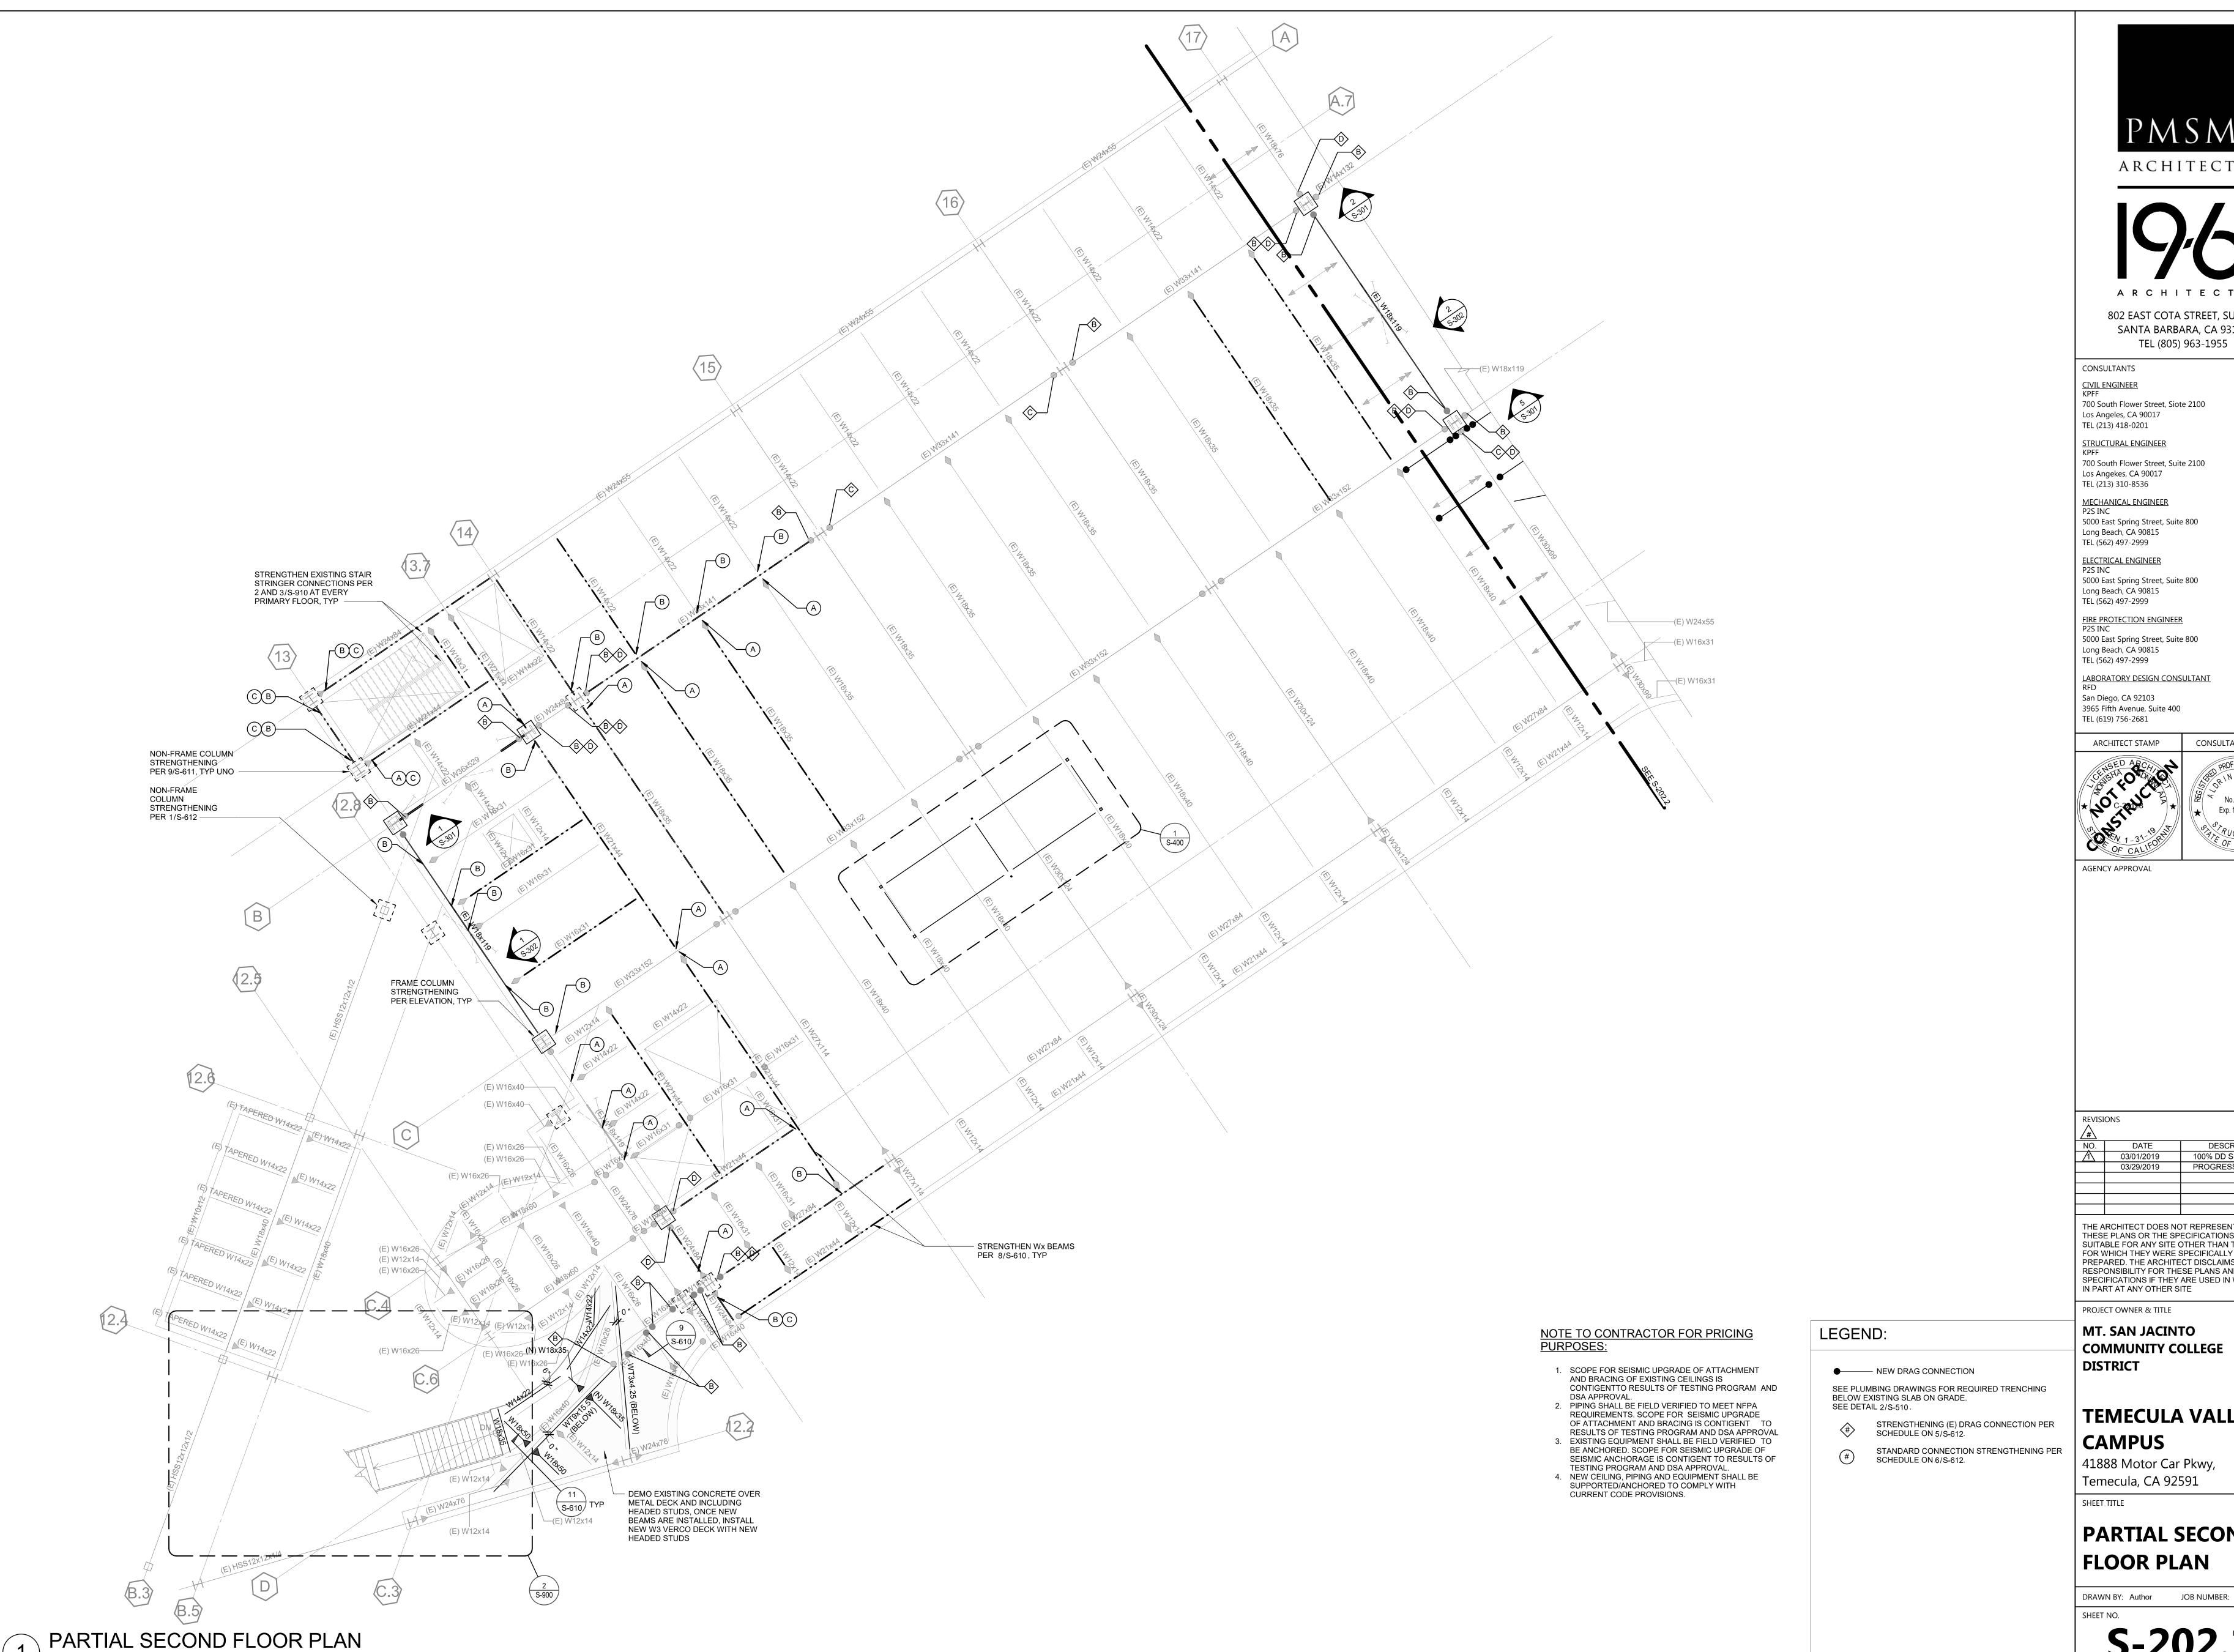
SHEET TITLE

DATE: Issue Date

PARTIAL **FOUNDATION PLAN**

DRAWN BY: Author JOB NUMBER: 1800457

S-201.2



ARCHITECTS

ARCHITECTS

802 EAST COTA STREET, SUITE A SANTA BARBARA, CA 93103

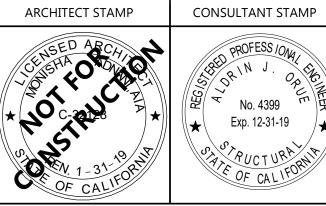
700 South Flower Street, Suite 2100

5000 East Spring Street, Suite 800

5000 East Spring Street, Suite 800

<u>FIRE PROTECTION ENGINEER</u> P2S INC 5000 East Spring Street, Suite 800

LABORATORY DESIGN CONSULTANT



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MT. SAN JACINTO **COMMUNITY COLLEGE**

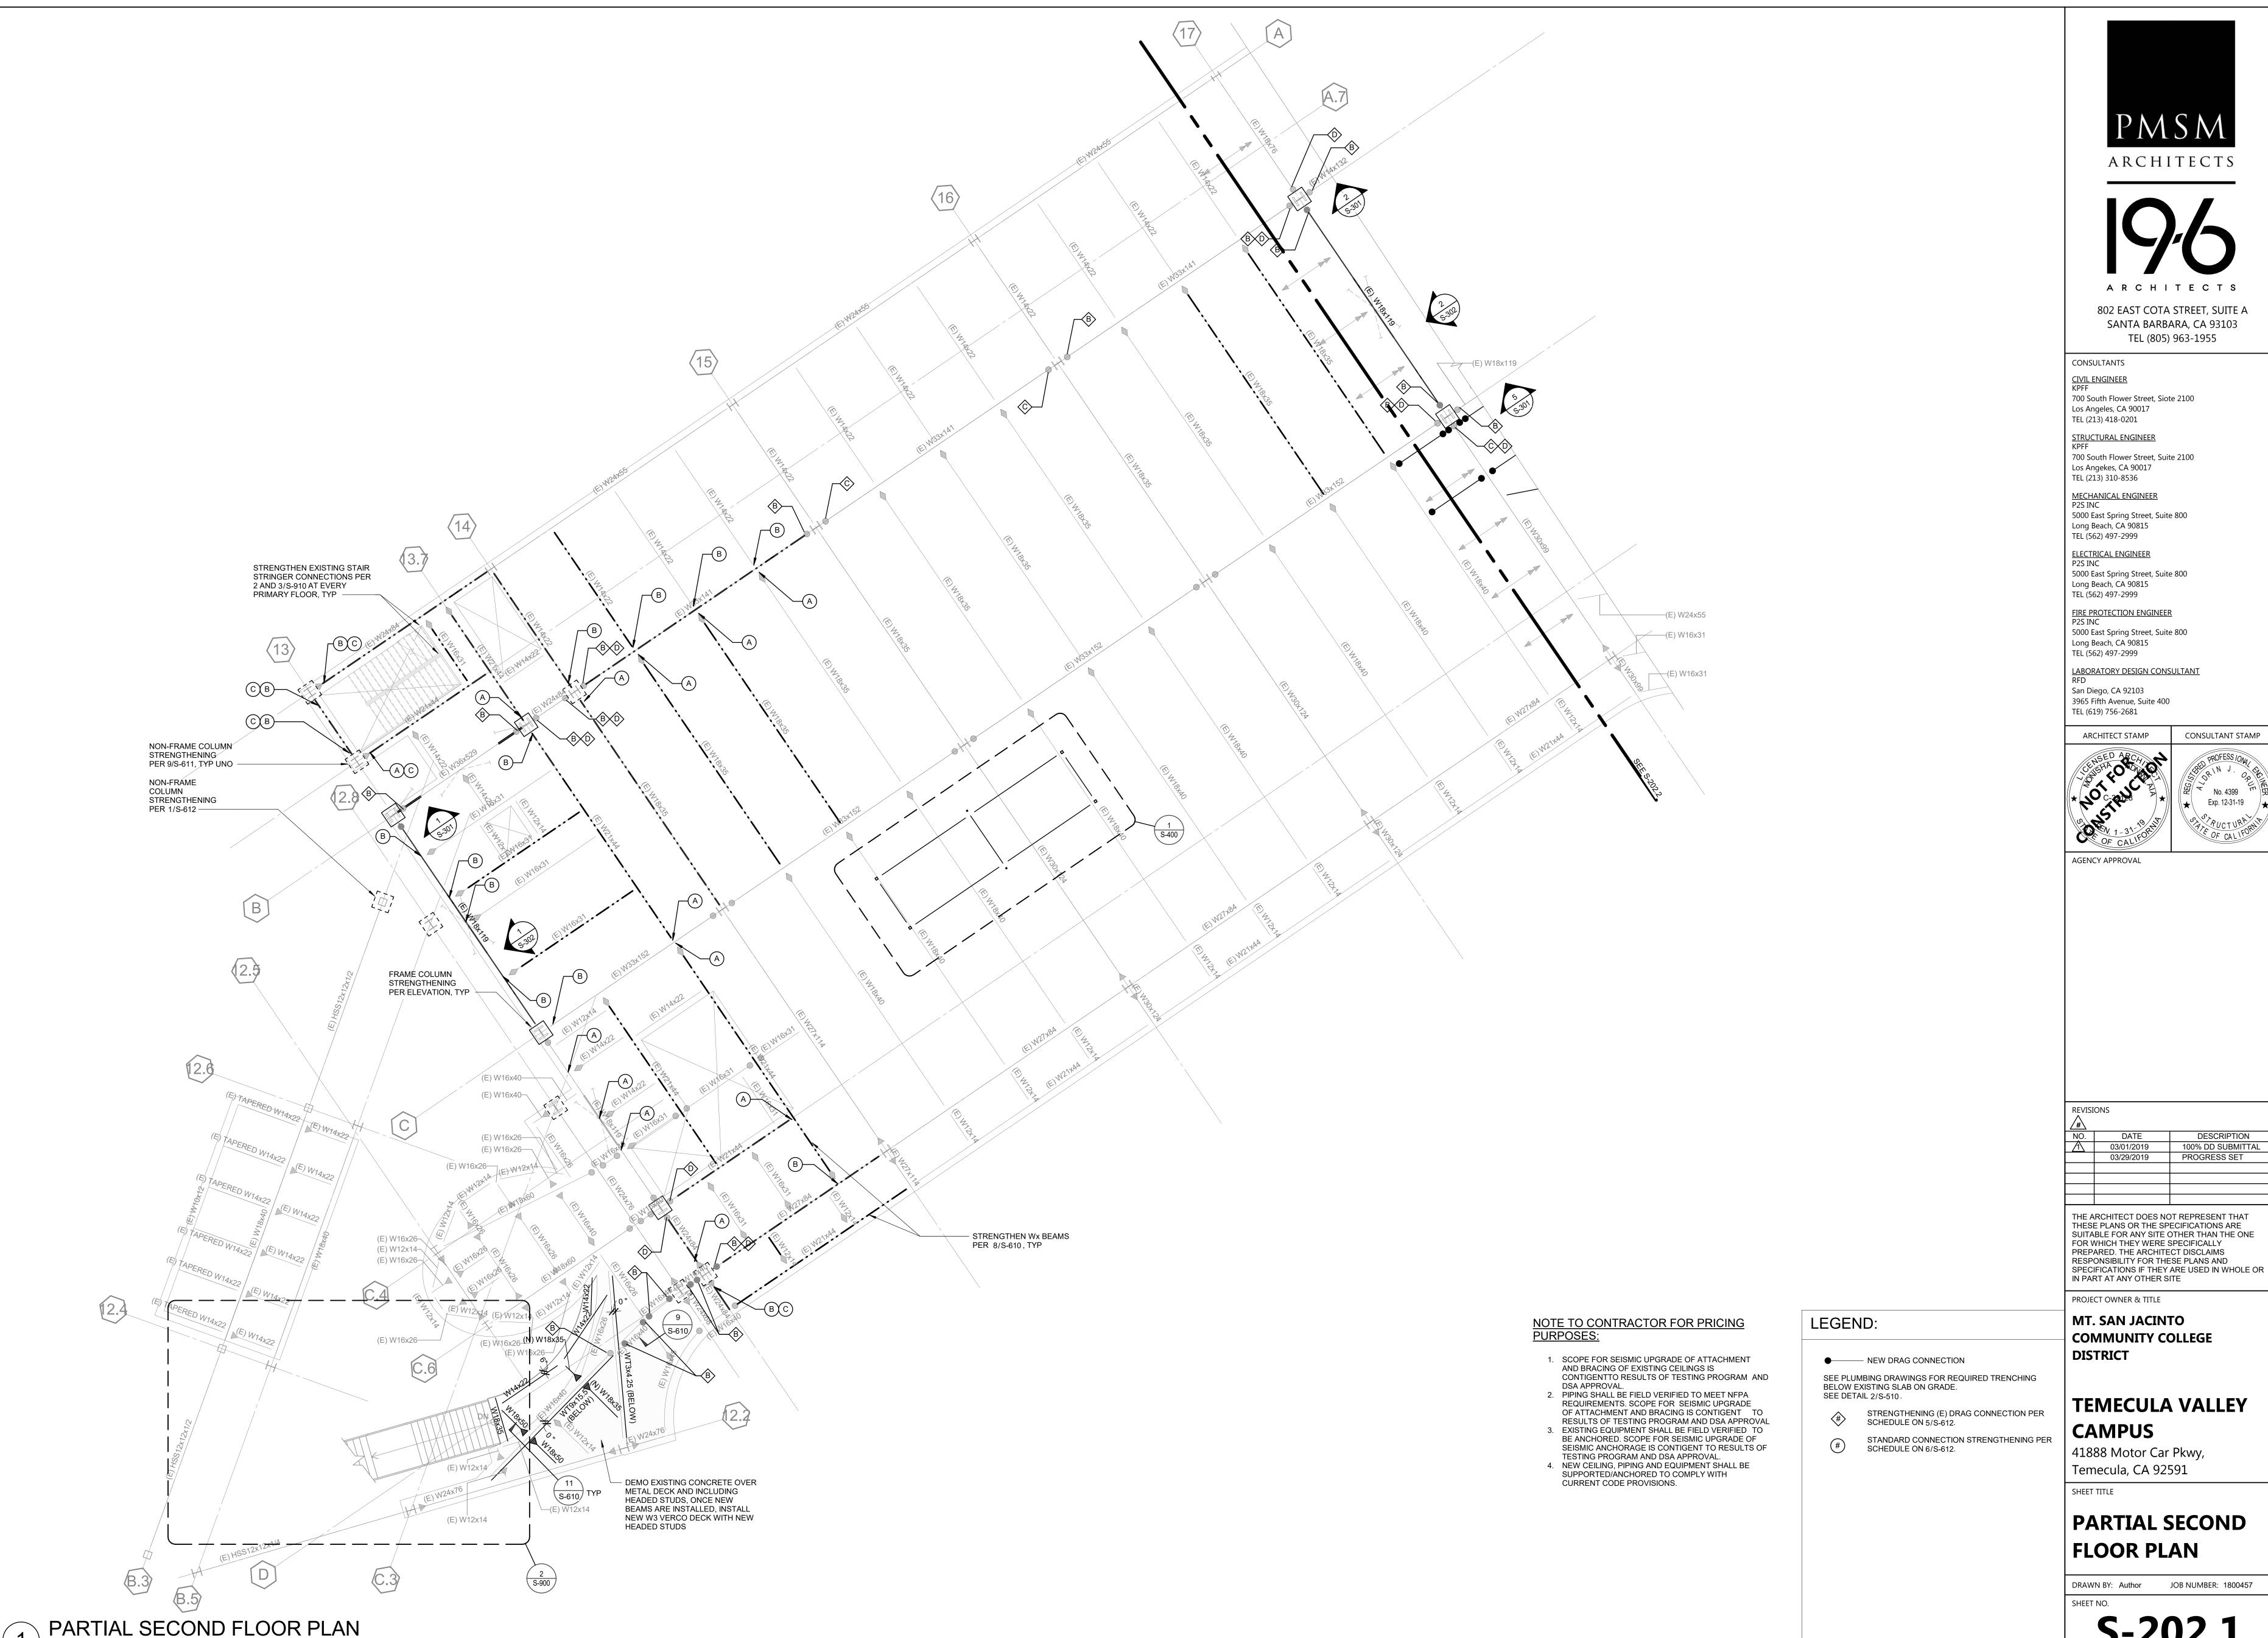
TEMECULA VALLEY

41888 Motor Car Pkwy,

PARTIAL SECOND **FLOOR PLAN**

DRAWN BY: Author JOB NUMBER: 1800457

S-202.1



ARCHITECTS

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802 EAST COTA STREET, SUITE A SANTA BARBARA, CA 93103 TEL (805) 963-1955

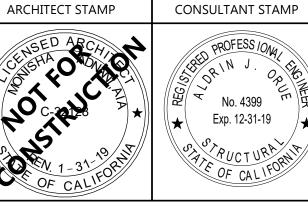
700 South Flower Street, Suite 2100

5000 East Spring Street, Suite 800

<u>FIRE PROTECTION ENGINEER</u> P2S INC

5000 East Spring Street, Suite 800

3965 Fifth Avenue, Suite 400



DESCRIPTION

PROGRESS SET THE ARCHITECT DOES NOT REPRESENT THAT THESE PLANS OR THE SPECIFICATIONS ARE

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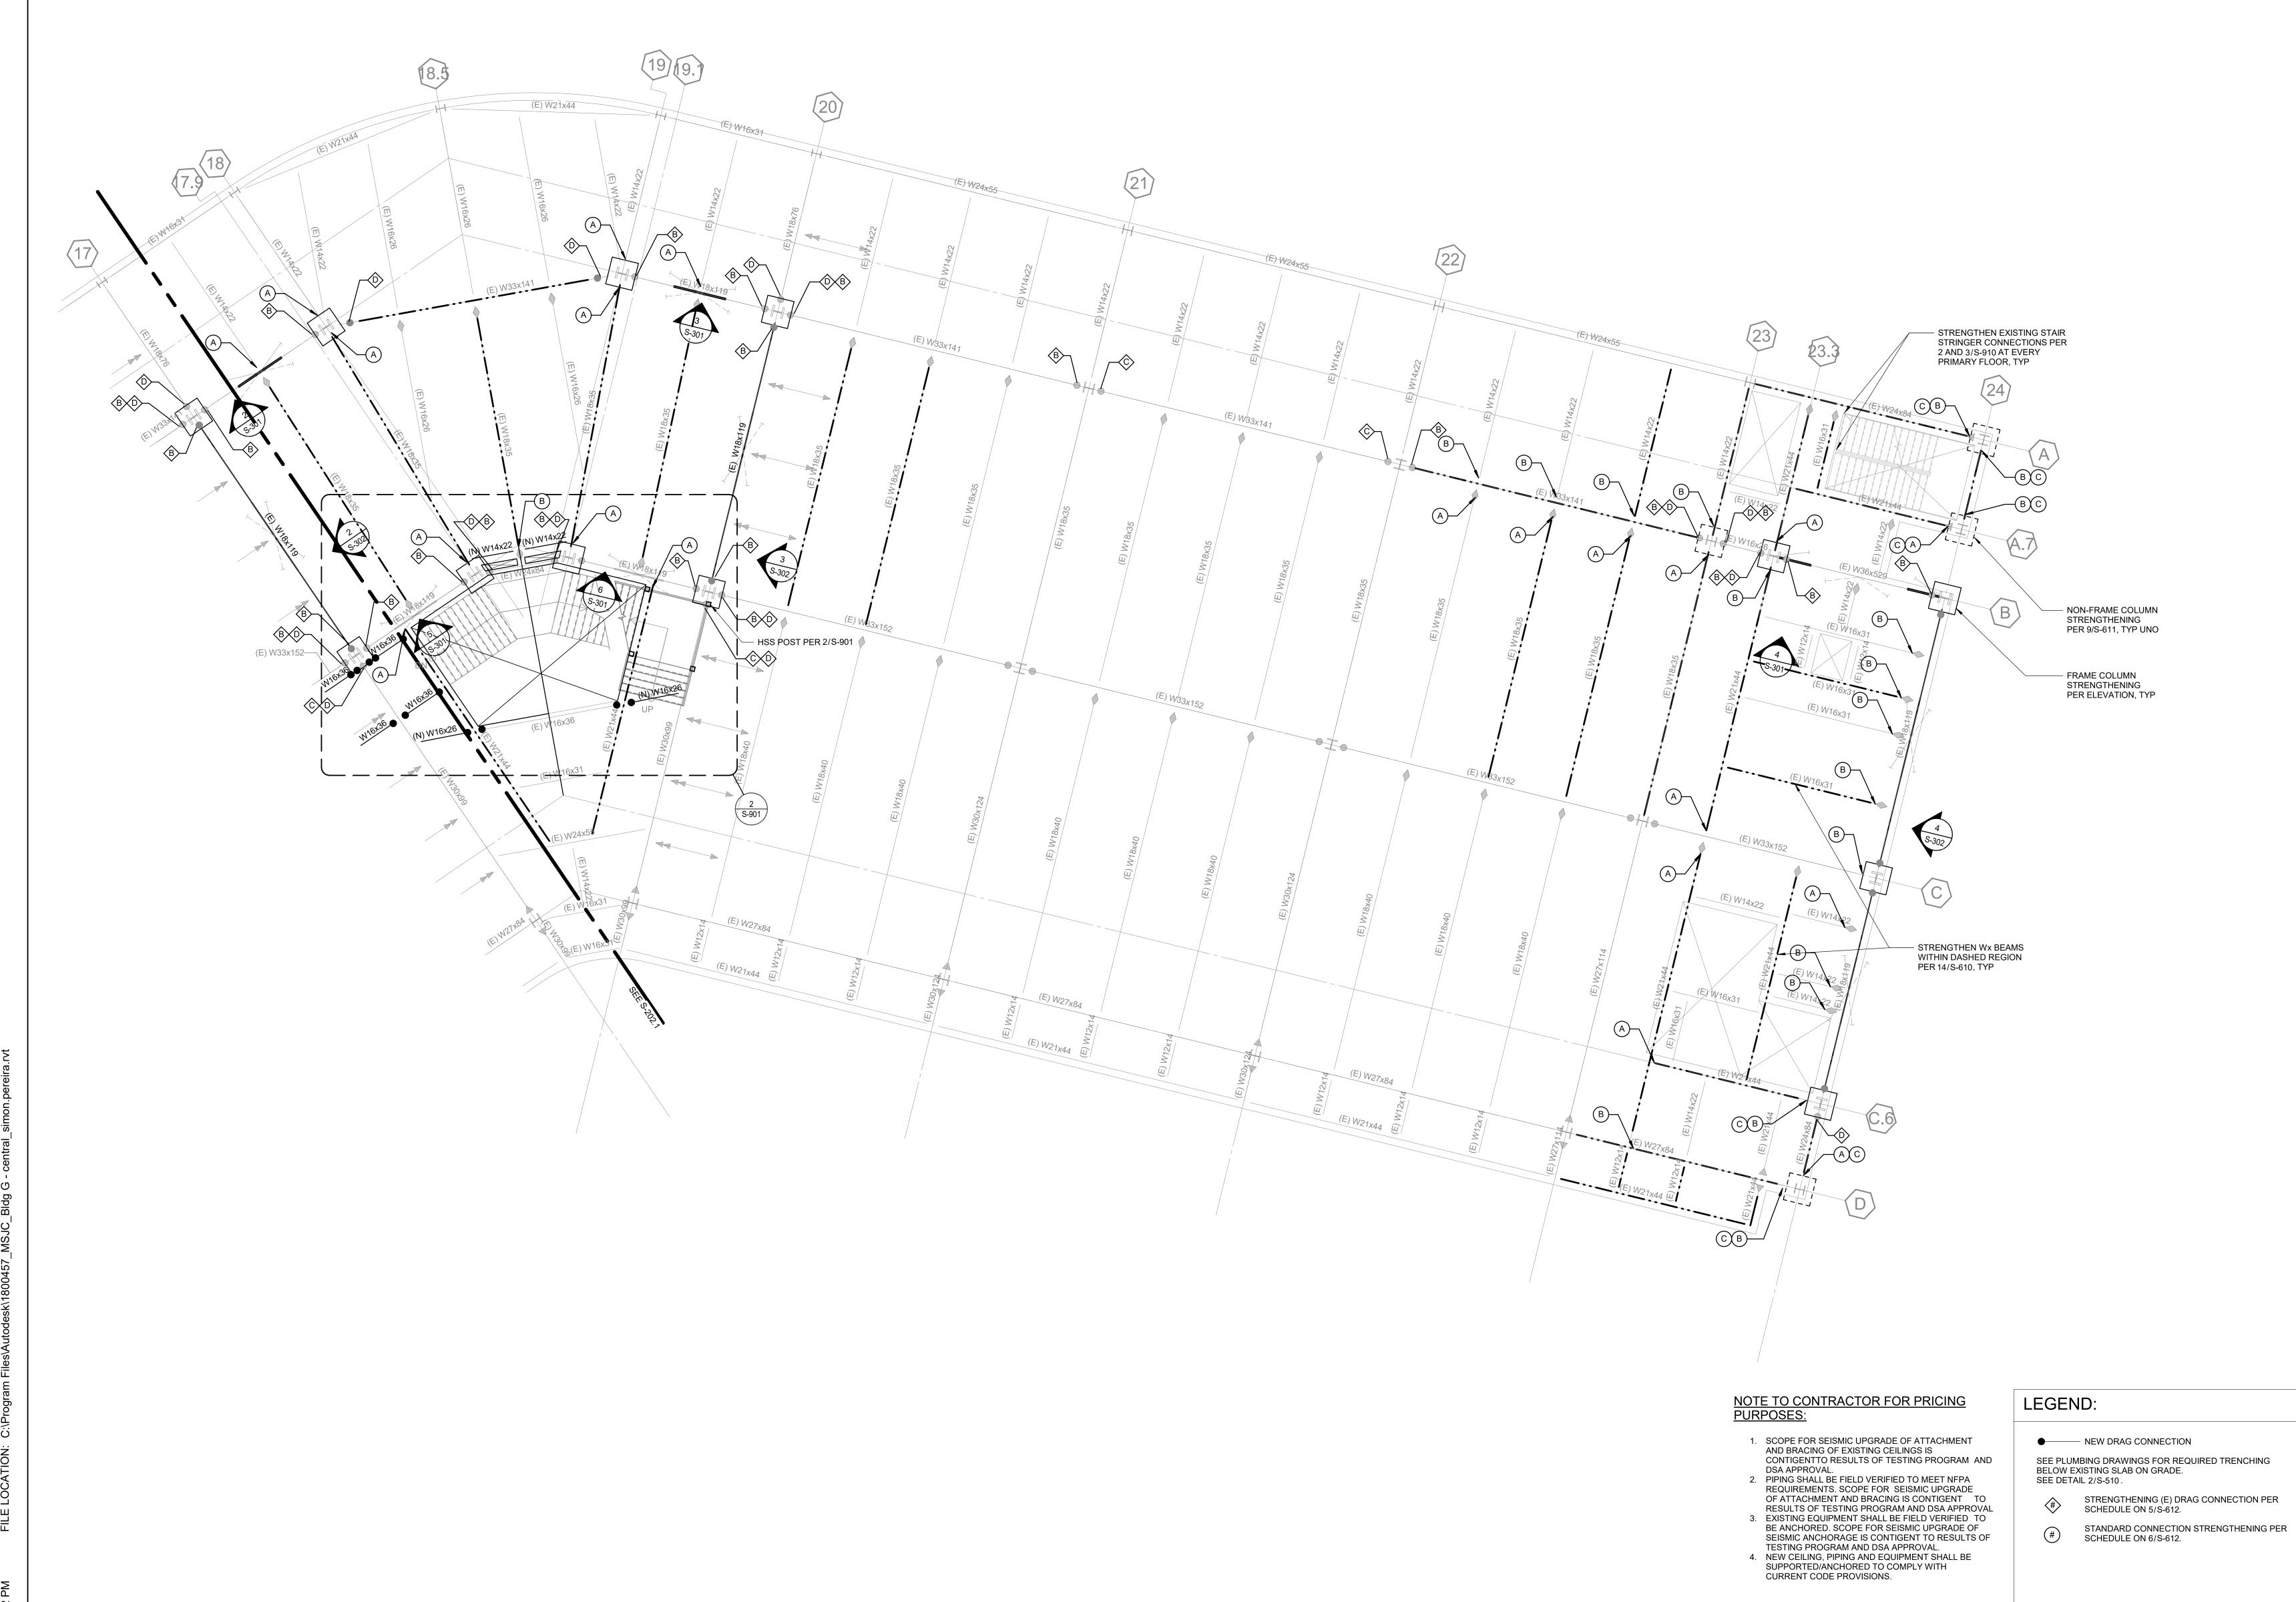
TEMECULA VALLEY

41888 Motor Car Pkwy,

PARTIAL SECOND

DRAWN BY: Author JOB NUMBER: 1800457

S-202.1



PMSM architects

A R C H I T E C T S

802 EAST COTA STREET, SUITE A SANTA BARBARA, CA 93103 TEL (805) 963-1955

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CIVIL ENGINEER
KPFF

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STRUCTURAL ENGINEER KPFF 700 South Flower Street Suite 2

700 South Flower Street, Suite 2100 Los Angekes, CA 90017 TEL (213) 310-8536

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5000 East Spring Street, Suite 800 Long Beach, CA 90815 TEL (562) 497-2999

ELECTRICAL ENGINEER P2S INC 5000 East Spring Street, Suite 800 Long Beach, CA 90815

Long Beach, CA 90815
TEL (562) 497-2999
FIRE PROTECTION ENGINEER

FIRE PROTECTION ENGINEER P2S INC 5000 East Spring Street, Suite 800 Long Beach, CA 90815 TEL (562) 497-2999

LABORATORY DESIGN CONSULTANT RFD San Diego, CA 92103 3965 Fifth Avenue, Suite 400

TEL (619) 756-2681

ARCHITECT STAMP

CONSULTANT STAMP

ROFESS 10M/
PROFESS 10M/
No. 4399
Exp. 12-31-19

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OF CALIFOR

AGENCY APPROVAL

REVISIONS

NO. DATE

03/01/2019 100% DD SUBMITTAL 03/29/2019 PROGRESS SET

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PROJECT OWNER & TITLE

MT. SAN JACINTO COMMUNITY COLLEGE DISTRICT

TEMECULA VALLEY CAMPUS

41888 Motor Car Pkwy, Temecula, CA 92591

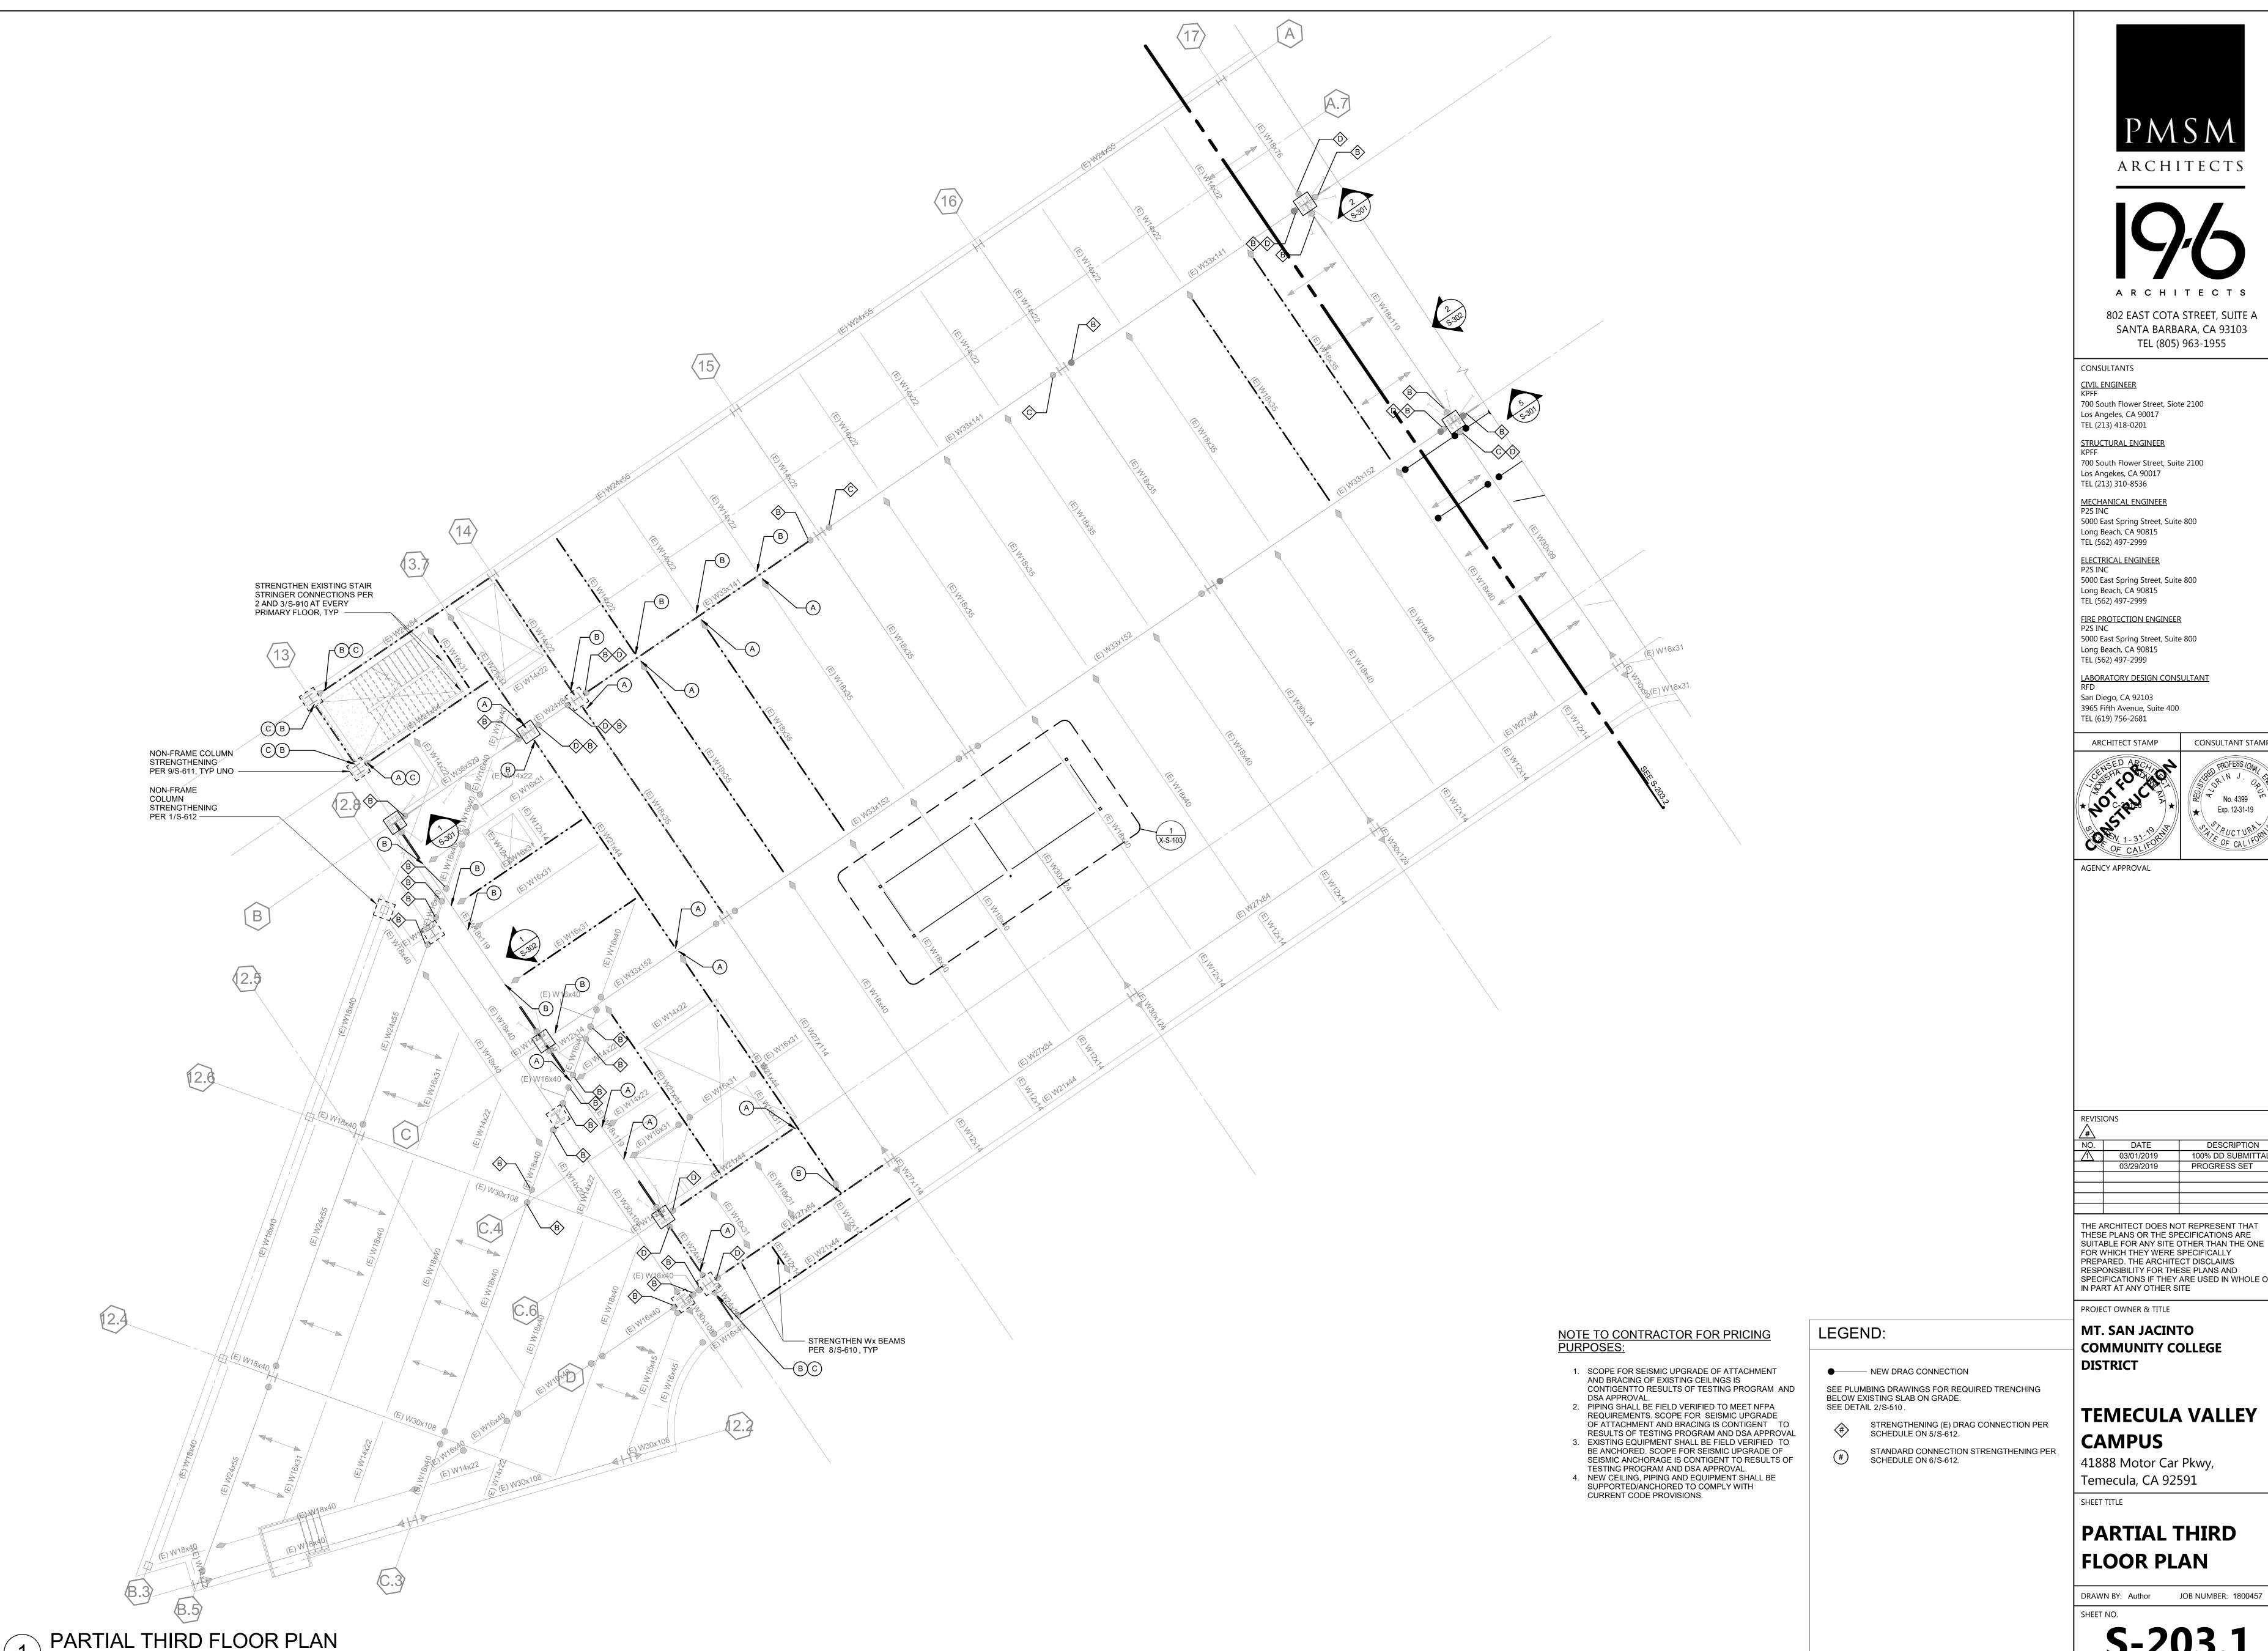
SHEET TITLE

DATE: Issue Date

PARTIAL SECOND FLOOR PLAN

DRAWN BY: Author JOB NUMBER: 1800457

S-202.2



ARCHITECTS

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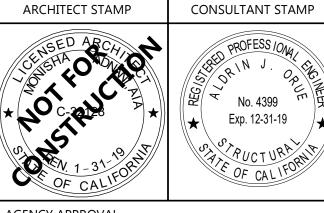
802 EAST COTA STREET, SUITE A SANTA BARBARA, CA 93103

700 South Flower Street, Siote 2100

5000 East Spring Street, Suite 800

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3965 Fifth Avenue, Suite 400



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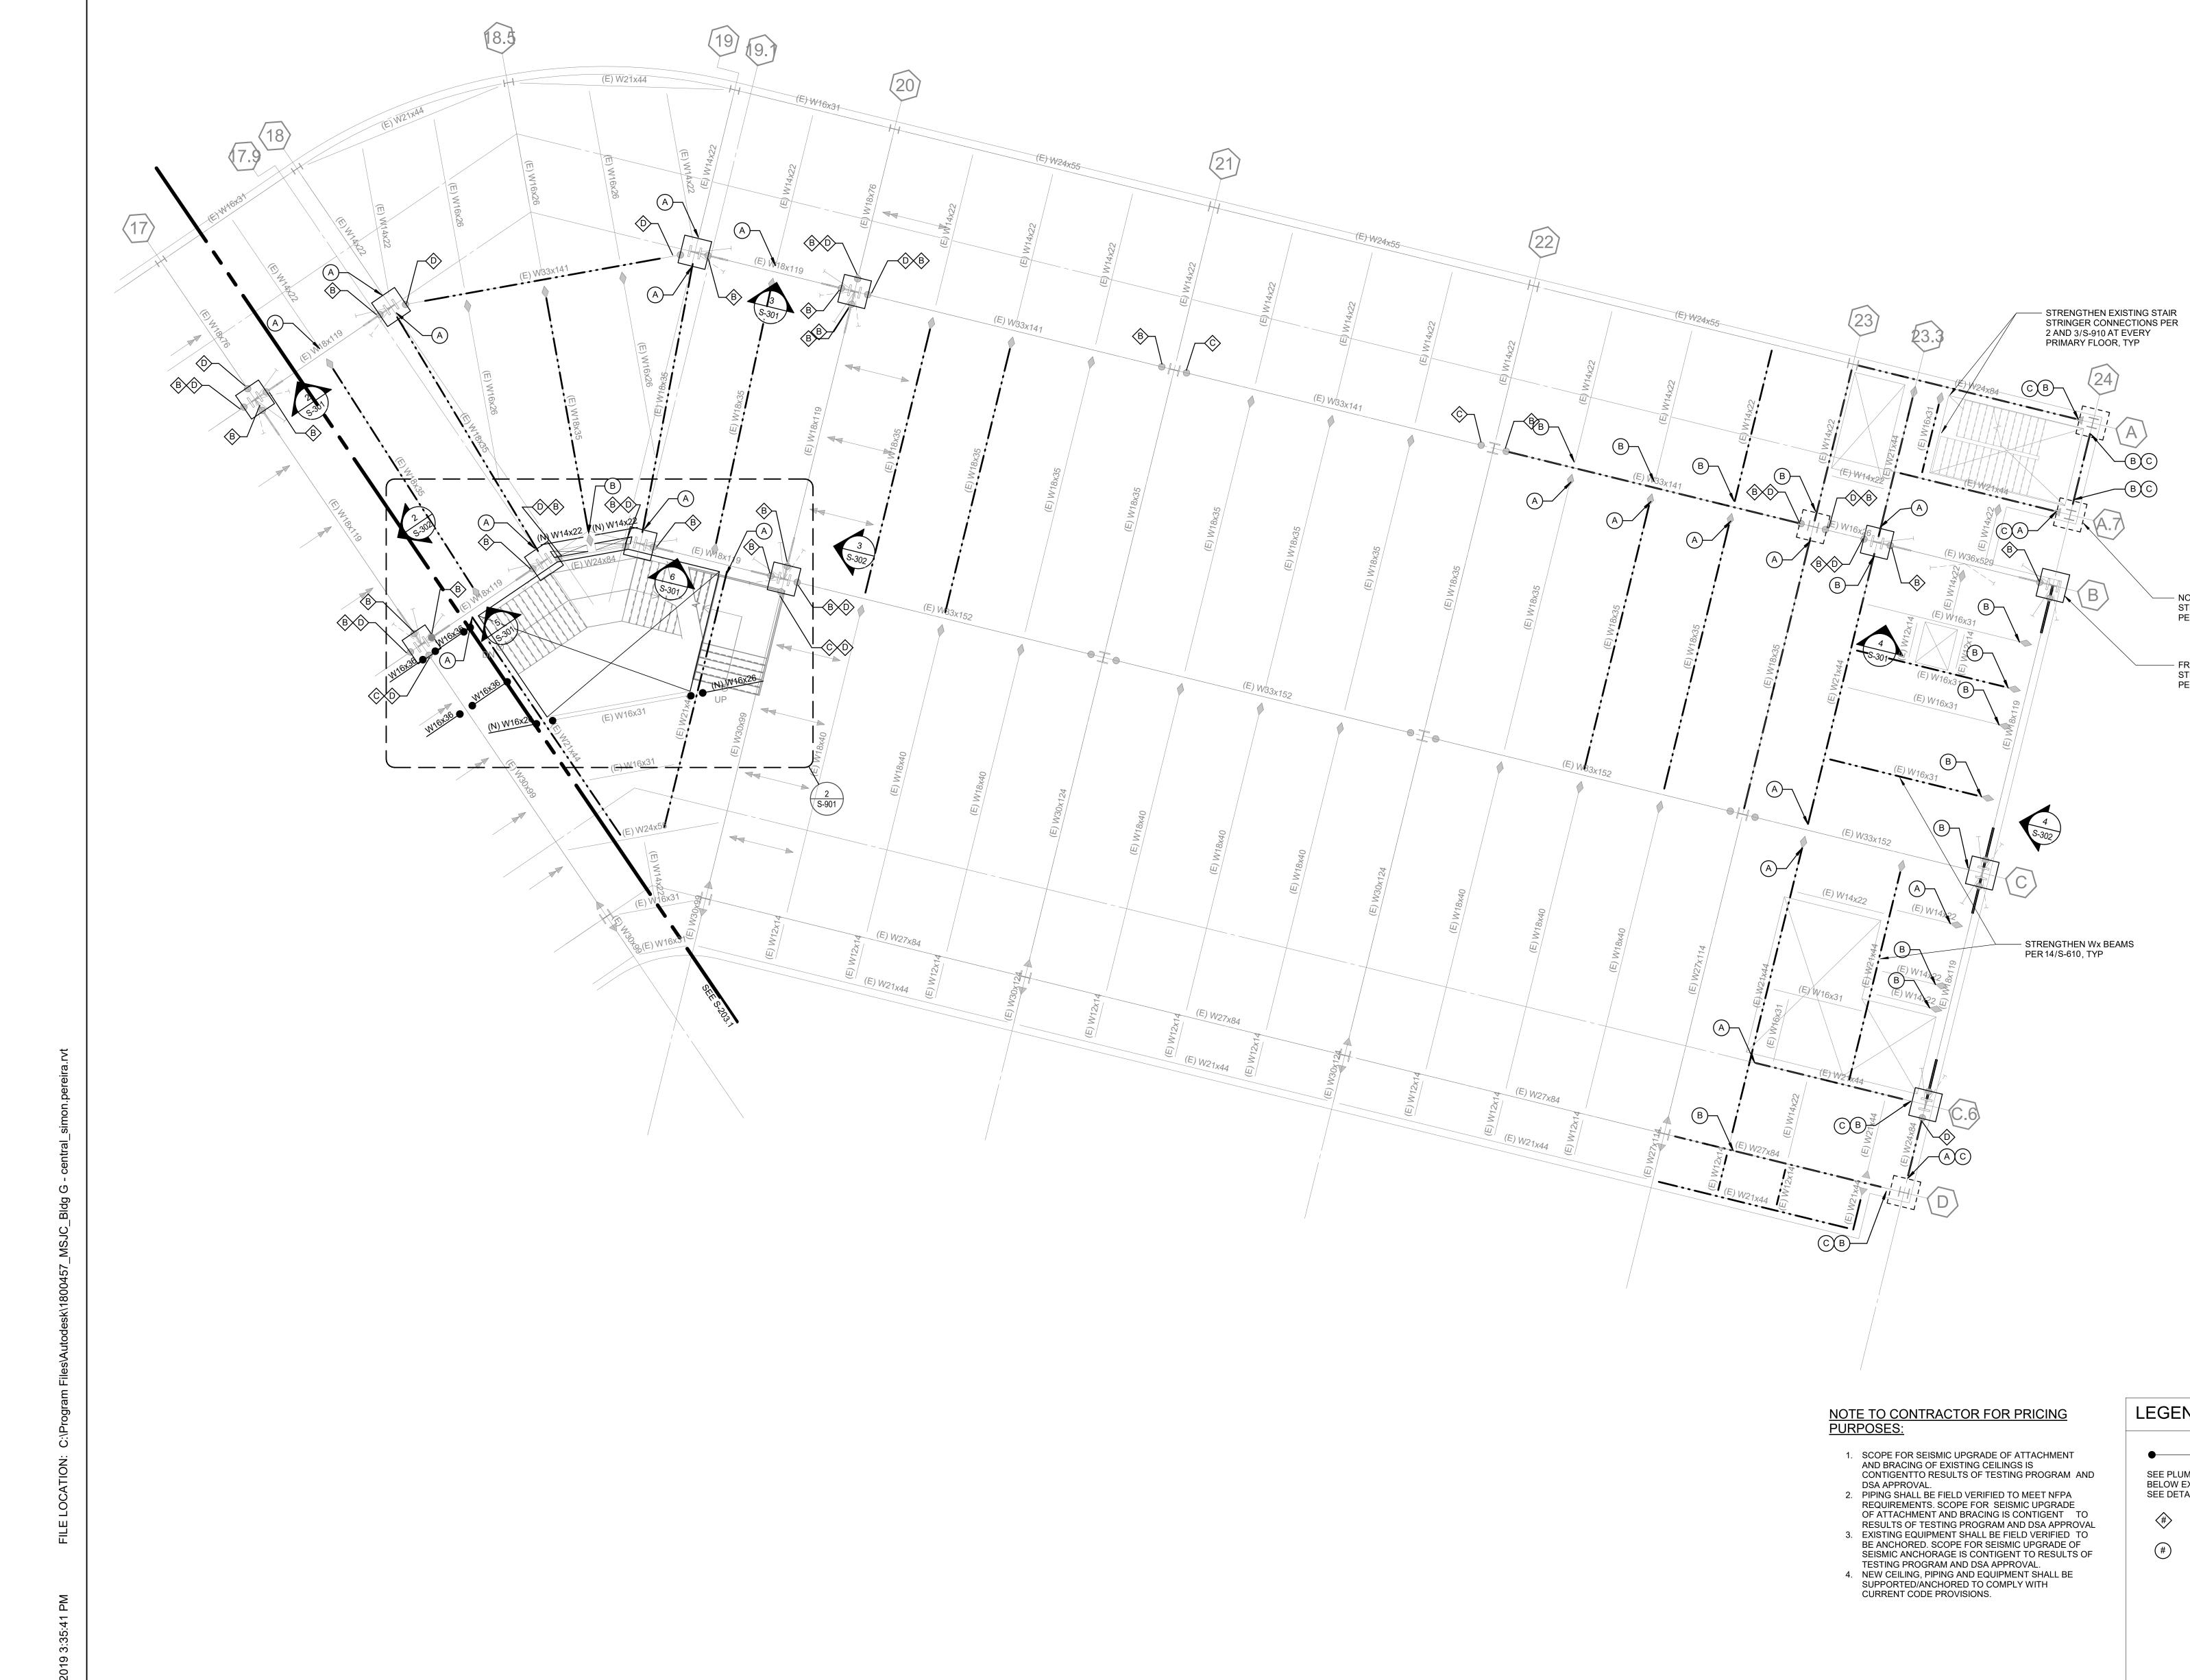
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MT. SAN JACINTO **COMMUNITY COLLEGE**

TEMECULA VALLEY

41888 Motor Car Pkwy,

PARTIAL THIRD FLOOR PLAN





802 EAST COTA STREET, SUITE A SANTA BARBARA, CA 93103 TEL (805) 963-1955

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700 South Flower Street, Siote 2100 Los Angeles, CA 90017 TEL (213) 418-0201

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TEL (562) 497-2999 FIRE PROTECTION ENGINEER P2S INC

Long Beach, CA 90815 TEL (562) 497-2999 LABORATORY DESIGN CONSULTANT

5000 East Spring Street, Suite 800

San Diego, CA 92103 3965 Fifth Avenue, Suite 400 TEL (619) 756-2681

— NON-FRAME COLUMN STRENGTHENING PER 9/S-611, TYP UNO

— FRAME COLUMN STRENGTHENING PER ELEVATION, TYP

LEGEND:

SEE DETAIL 2/S-510.

● NEW DRAG CONNECTION

SEE PLUMBING DRAWINGS FOR REQUIRED TRENCHING BELOW EXISTING SLAB ON GRADE.

STRENGTHENING (E) DRAG CONNECTION PER SCHEDULE ON 5/S-612.

STANDARD CONNECTION STRENGTHENING PER SCHEDULE ON 6/S-612.

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AGENCY APPROVAL

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PROJECT OWNER & TITLE

MT. SAN JACINTO **COMMUNITY COLLEGE** DISTRICT

TEMECULA VALLEY CAMPUS

41888 Motor Car Pkwy, Temecula, CA 92591

SHEET TITLE

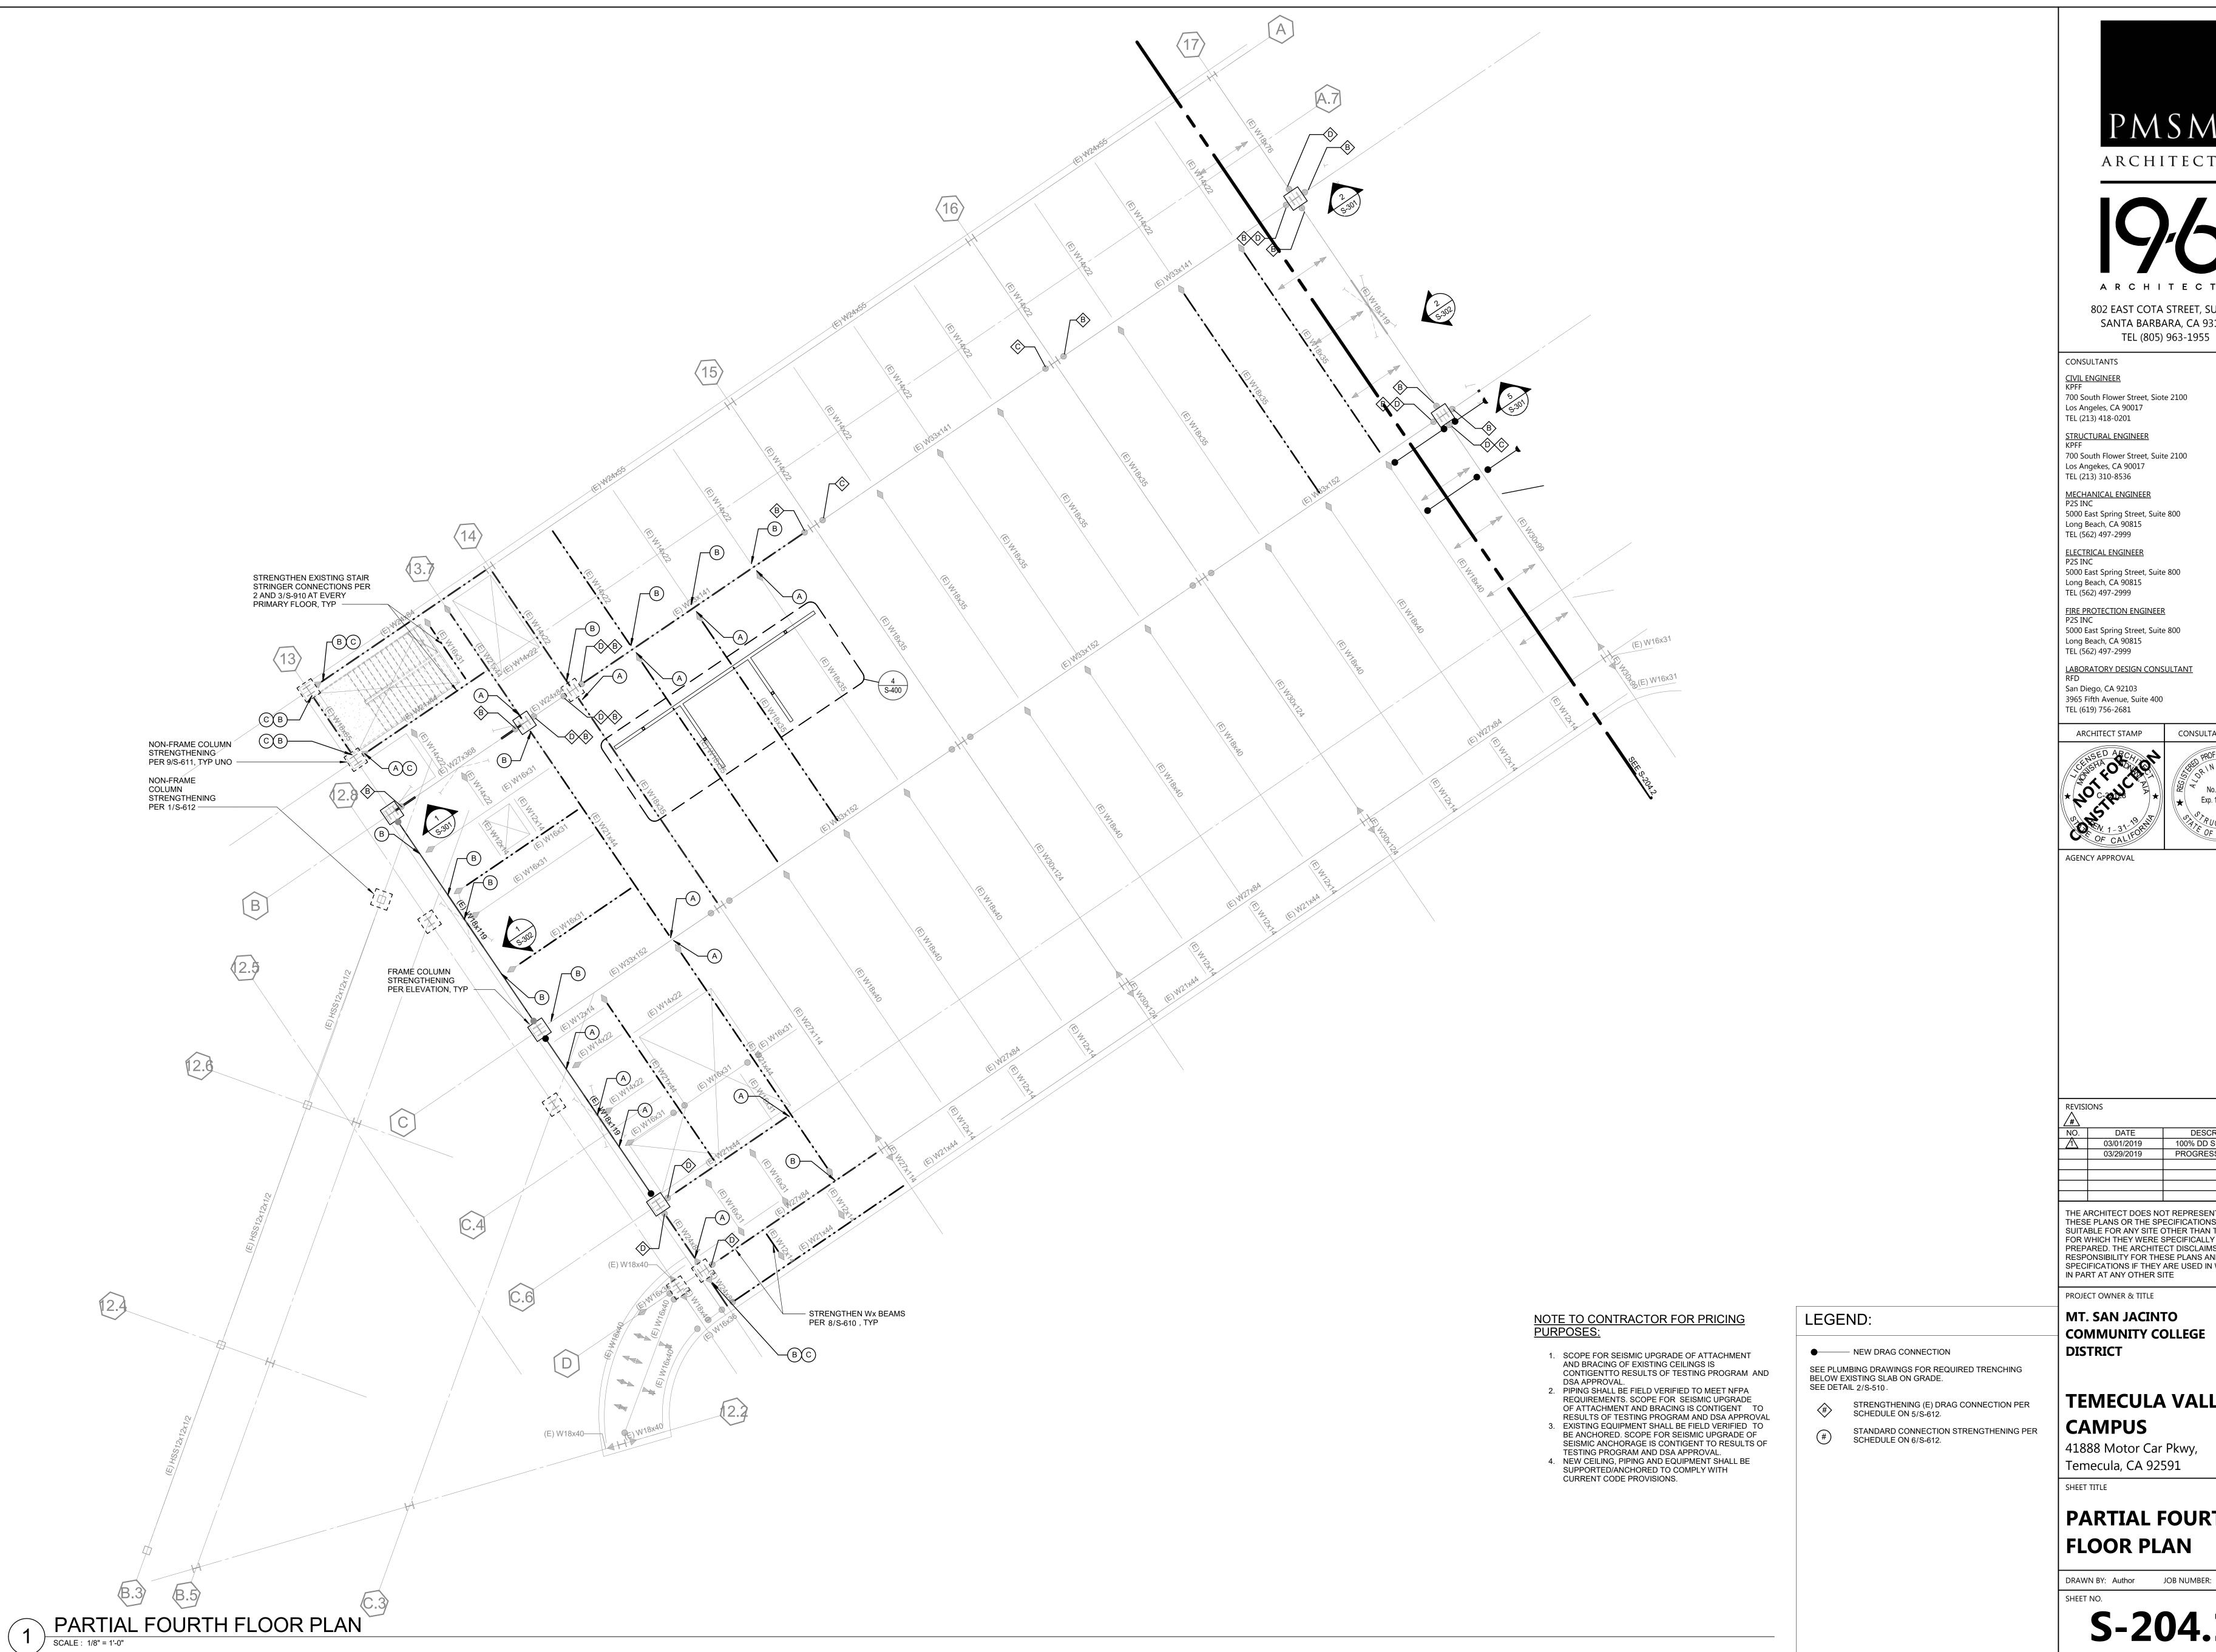
PARTIAL THIRD FLOOR PLAN

DRAWN BY: Author JOB NUMBER: 1800457

S-203.2

DATE: Issue Date

PARTIAL THIRD FLOOR PLAN



ARCHITECTS

ARCHITECTS

802 EAST COTA STREET, SUITE A SANTA BARBARA, CA 93103

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5000 East Spring Street, Suite 800

LABORATORY DESIGN CONSULTANT



CONSULTANT STAMP

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COMMUNITY COLLEGE

TEMECULA VALLEY

41888 Motor Car Pkwy,

PARTIAL FOURTH

DRAWN BY: Author JOB NUMBER: 1800457

S-204.1

802 EAST COTA STREET, SUITE A SANTA BARBARA, CA 93103 TEL (805) 963-1955

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700 South Flower Street, Siote 2100 Los Angeles, CA 90017 TEL (213) 418-0201

STRUCTURAL ENGINEER KPFF

700 South Flower Street, Suite 2100 Los Angekes, CA 90017 TEL (213) 310-8536

MECHANICAL ENGINEER P2S INC 5000 East Spring Street, Suite 800 Long Beach, CA 90815

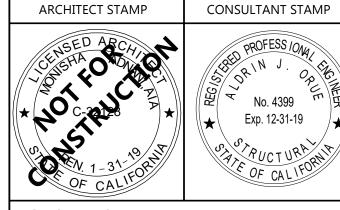
TEL (562) 497-2999 ELECTRICAL ENGINEER P2S INC

5000 East Spring Street, Suite 800 Long Beach, CA 90815 TEL (562) 497-2999

FIRE PROTECTION ENGINEER P2S INC 5000 East Spring Street, Suite 800 Long Beach, CA 90815 TEL (562) 497-2999

LABORATORY DESIGN CONSULTANT

San Diego, CA 92103 3965 Fifth Avenue, Suite 400 TEL (619) 756-2681



AGENCY APPROVAL

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PROJECT OWNER & TITLE

MT. SAN JACINTO **COMMUNITY COLLEGE** DISTRICT

TEMECULA VALLEY CAMPUS

41888 Motor Car Pkwy, Temecula, CA 92591

SHEET TITLE

DATE: Issue Date

STANDARD CONNECTION STRENGTHENING PER SCHEDULE ON 6/S-612.

RESULTS OF TESTING PROGRAM AND DSA APPROVAL

3. EXISTING EQUIPMENT SHALL BE FIELD VERIFIED TO

TESTING PROGRAM AND DSA APPROVAL. 4. NEW CEILING, PIPING AND EQUIPMENT SHALL BE

SUPPORTED/ANCHORED TO COMPLY WITH CURRENT CODE PROVISIONS.

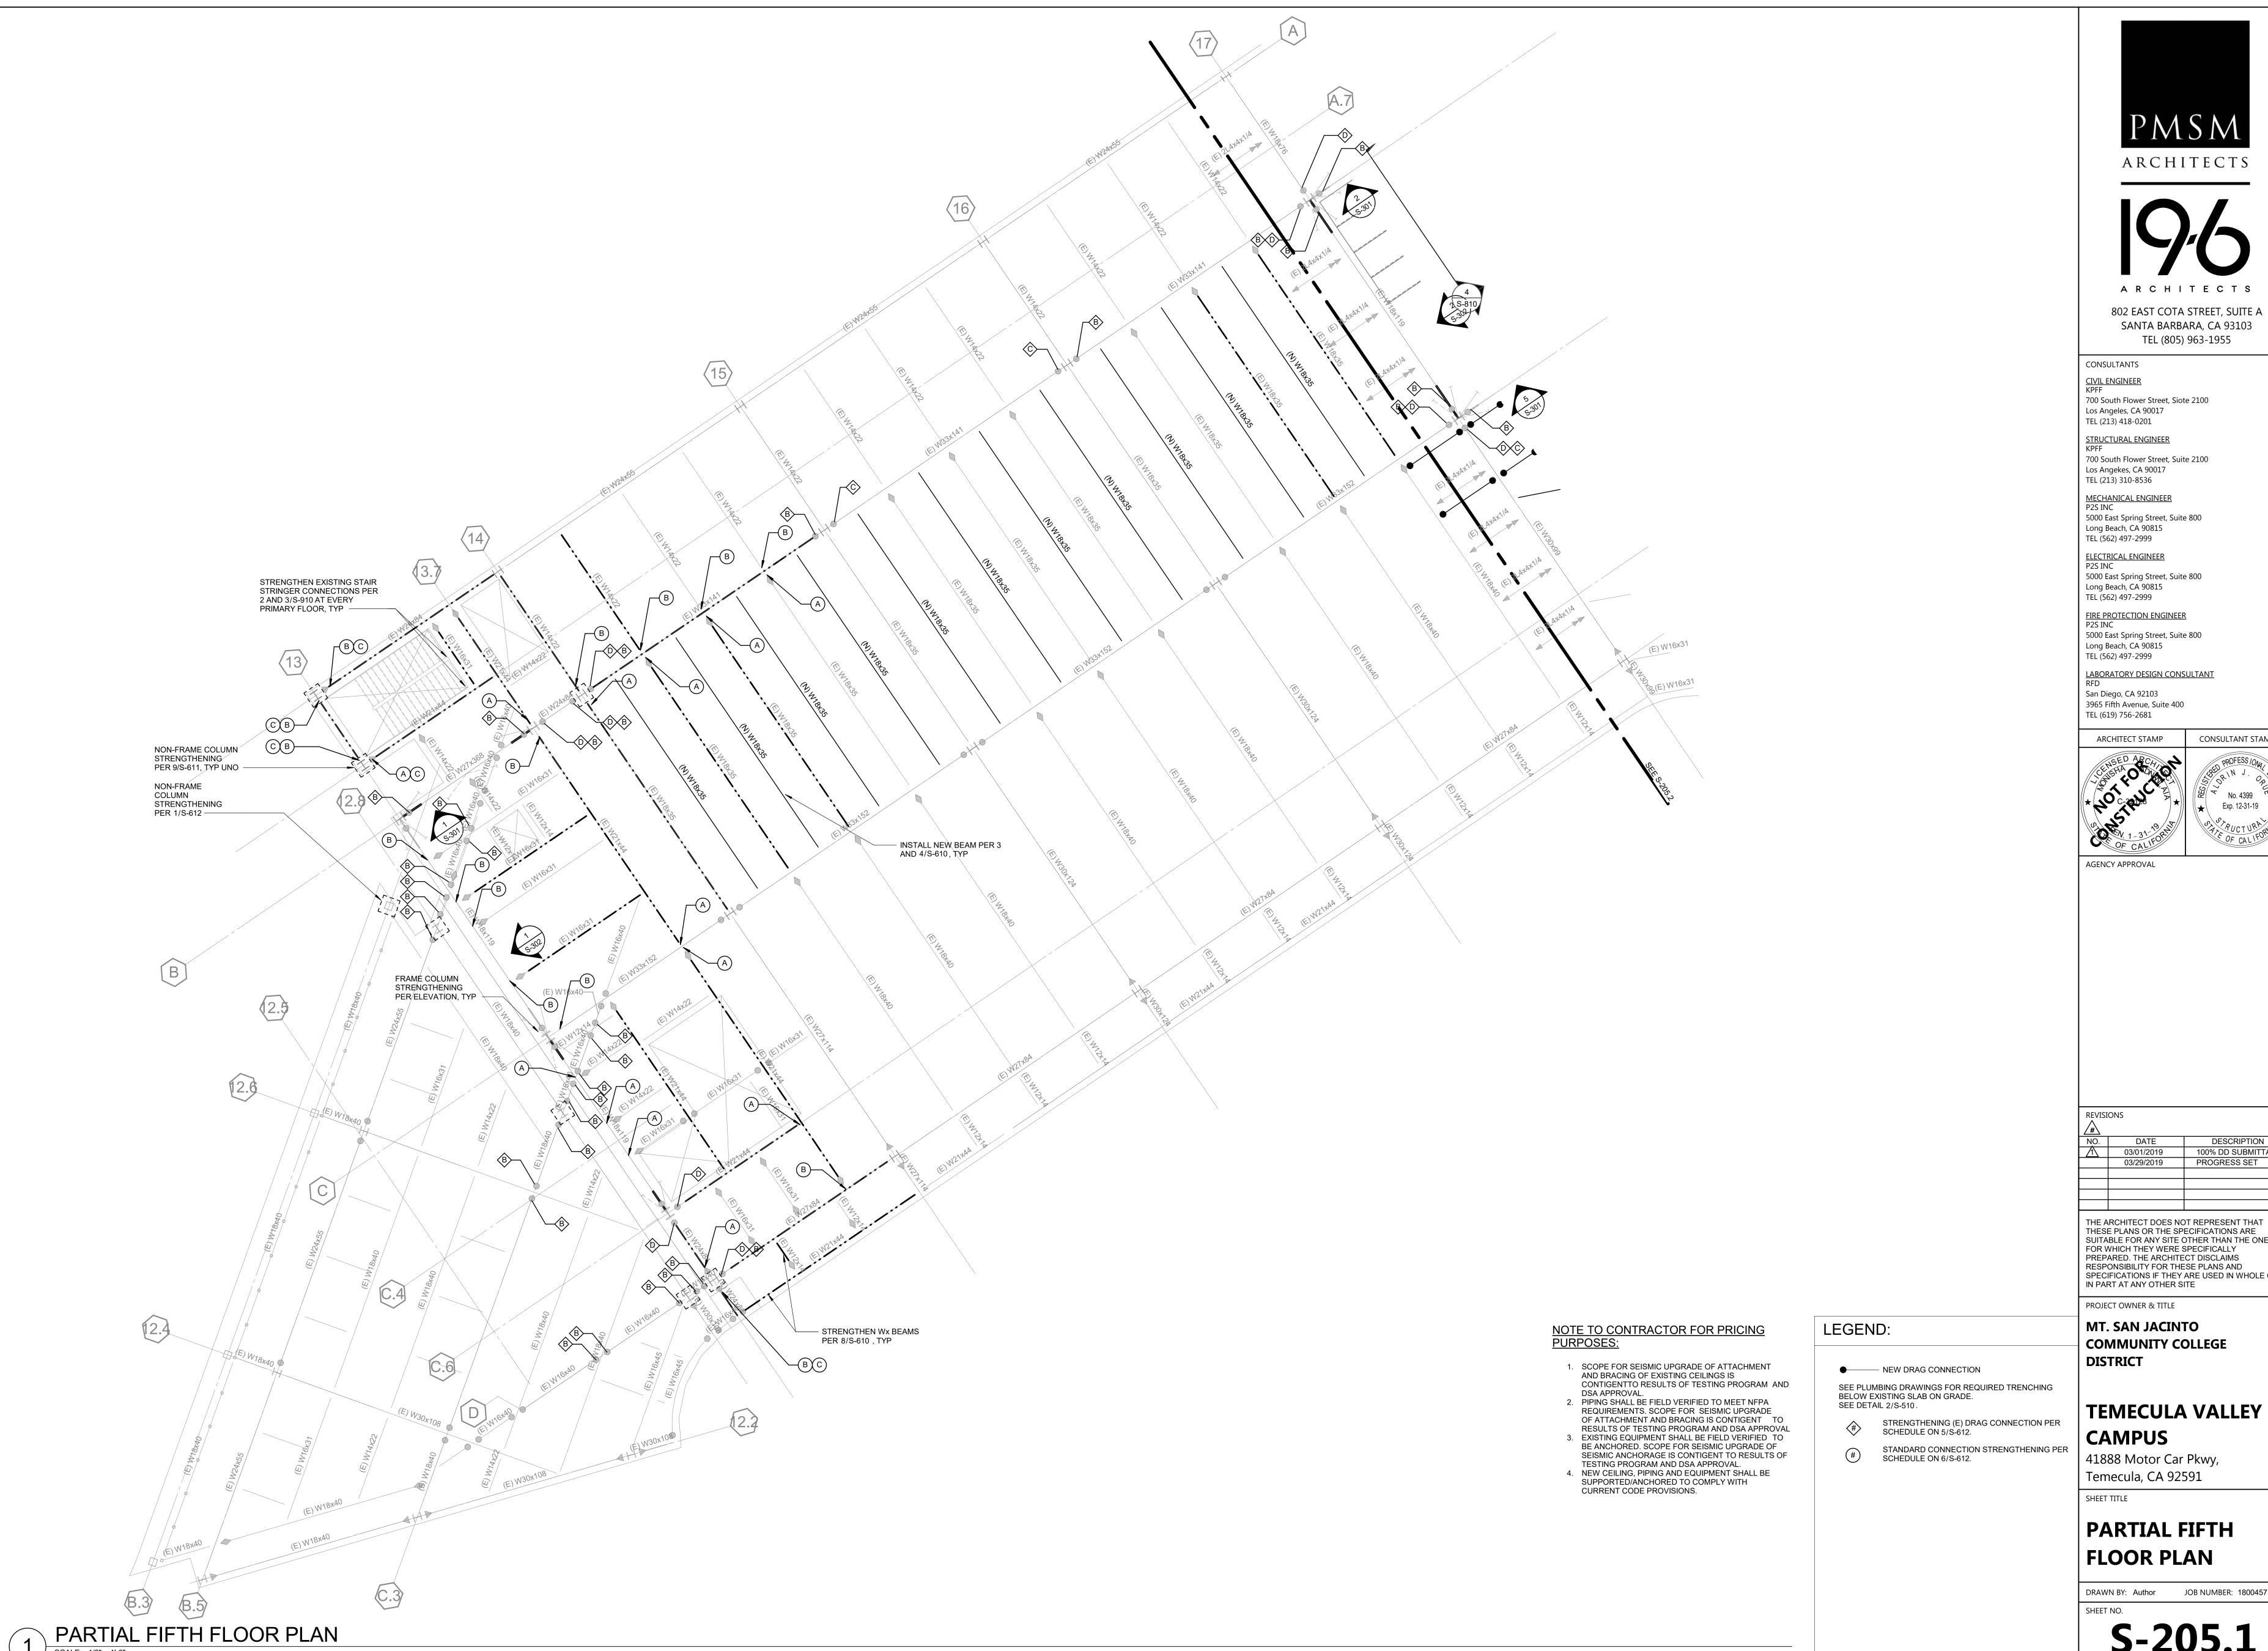
BE ANCHORED. SCOPE FOR SEISMIC UPGRADE OF SEISMIC ANCHORAGE IS CONTIGENT TO RESULTS OF

> PARTIAL FOURTH **FLOOR PLAN**

DRAWN BY: Author JOB NUMBER: 1800457

S-204.2

PARTIAL FOURTH FLOOR PLAN SCALE: 1/8" = 1'-0"



ARCHITECTS

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700 South Flower Street, Siote 2100


5000 East Spring Street, Suite 800

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LABORATORY DESIGN CONSULTANT

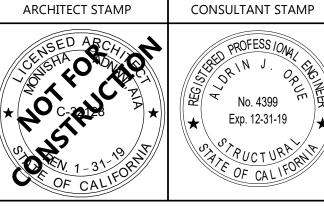3965 Fifth Avenue, Suite 400



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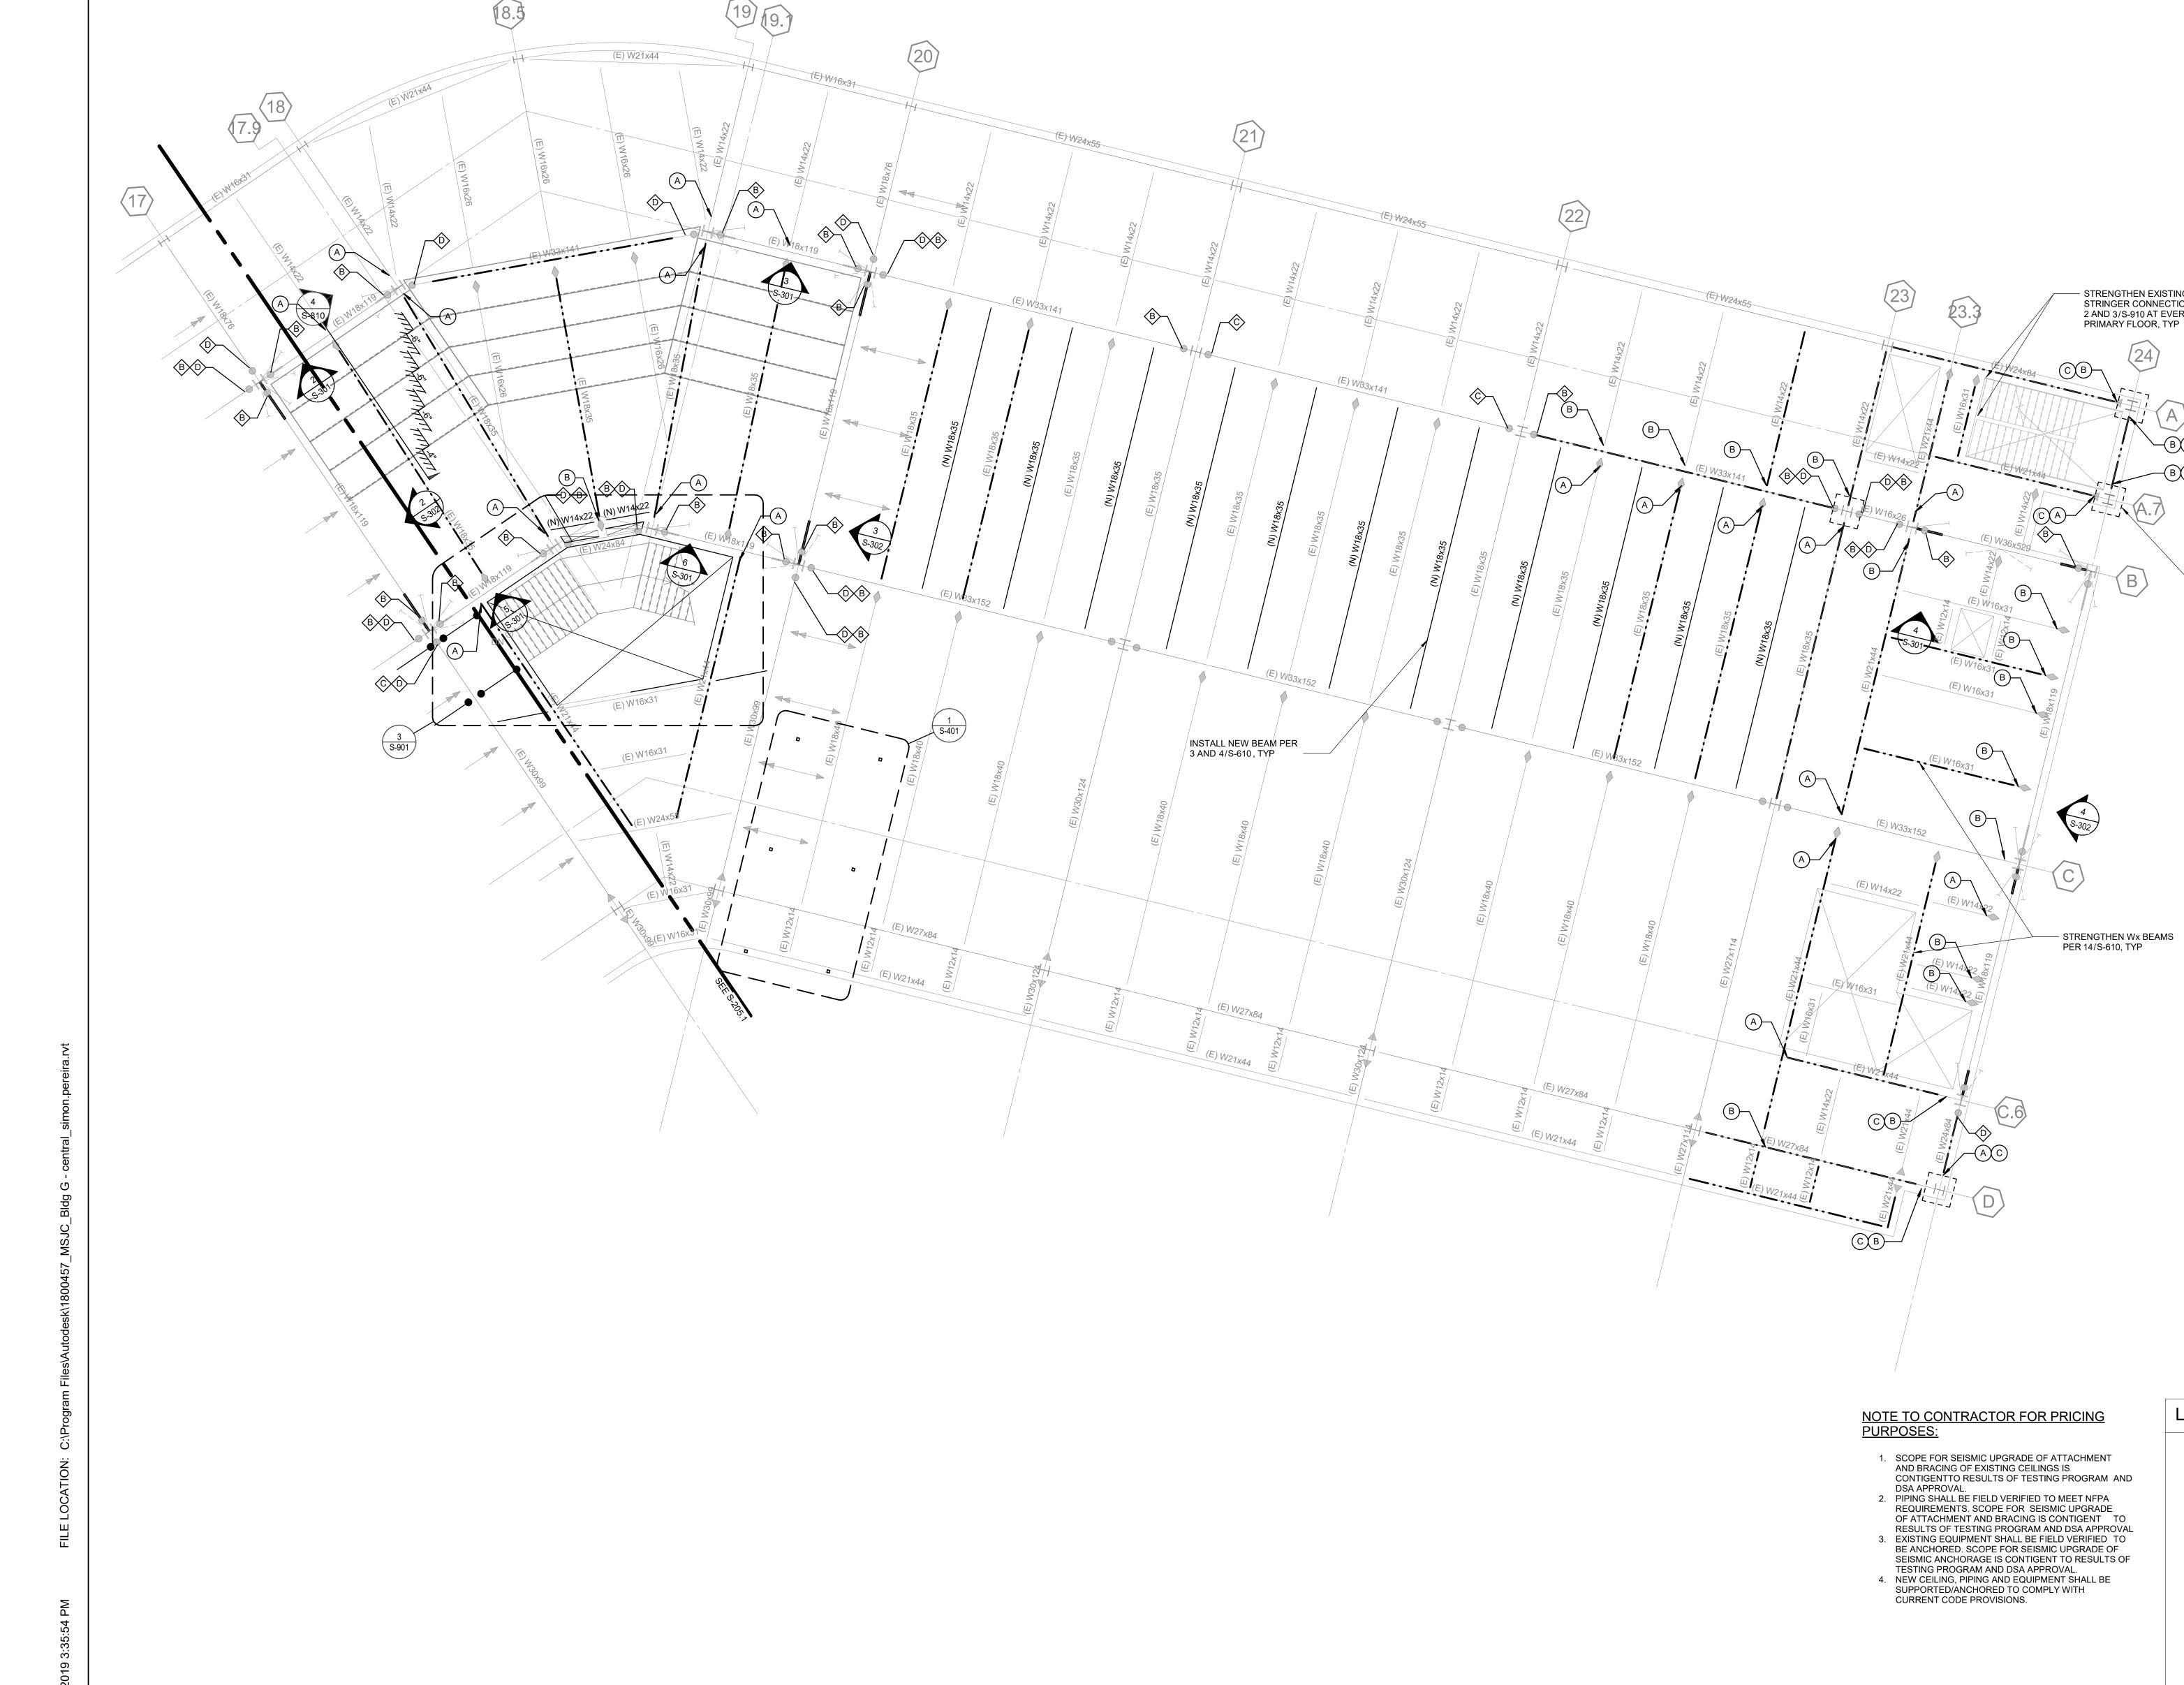
41888 Motor Car Pkwy,

Temecula, CA 92591

PARTIAL FIFTH

DRAWN BY: Author JOB NUMBER: 1800457

S-205.1





802 EAST COTA STREET, SUITE A SANTA BARBARA, CA 93103 TEL (805) 963-1955

CONSULTANTS <u>CIVIL ENGINEER</u> KPFF

STRENGTHEN EXISTING STAIR
 STRINGER CONNECTIONS PER
 2 AND 3/S-910 AT EVERY
 PRIMARY FLOOR, TYP

— NON-FRAME COLUMN STRENGTHENING PER 9/S-611, TYP UNO

LEGEND:

SEE DETAIL 2/S-510.

● NEW DRAG CONNECTION

SEE PLUMBING DRAWINGS FOR REQUIRED TRENCHING BELOW EXISTING SLAB ON GRADE.

STRENGTHENING (E) DRAG CONNECTION PER SCHEDULE ON 5/S-612.

STANDARD CONNECTION STRENGTHENING PER SCHEDULE ON 6/S-612.

700 South Flower Street, Siote 2100 Los Angeles, CA 90017 TEL (213) 418-0201

STRUCTURAL ENGINEER KPFF 700 South Flower Street, Suite 2100

Los Angekes, CA 90017 TEL (213) 310-8536

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ELECTRICAL ENGINEER P2S INC 5000 East Spring Street, Suite 800

Long Beach, CA 90815 TEL (562) 497-2999 FIRE PROTECTION ENGINEER P2S INC

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5000 East Spring Street, Suite 800

San Diego, CA 92103 3965 Fifth Avenue, Suite 400 TEL (619) 756-2681

Long Beach, CA 90815

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AGENCY APPROVAL

03/01/2019 100% DD SUBMITTAL

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03/29/2019 PROGRESS SET

DESCRIPTION

PROJECT OWNER & TITLE

MT. SAN JACINTO **COMMUNITY COLLEGE** DISTRICT

TEMECULA VALLEY CAMPUS

41888 Motor Car Pkwy, Temecula, CA 92591

SHEET TITLE

PARTIAL FIFTH **FLOOR PLAN**

DRAWN BY: Author JOB NUMBER: 1800457

S-205.2 DATE: Issue Date



PMSM ARCHITECTS

ARCHITECTS

802 EAST COTA STREET, SUITE A SANTA BARBARA, CA 93103 TEL (805) 963-1955

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ELECTRICAL ENGINEER P2S INC

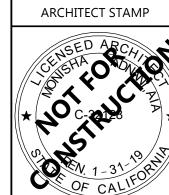
5000 East Spring Street, Suite 800 Long Beach, CA 90815 TEL (562) 497-2999

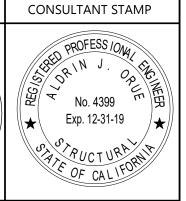
<u>FIRE PROTECTION ENGINEER</u> P2S INC 5000 East Spring Street, Suite 800 Long Beach, CA 90815

LABORATORY DESIGN CONSULTANT

San Diego, CA 92103 3965 Fifth Avenue, Suite 400

TEL (619) 756-2681





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PROJECT OWNER & TITLE

MT. SAN JACINTO **COMMUNITY COLLEGE**

DISTRICT

TEMECULA VALLEY CAMPUS

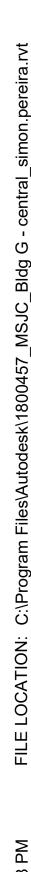
41888 Motor Car Pkwy, Temecula, CA 92591

SHEET TITLE

PARTIAL ROOF PLAN

DRAWN BY: Author JOB NUMBER: 1800457

S-206.1











802 EAST COTA STREET, SUITE A SANTA BARBARA, CA 93103 TEL (805) 963-1955

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TEL (213) 418-0201 STRUCTURAL ENGINEER KPFF

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ELECTRICAL ENGINEER P2S INC 5000 East Spring Street, Suite 800

Long Beach, CA 90815 TEL (562) 497-2999 FIRE PROTECTION ENGINEER P2S INC

5000 East Spring Street, Suite 800 Long Beach, CA 90815 TEL (562) 497-2999

LABORATORY DESIGN CONSULTANT San Diego, CA 92103

3965 Fifth Avenue, Suite 400

TEL (619) 756-2681

ARCHITECT STAMP CONSULTANT STAMP

AGENCY APPROVAL

REVISI	ONS
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<u> </u>	
NO.	DATE
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MT. SAN JACINTO **COMMUNITY COLLEGE** DISTRICT

TEMECULA VALLEY CAMPUS

41888 Motor Car Pkwy, Temecula, CA 92591


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PARTIAL ROOF PLAN

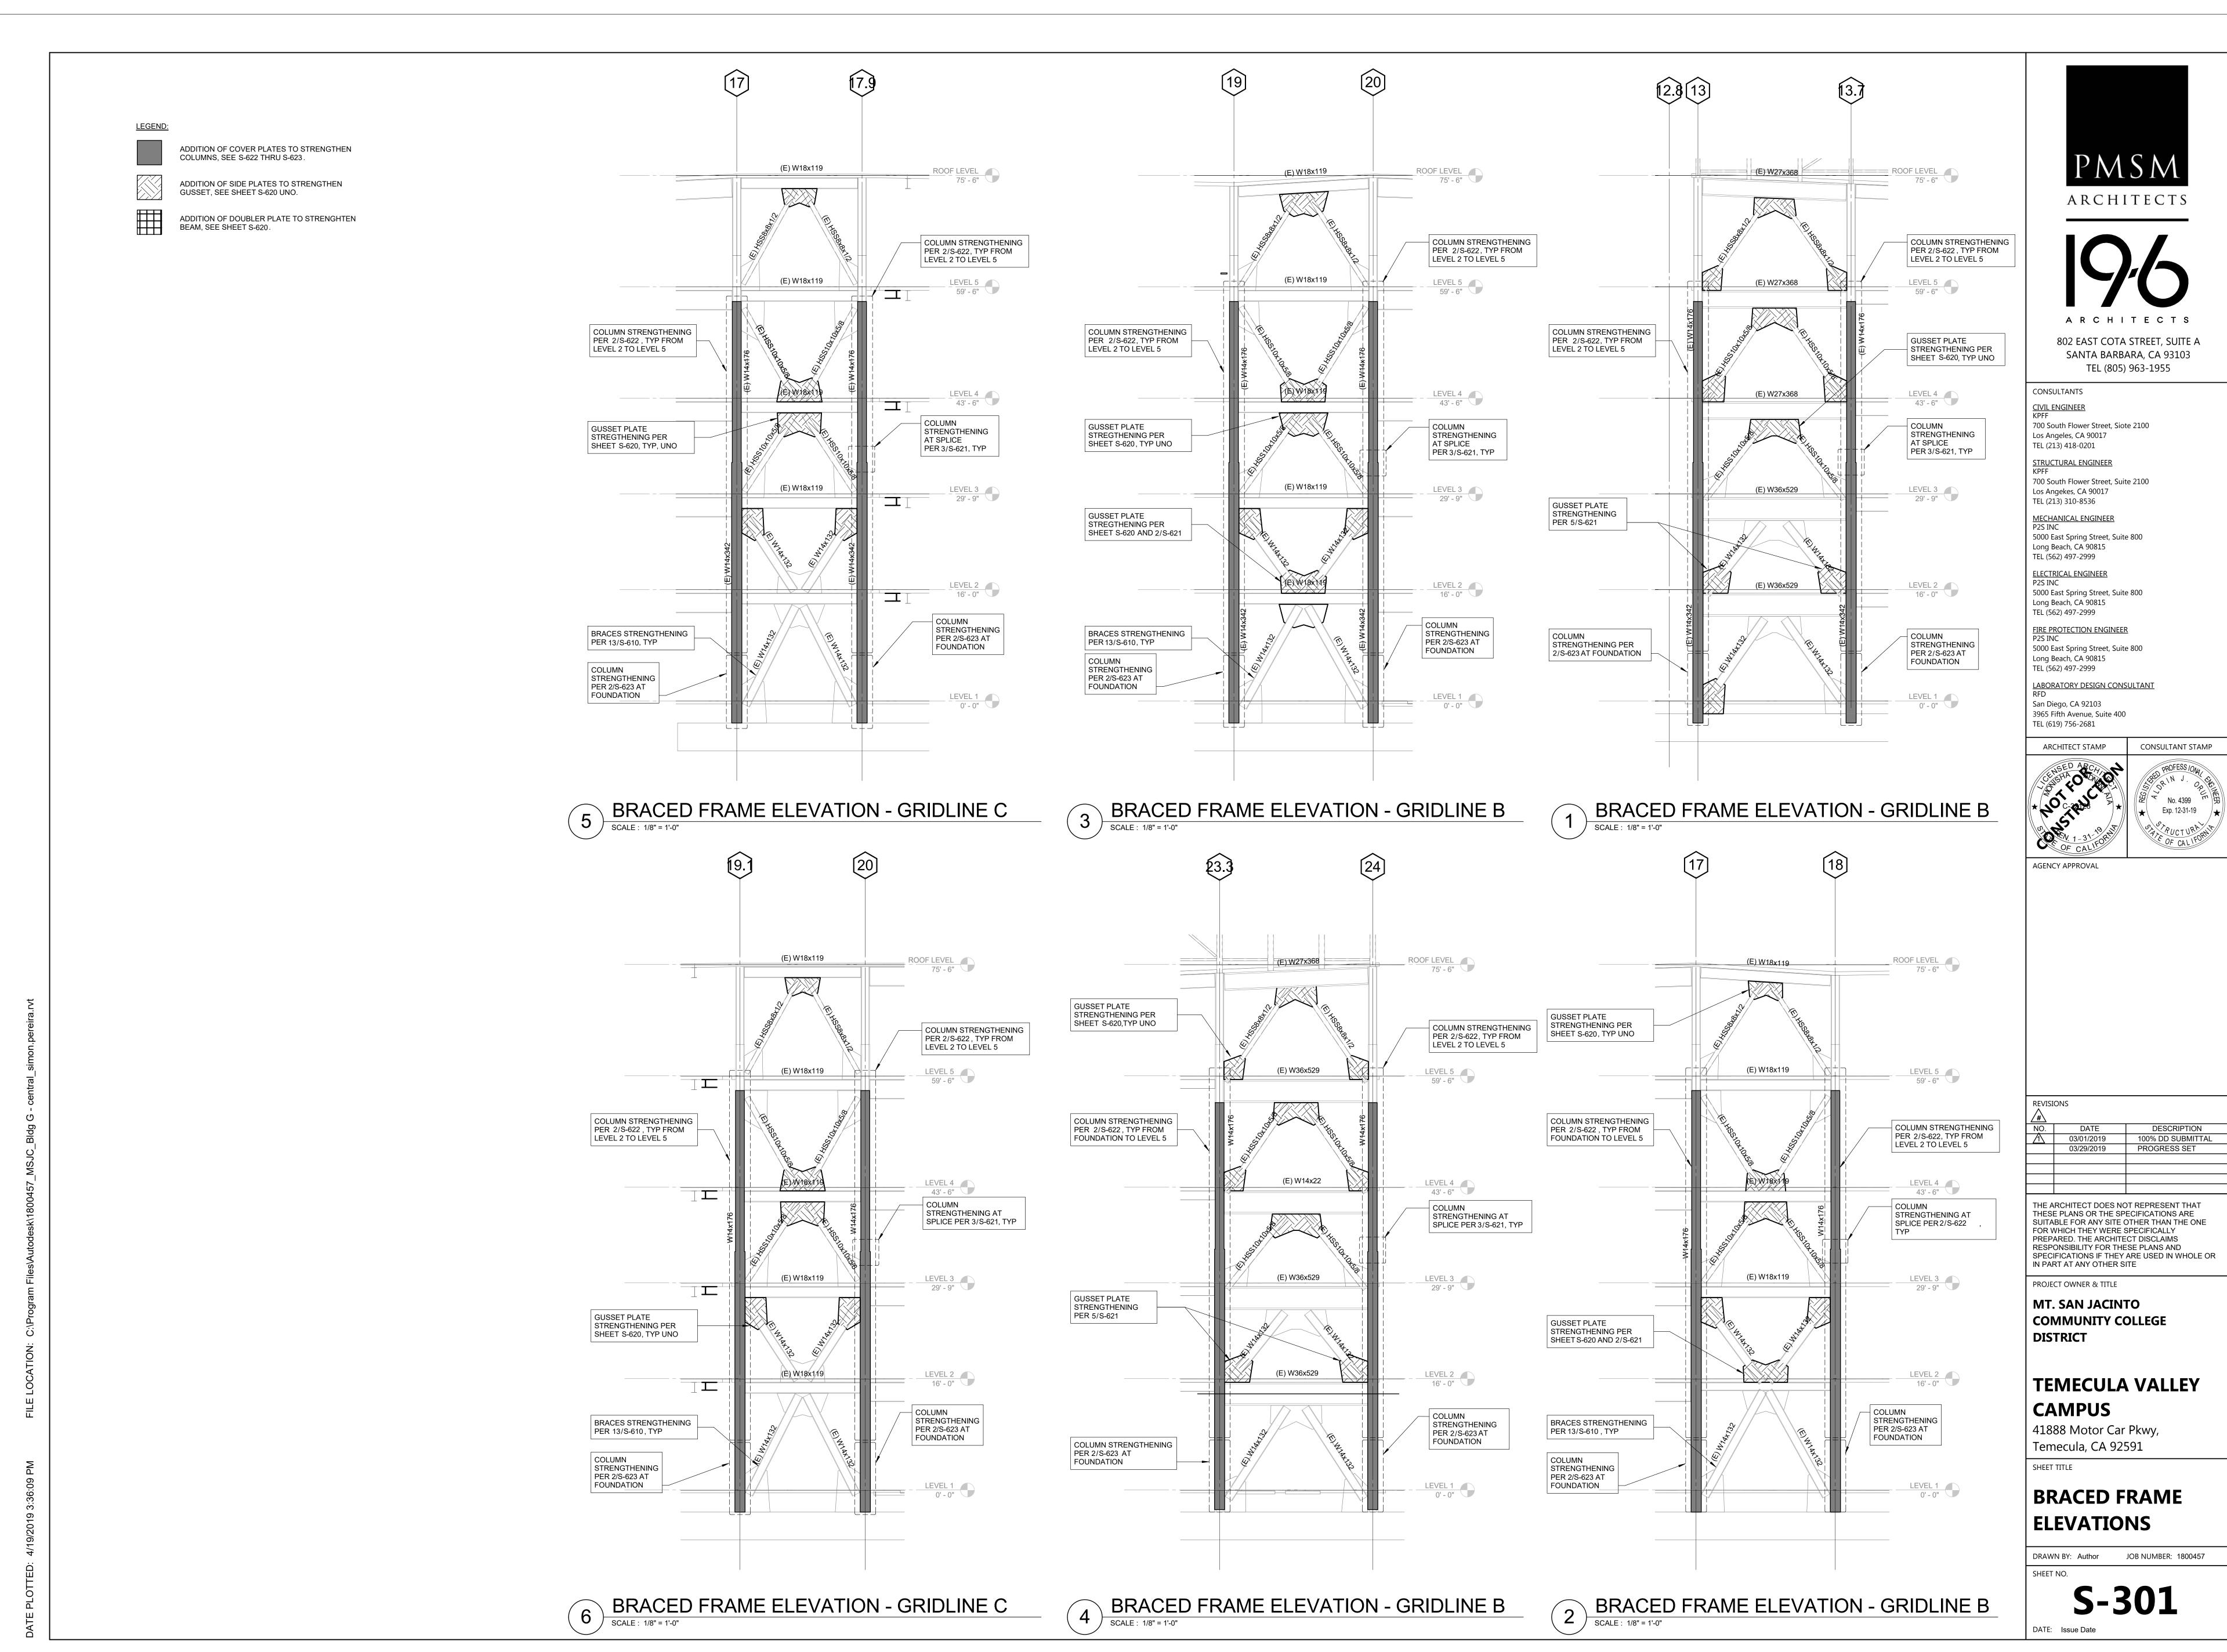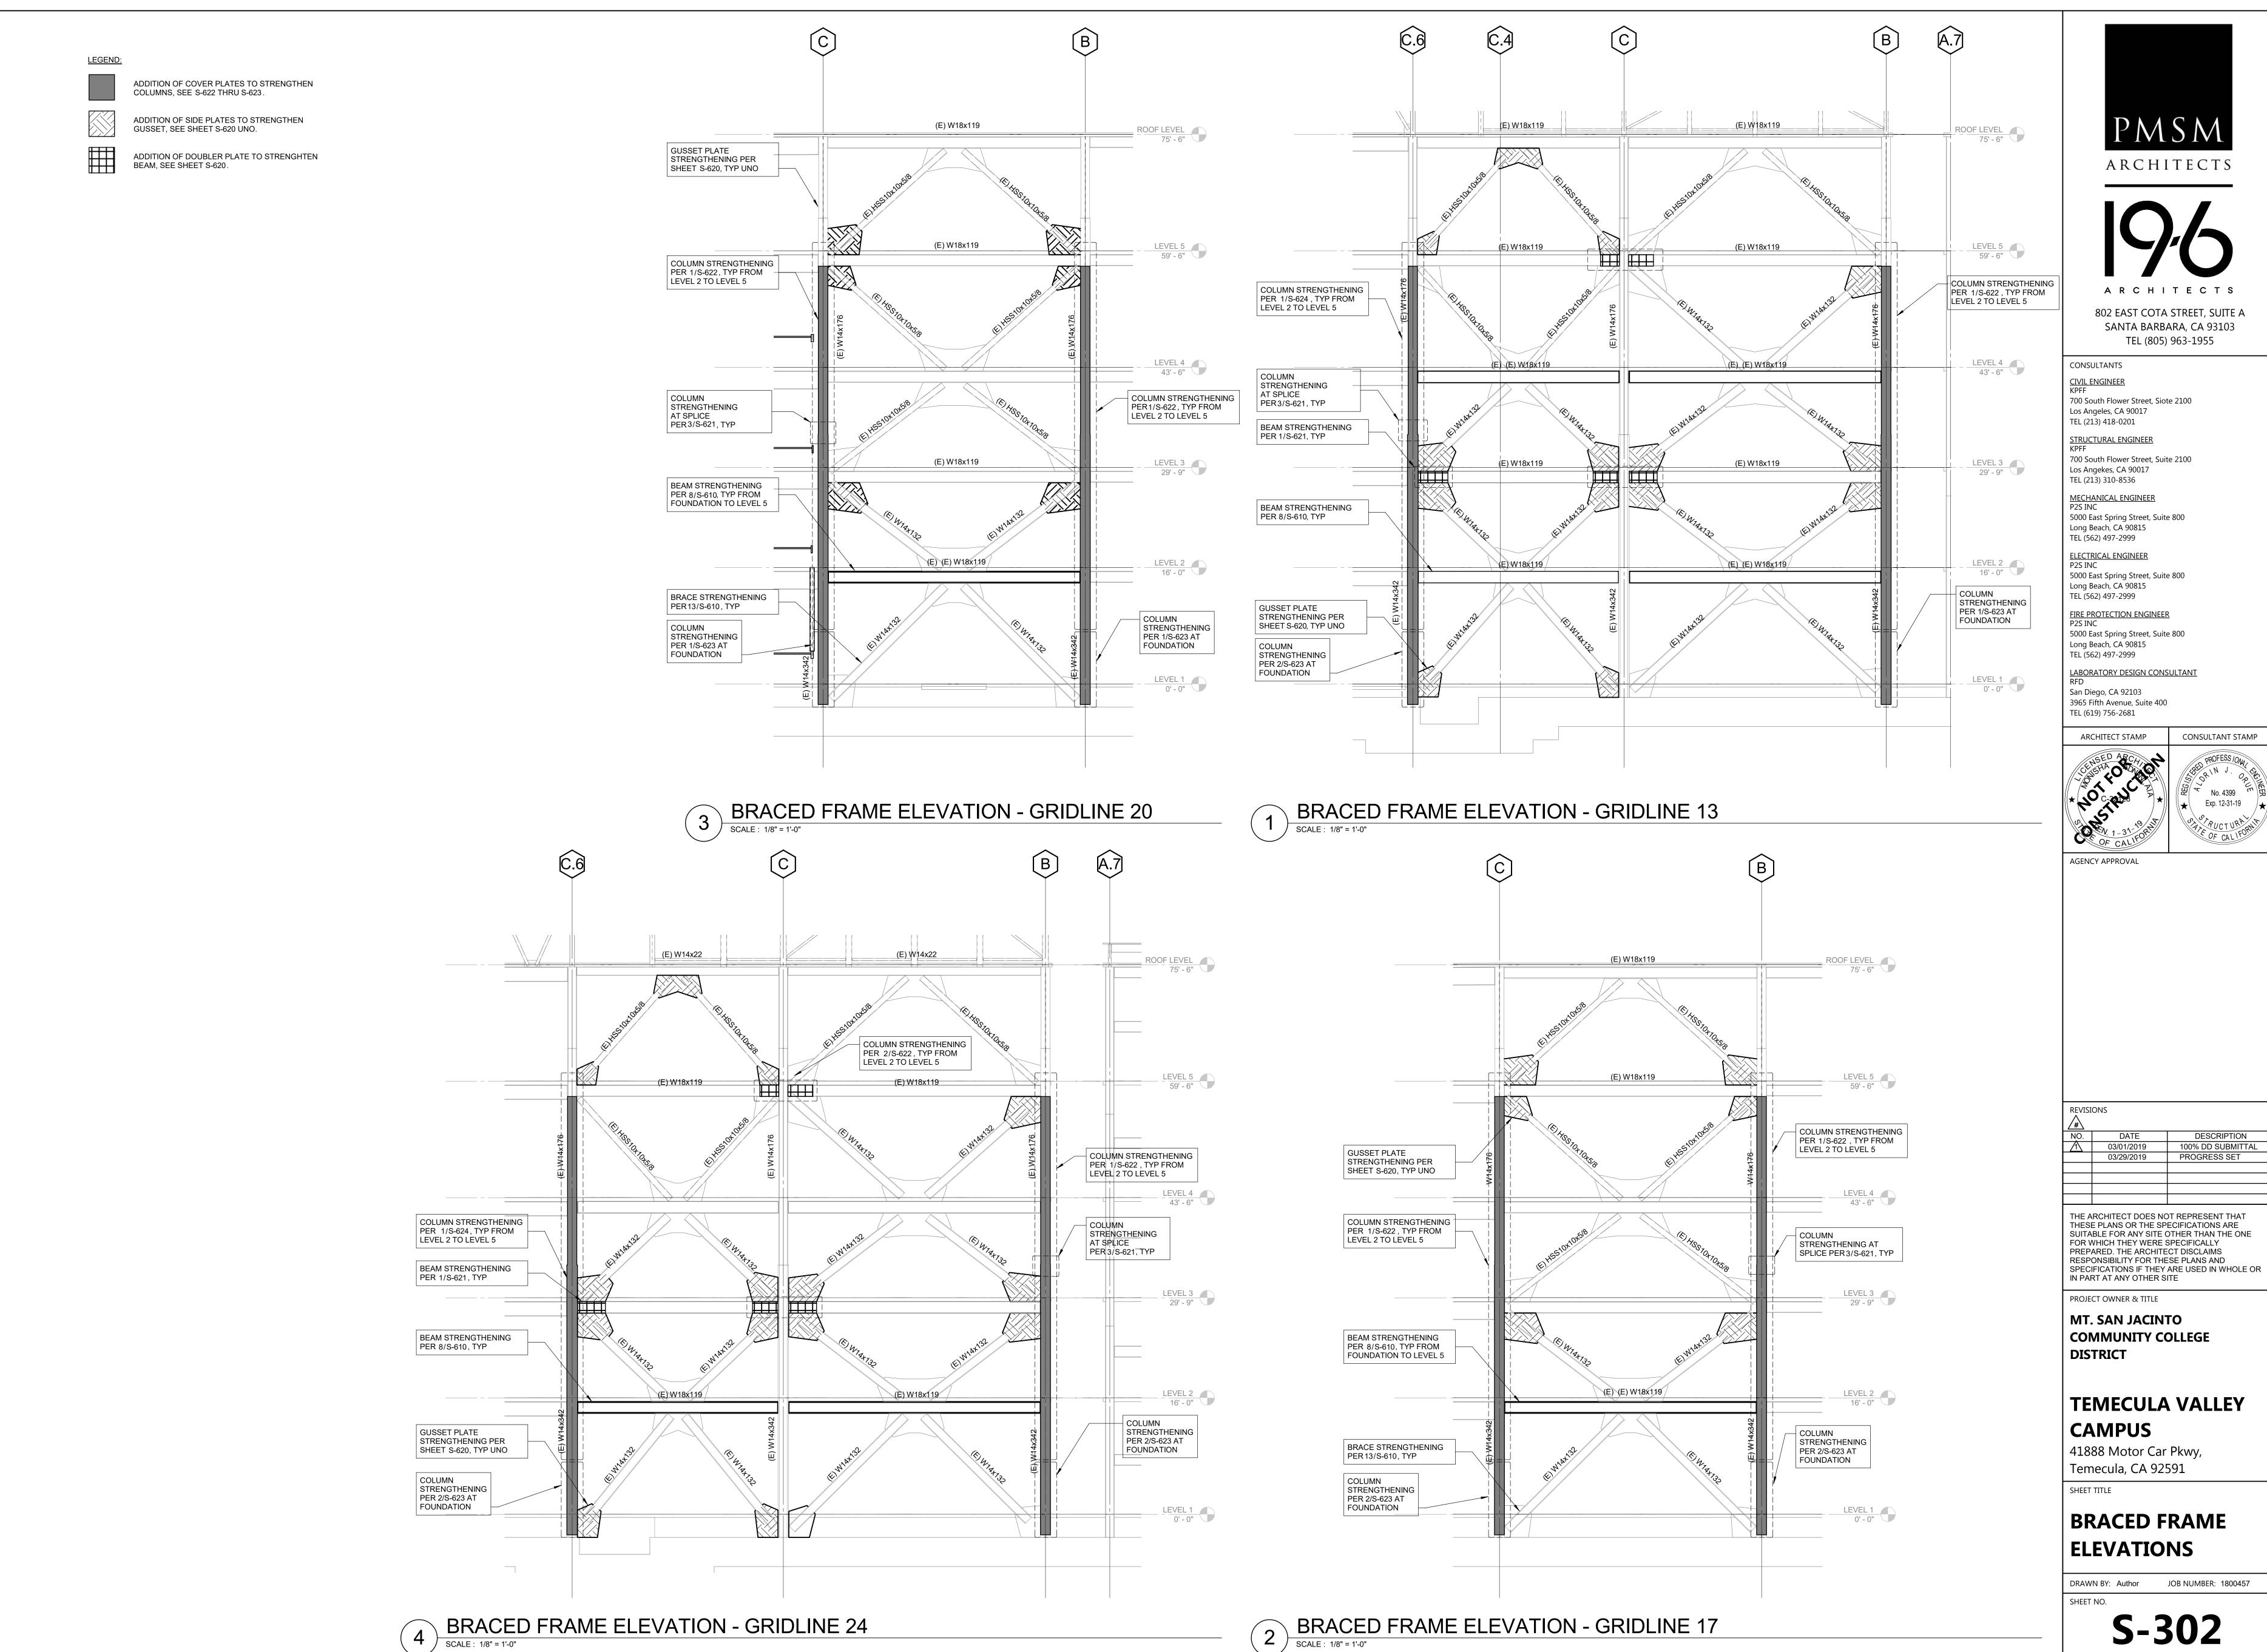
DRAWN BY: Author JOB NUMBER: 1800457

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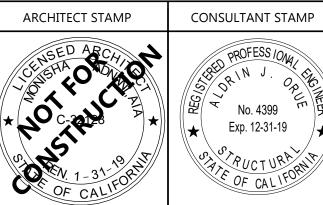
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Project Status




802 EAST COTA STREET, SUITE A SANTA BARBARA, CA 93103




DESCRIPTION 100% DD SUBMITTAL PROGRESS SET


SUITABLE FOR ANY SITE OTHER THAN THE ONE

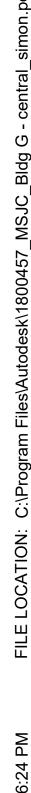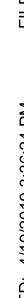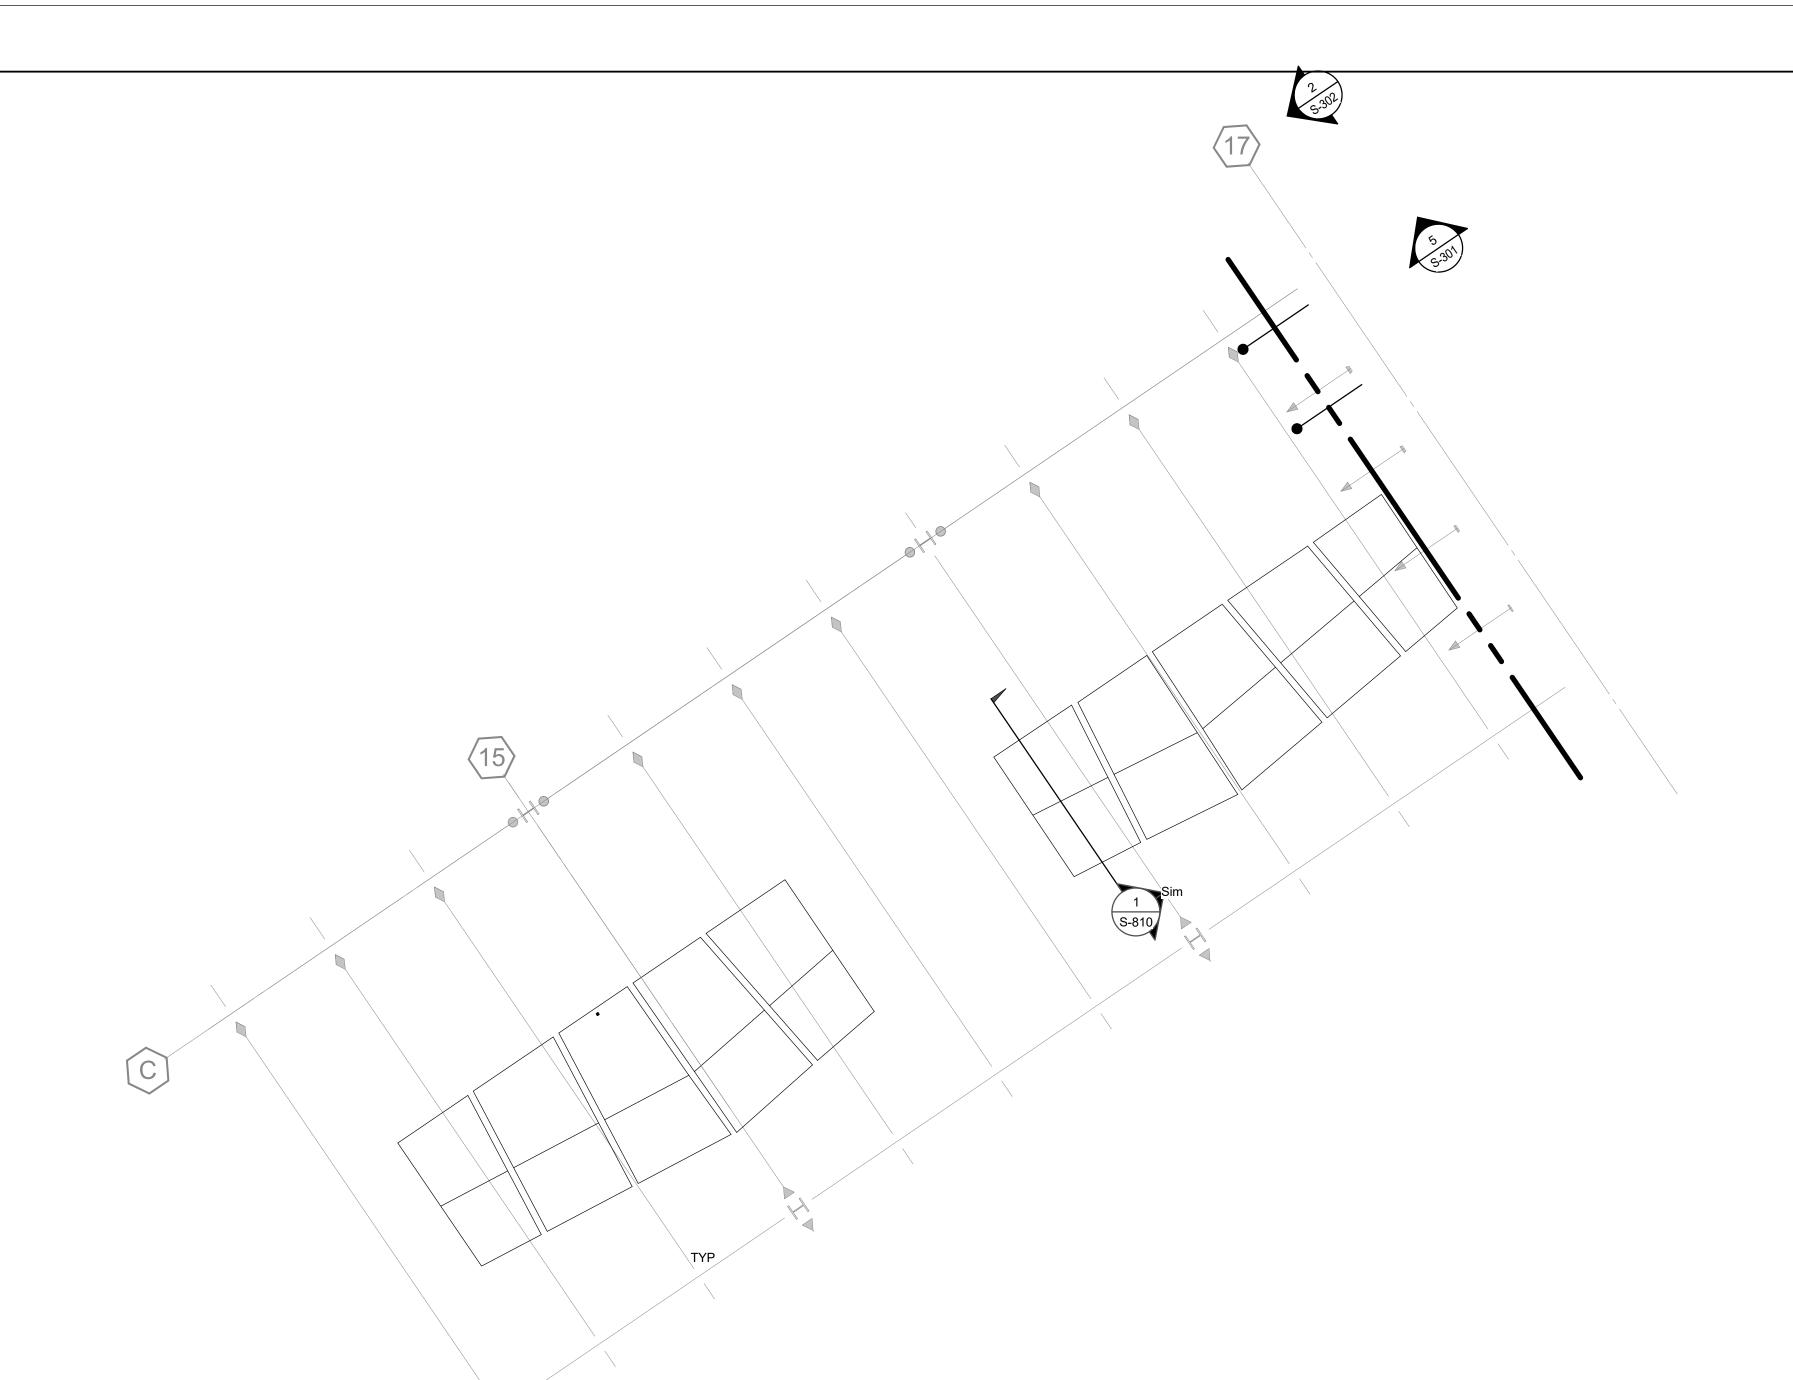JOB NUMBER: 1800457











PARTIAL PLAN - WOOD ACOUSTICAL CEILING

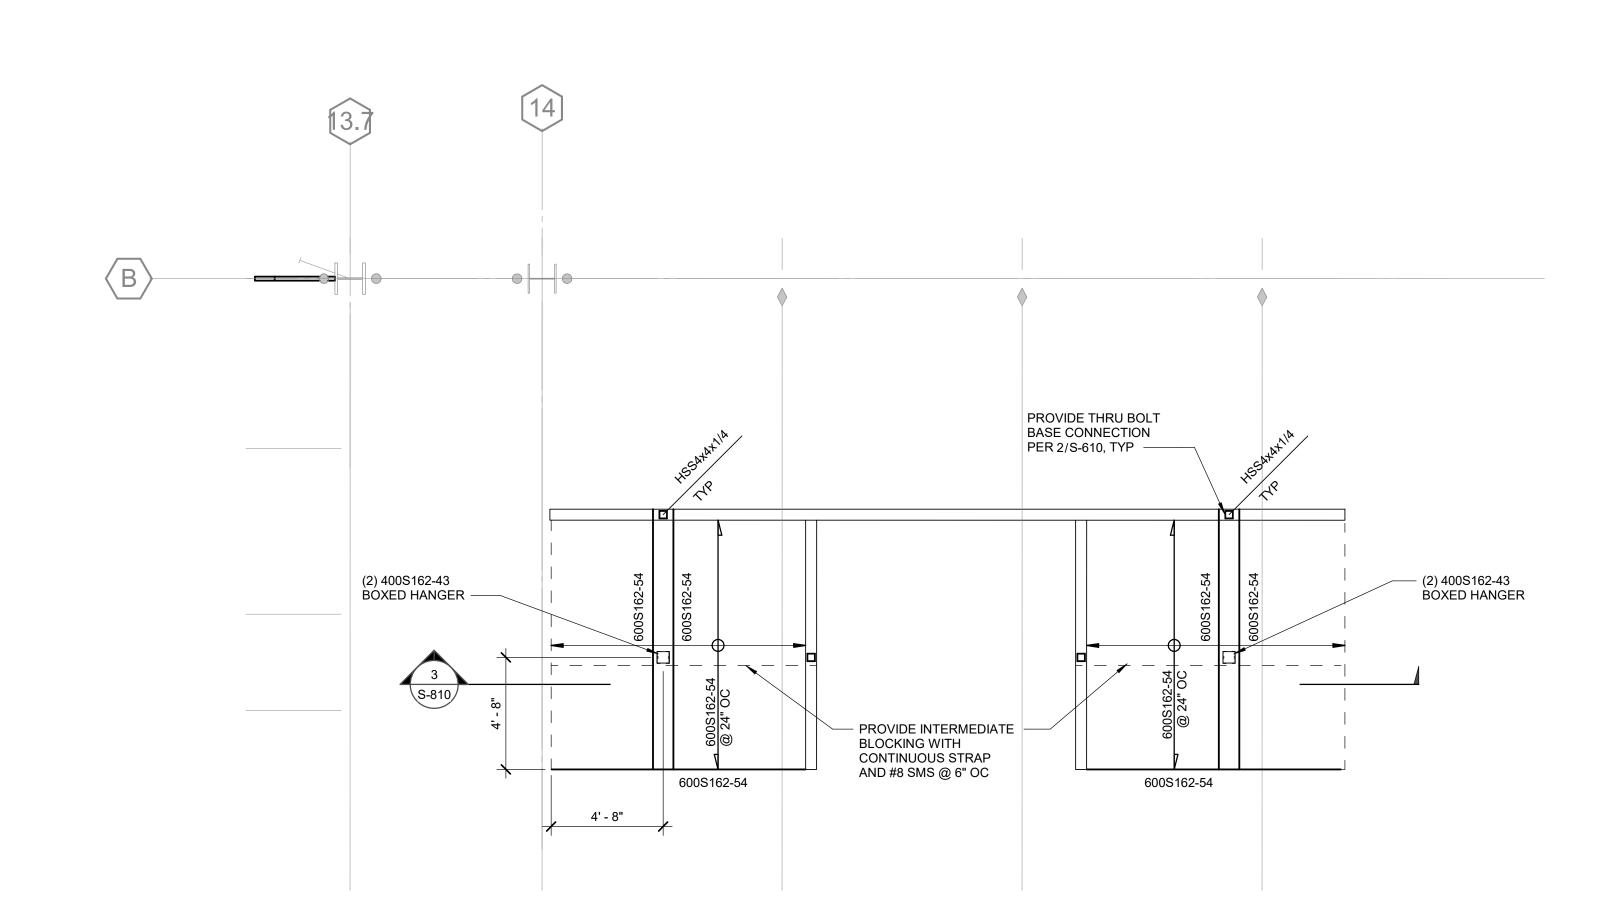SCALE: 1/8" = 1'-0"



PROVIDE THRU BOLT
BASE CONNECTION
PER 2/S-610, TYP

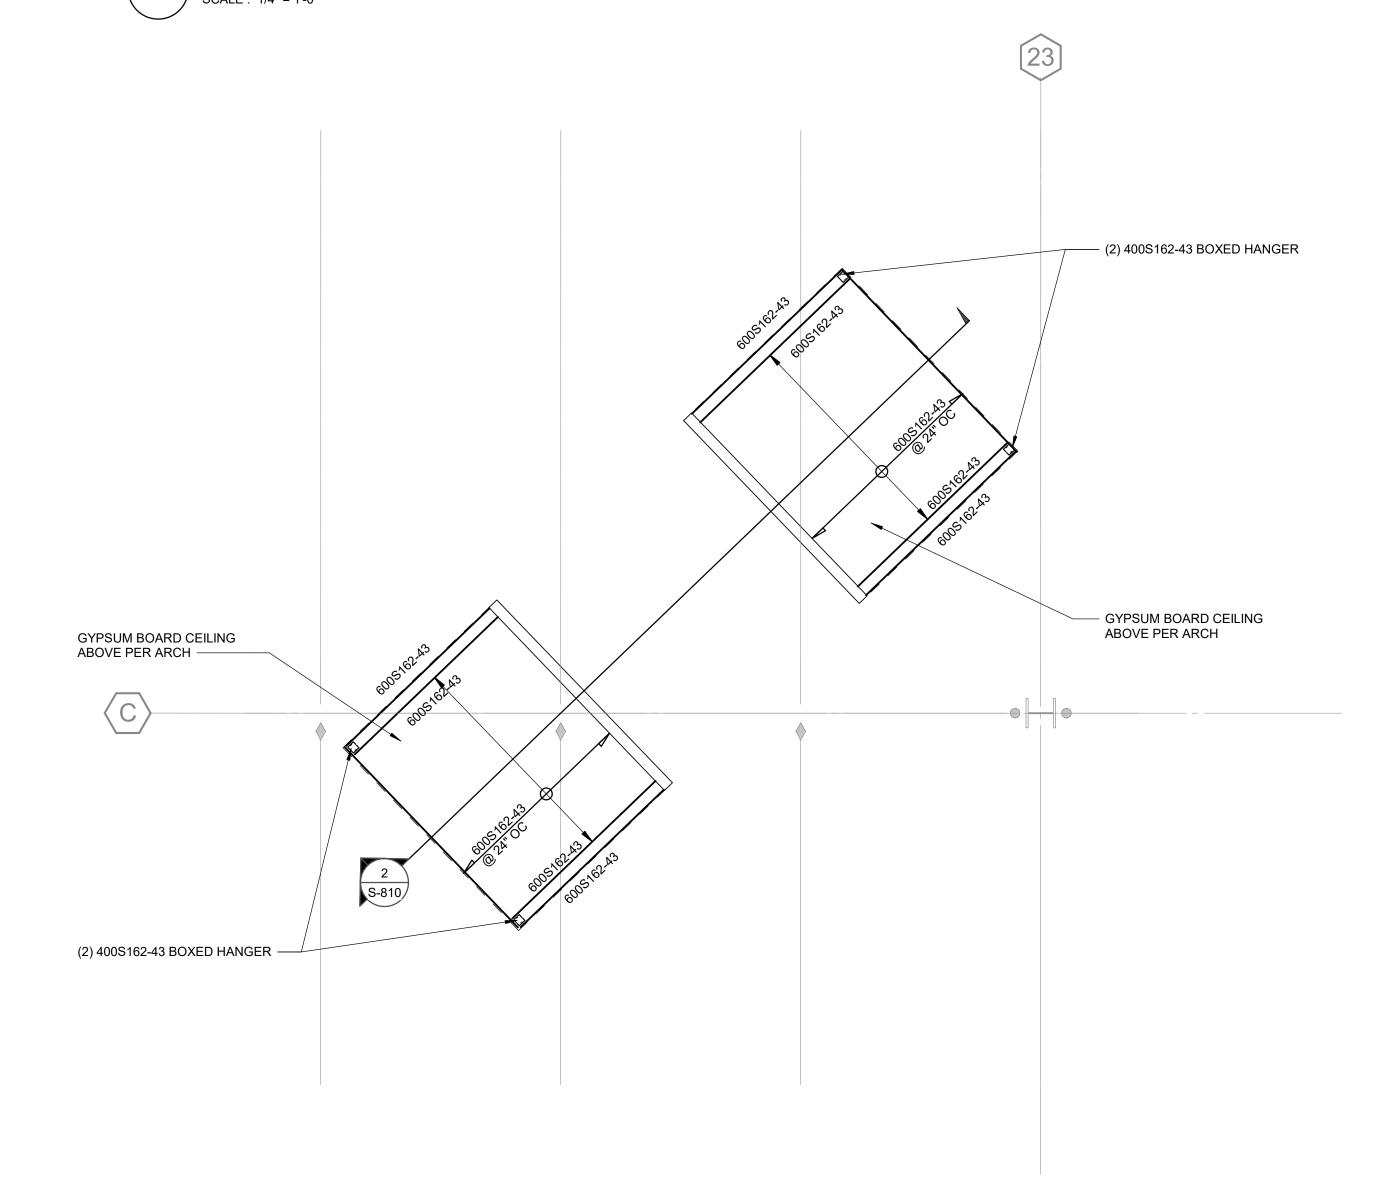1 PARTIAL LEVEL 2 - GLASS WALL
SCALE: 1/4" = 1'-0"



PARTIAL FOURTH FLOOR PLAN AT STUDENT COLLABORATION SPACE

SCALE: 1/4" = 1'-0"





ARCHITECT STAMP	CONSULTANT STAMP
CENSED ARCHIO	PROFESS IONAL CERTIFORM TO PROFESS IONAL CERTIFICATIONAL CERTIFICATION TO PROFESS IONAL CERTIFICATION TO PROFE
AGENCY APPROVAL	

REVISI	ONS	
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NO.	DATE	DESCRIPTION
Λ	03/01/2019	100% DD SUBMITTAL
	03/29/2019	PROGRESS SET

SUITABLE FOR ANY SITE OTHER THAN THE ONE FOR WHICH THEY WERE SPECIFICALLY PREPARED. THE ARCHITECT DISCLAIMS RESPONSIBILITY FOR THESE PLANS AND SPECIFICATIONS IF THEY ARE USED IN WHOLE OR IN PART AT ANY OTHER SITE PROJECT OWNER & TITLE

MT. SAN JACINTO COMMUNITY COLLEGE DISTRICT

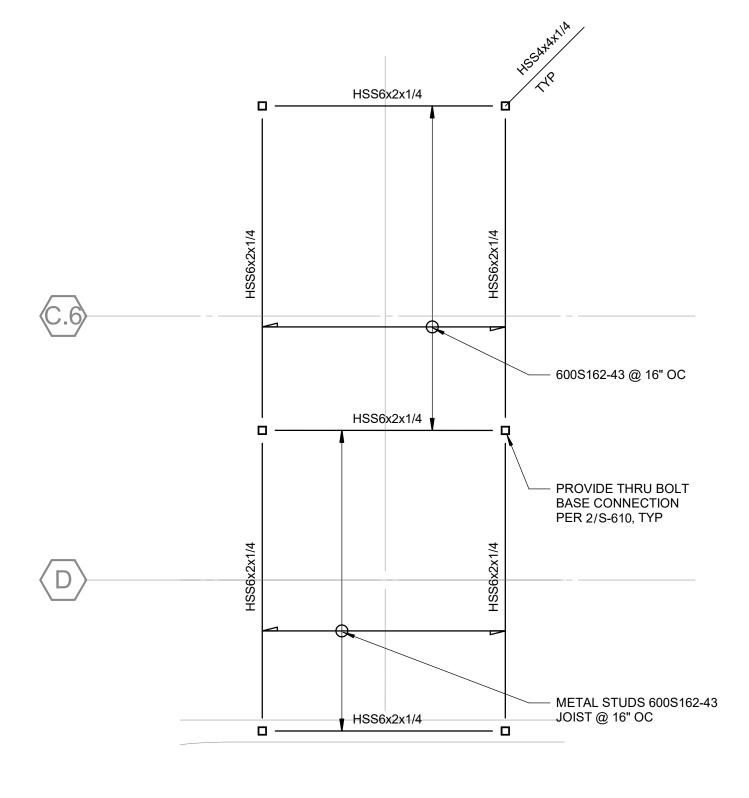
TEMECULA VALLEY CAMPUS

41888 Motor Car Pkwy, Temecula, CA 92591

SHEET TITLE

PARTIAL PLANS

DRAWN BY: Author JOB NUMBER: 1800457 **S-400**







ARCHITECT STAMP	CONSULTANT STAMP
CENSED ARCHICAL COLOR PARCHICAL COLOR	PROFESS IONAL PR
AGENCY APPROVAL	

REVISI	ONS	
NO.	DATE	DESCRIPTION
	03/01/2019	100% DD SUBMITTAL
	03/29/2019	PROGRESS SET

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PROJECT OWNER & TITLE

MT. SAN JACINTO COMMUNITY COLLEGE DISTRICT

TEMECULA VALLEY CAMPUS

41888 Motor Car Pkwy, Temecula, CA 92591

SHEET TITLE

PARTIAL PLANS

DRAWN BY: Author JOB NUMBER: 1800457

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			NORMAL WEIGHT CONCRETE																						
BAR	LAP	f'c = 3000 psi			fc = 4000 psi			f'c = 5000 psi			f'c = 6000 psi			f'c = 7000 psi			fc = 8000 psi								
	CLASS	LASS Top Bars		Bars Other Bars		Top Bars		Other Bars		Top Bars	Bars	Other Bars		Top Bars	Other Bars	Top Bars		Other Bars		Top Bars		Other Bars			
		Case 1	Case 2	Case 1	Case 2	Case 1	Case 2	Case 1	Case 2	Case 1	Case 2	Case 1	Case 2	Case 1	Case 2	Case 1	Case 2	Case 1	Case 2	Case 1	Case 2	Case 1	Case 2	Case 1	Case 2
3	Α	1'-10"	2'-9"	1'-5"	2'-1"	1'-7"	2'-4"	1'-3"	1'-10"	1'-5"	2'-1"	1'-1"	1'-8"	1'-4"	1'-11"	1'-0"	1'-6"	1'-2"	1'-9"	1'-0"	1'-5"	1'-2"	1'-8"	1'-0"	1'-4"
	В	2'-4"	3'-6"	1'-10"	2'-9"	2'-1"	3'-1"	1'-7"	2'-4"	1'-10"	2'-9"	1'-5"	2'-1"	1'-8"	2'-6"	1'-4"	1'-11"	1'-7"	2'-4"	1'-2"	1'-9"	1'-6"	2'-2"	1'-2"	1'-8"
4	Α	2'-5"	3'-7"	1'-10"	2'-9"	2'-1"	3'-1"	1'-7"	2'-5"	1'-11"	2'-10"	1'-5"	2'-2"	1'-9"	2'-7"	1'-4"	2'-0"	1'-7"	2'-4"	1'-3"	1'-10"	1'-6"	2'-3"	1'-2"	1'-9"
" [В	3'-2"	4'-8"	2'-5"	3'-7"	2'-9"	4'-1"	2'-1"	3'-1"	2'-5"	3'-8"	1'-11"	2'-10"	2'-3"	3'-4"	1'-9"	2'-7"	2'-1"	3'-1"	1'-7"	2'-4"	1'-11"	2'-11"	1'-6"	2'-3"
5 -	Α	3'-0"	4'-6"	2'-4"	3'-6"	2'-7"	3'-11"	2'-0"	3'-0"	2'-4"	3'-6"	1'-10"	2'-8"	2'-2"	3'-2"	1'-8"	2'-6"	2'-0"	2'-11"	1'-6"	2'-3"	1'-10"	2'-9"	1'-5"	2'-2"
	В	3'-11"	5'-10"	3'-0"	4'-6"	3'-5"	5'-1"	2'-7"	3'-11"	3'-0"	4'-6"	2'-4"	3'-6"	2'-9"	4'-2"	2'-2"	3'-2"	2'-7"	3'-10"	2'-0"	2'-11"	2'-5"	3'-7"	1'-10"	2'-9"
6 –	Α	3'-7"	5'-5"	2'-9"	4'-2"	3'-1"	4'-8"	2'-5"	3'-7"	2'-10"	4'-2"	2'-2"	3'-3"	2'-7"	3'-10"	2'-0"	2'-11"	2'-4"	3'-6"	1'-10"	2'-9"	2'-3"	3'-4"	1'-9"	2'-7"
	В	4'-8"	7'-0"	3'-7"	5'-5"	4'-1"	6'-1"	3'-1"	4'-8"	3'-8"	5'-5"	2'-10"	4'-2"	3'-4"	4'-11"	2'-7"	3'-10"	3'-1"	4'-7"	2'-4"	3'-6"	2'-11"	4'-4"	2'-3"	3'-4"
7	Α	5'-3"	7'-10"	4'-0"	6'-0"	4'-6"	6'-9"	3'-6"	5'-3"	4'-1"	6'-1"	3'-2"	4'-8"	3'-9"	5'-7"	2'-10"	4'-3"	3'-5"	5'-2"	2'-8"	4'-0"	3'-3"	4'-10"	2'-6"	3'-9"
, L	В	6'-9"	10'-2"	5'-3"	7'-10"	5'-11"	8'-10"	4'-6"	6'-9"	5'-3"	7'-11"	4'-1"	6'-1"	4'-10"	7'-2"	3'-9"	5'-7"	4'-6"	6'-8"	3'-5"	5'-2"	4'-2"	6'-3"	3'-3"	4'-10"
8 –	Α	6'-0"	8'-11"	4'-7"	6'-11"	5'-2"	7'-9"	4'-0"	6'-0"	4'-8"	6'-11"	3'-7"	5'-4"	4'-3"	6'-4"	3'-3"	4'-11"	3'-11"	5'-10"	3'-0"	4'-6"	3'-8"	5'-6"	2'-10"	4'-3"
° [В	7'-9"	11'-7"	6'-0"	8'-11"	6'-9"	10'-1"	5'-2"	7'-9"	6'-0"	9'-0"	4'-8"	6'-11"	5'-6"	8'-3"	4'-3"	6'-4"	5'-1"	7'-7"	3'-11"	5'-10"	4'-9"	7'-2"	3'-8"	5'-6"
9	Α	6'-9"	10'-1"	5'-2"	7'-9"	5'-10"	8'-9"	4'-6"	6'-9"	5'-3"	7'-10"	4'-0"	6'-0"	4'-9"	7'-2"	3'-8"	5'-6"	4'-5"	6'-7"	3'-5"	5'-1"	4'-2"	6'-2"	3'-2"	4'-9"
9	В	8'-9"	13'-1"	6'-9"	10'-1"	7'-7"	11'-4"	5'-10"	8'-9"	6'-9"	10'-2"	5'-3"	7'-10"	6'-2"	9'-3"	4'-9"	7'-2"	5'-9"	8'-7"	4'-5"	6'-7"	5'-4"	8'-0"	4'-2"	6'-2"
10	Α	7'-7"	11'-4"	5'-10"	8'-9"	6'-7"	9'-10"	5'-1"	7'-7"	5'-11"	8'-10"	4'-6"	6'-9"	5'-4"	8'-0"	4'-2"	6'-2"	5'-0"	7'-5"	3'-10"	5'-9"	4'-8"	7'-0"	3'-7"	5'-4"
10	В	9'-10"	14'-9"	7'-7"	11'-4"	8'-6"	12'-9"	6'-7"	9'-10"	7'-8"	11'-5"	5'-11"	8'-10"	7'-0"	10'-5"	5'-4"	8'-0"	6'-5"	9'-8"	5'-0"	7'-5"	6'-0"	9'-0"	4'-8"	7'-0"
11	Α	8'-5"	12'-7"	6'-6"	9'-8"	7'-3"	10'-11"	5'-7"	8'-5"	6'-6"	9'-9"	5'-0"	7'-6"	5'-11"	8'-11"	4'-7"	6'-10"	5'-6"	8'-3"	4'-3"	6'-4"	5'-2"	7'-9"	4'-0"	5'-11

B | 10'-11" | 16'-4" | 8'-5" | 12'-7" | 9'-6" | 14'-2" | 7'-3" | 10'-11" | 8'-6" | 12'-8" | 6'-6" | 9'-9" | 7'-9" | 11'-7" | 5'-11" | 8'-11" | 7'-2" | 10'-9" | 5'-6" | 8'-3" | 6'-8" | 10'-0" | 5'-2" | 7'-9"

1. CASES 1 AND 2 WHICH DEPEND ON CLEAR CONCRETE COVER AND THE CENTER-TO-CENTER SPACING OF THE BARS ARE DEFINED AS:

CASE 1: COVER AT LEAST 1db AND CLEAR SPACING AT LEAST 2db. CASE 2: COVER LESS THAN 1db OR CLEAR SPACING LESS THAN 2db.

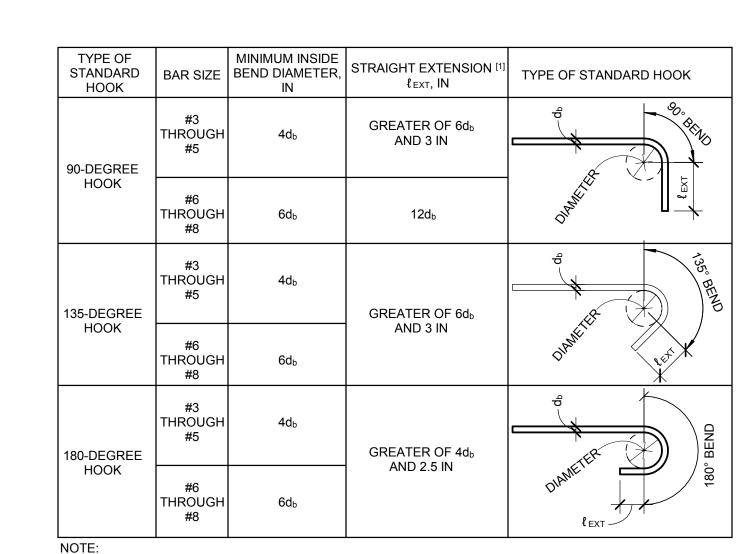
2. TOP BARS ARE HORIZONTAL BARS WITH MORE THAN 12 INCHES OF CONCRETE CAST BELOW THE BARS. 3. OTHER BARS INCLUDE VERTICAL BARS AND HORIZONTAL BARS WITH LESS THAN 12 INCHES OF CONCRETE CAST BELOW HORIZONTAL BARS. 4. BAR SPLICES NOT COVERED BY THIS SCHEDULE ARE SPECIFICALLY DETAILED AND DIMENSIONED PER PLANS.

5. ALL SPLICES SHALL BE CLASS 'B' UNLESS OTHERWISE ON PLANS.

6. FOR DEVELOPMENT LENGTH, Ld, USE CLASS 'A' LAP SPLICE LENGTH. 7. FOR LAP SPLICES OF BARS IN SHEAR WALLS, REFER TO LAP SPLICE AND DEVELOPMENT SCHEDULE IN CONCRETE WALL ELEVATIONS.

8. THIS SCHEDULE IS FOR GR 60 REINFORCEMENT. 9. CAN USE 1.25Ld IN LIEU OF NOTE 7 @ SHEAR WALLS. 10. FOR STAGGERED SPLICES, CLEAR SPACING SHOWN IN DIAGRAM MAY BE USED TO DETERMINE CASE 1 OR CASE 2 PER NOTE 1

TYPICAL REINFORCEMENT LAP SPLICE - NORMAL WEIGHT CONCRETE



1. ACI 318-14 TABLE 25.3.2 STANDARD HOOK GEOMETRY-STIRRUPS, TIE & HOOPS.


TYPICAL STANDARD HOOK GEOMETRY -STIRRUPS, TIES & HOOPS

SCALE: 1" = 1'-0"


TYPE OF STANDARD HOOK	BAR SIZE	MINIMUM INSIDE BEND DIAMETER, IN	STRAIGHT EXTENSION [1] \$\emptyset{\emptyset}{\emptyset}\text{EXT, IN}	TYPE OF STANDARD HOOK
	#3 THROUGH #8	6d _b		POINT AT WHICH BAR IS DEVELOPED
90-DEGREE HOOK	#9 THROUGH #11	8d₀	12d _b	SEXT SEXT
	#14 THROUGH #18	10d₀		ℓ _{dh}
	#3 THROUGH #8	6d _b		POINT AT WHICH BAR IS DEVELOPED
180-DEGREE HOOK	#9 THROUGH #11	8d _b	GREATER OF 4d♭ AND 2.5 IN	180° BEND
	#14 THROUGH #18	10d₅		ℓ _{EXT}

1. ACI 318-14 TABLE 25.3.2.

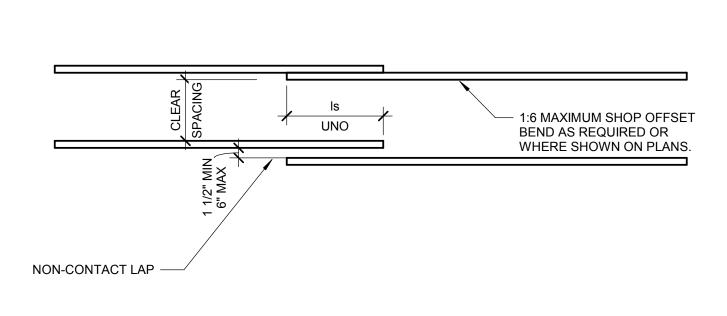STANDARD HOOK GEOMETRY - BARS DEVELOPED IN TENSION 4 DEVELO



TYPICAL LAP SPLICES

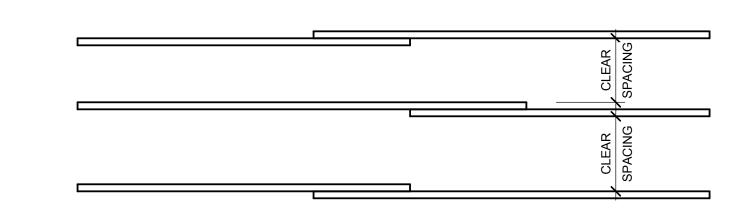

TYPICAL LAP SPLICES

NOTES:
1. CASES 1 AND 2 WHICH DEPEND ON CLEAR CONCRETE COVER AND THE CENTER-TO-CENTER SPACING OF THE BARS ARE DEFINED AS: CASE 1: COVER AT LEAST 1db AND CLEAR SPACING AT LEAST 2db.
CASE 2: COVER LESS THAN 1db OR CLEAR SPACING LESS THAN 2db.
2. FOR STAGGERED SPLICES, CLEAR SPACING SHOWN IN DIAGRAM MAY BE USED TO DETERMINE

TYPICAL LAP SPLICES

CASE 1 OR CASE 2 PER NOTE 1.



ARCHITECT STAMP CONSULTANT STAMP AGENCY APPROVAL

DESCRIPTION 100% DD SUBMITTAL PROGRESS SET 03/29/2019

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PROJECT OWNER & TITLE

MT. SAN JACINTO COMMUNITY COLLEGE DISTRICT

TEMECULA VALLEY **CAMPUS**

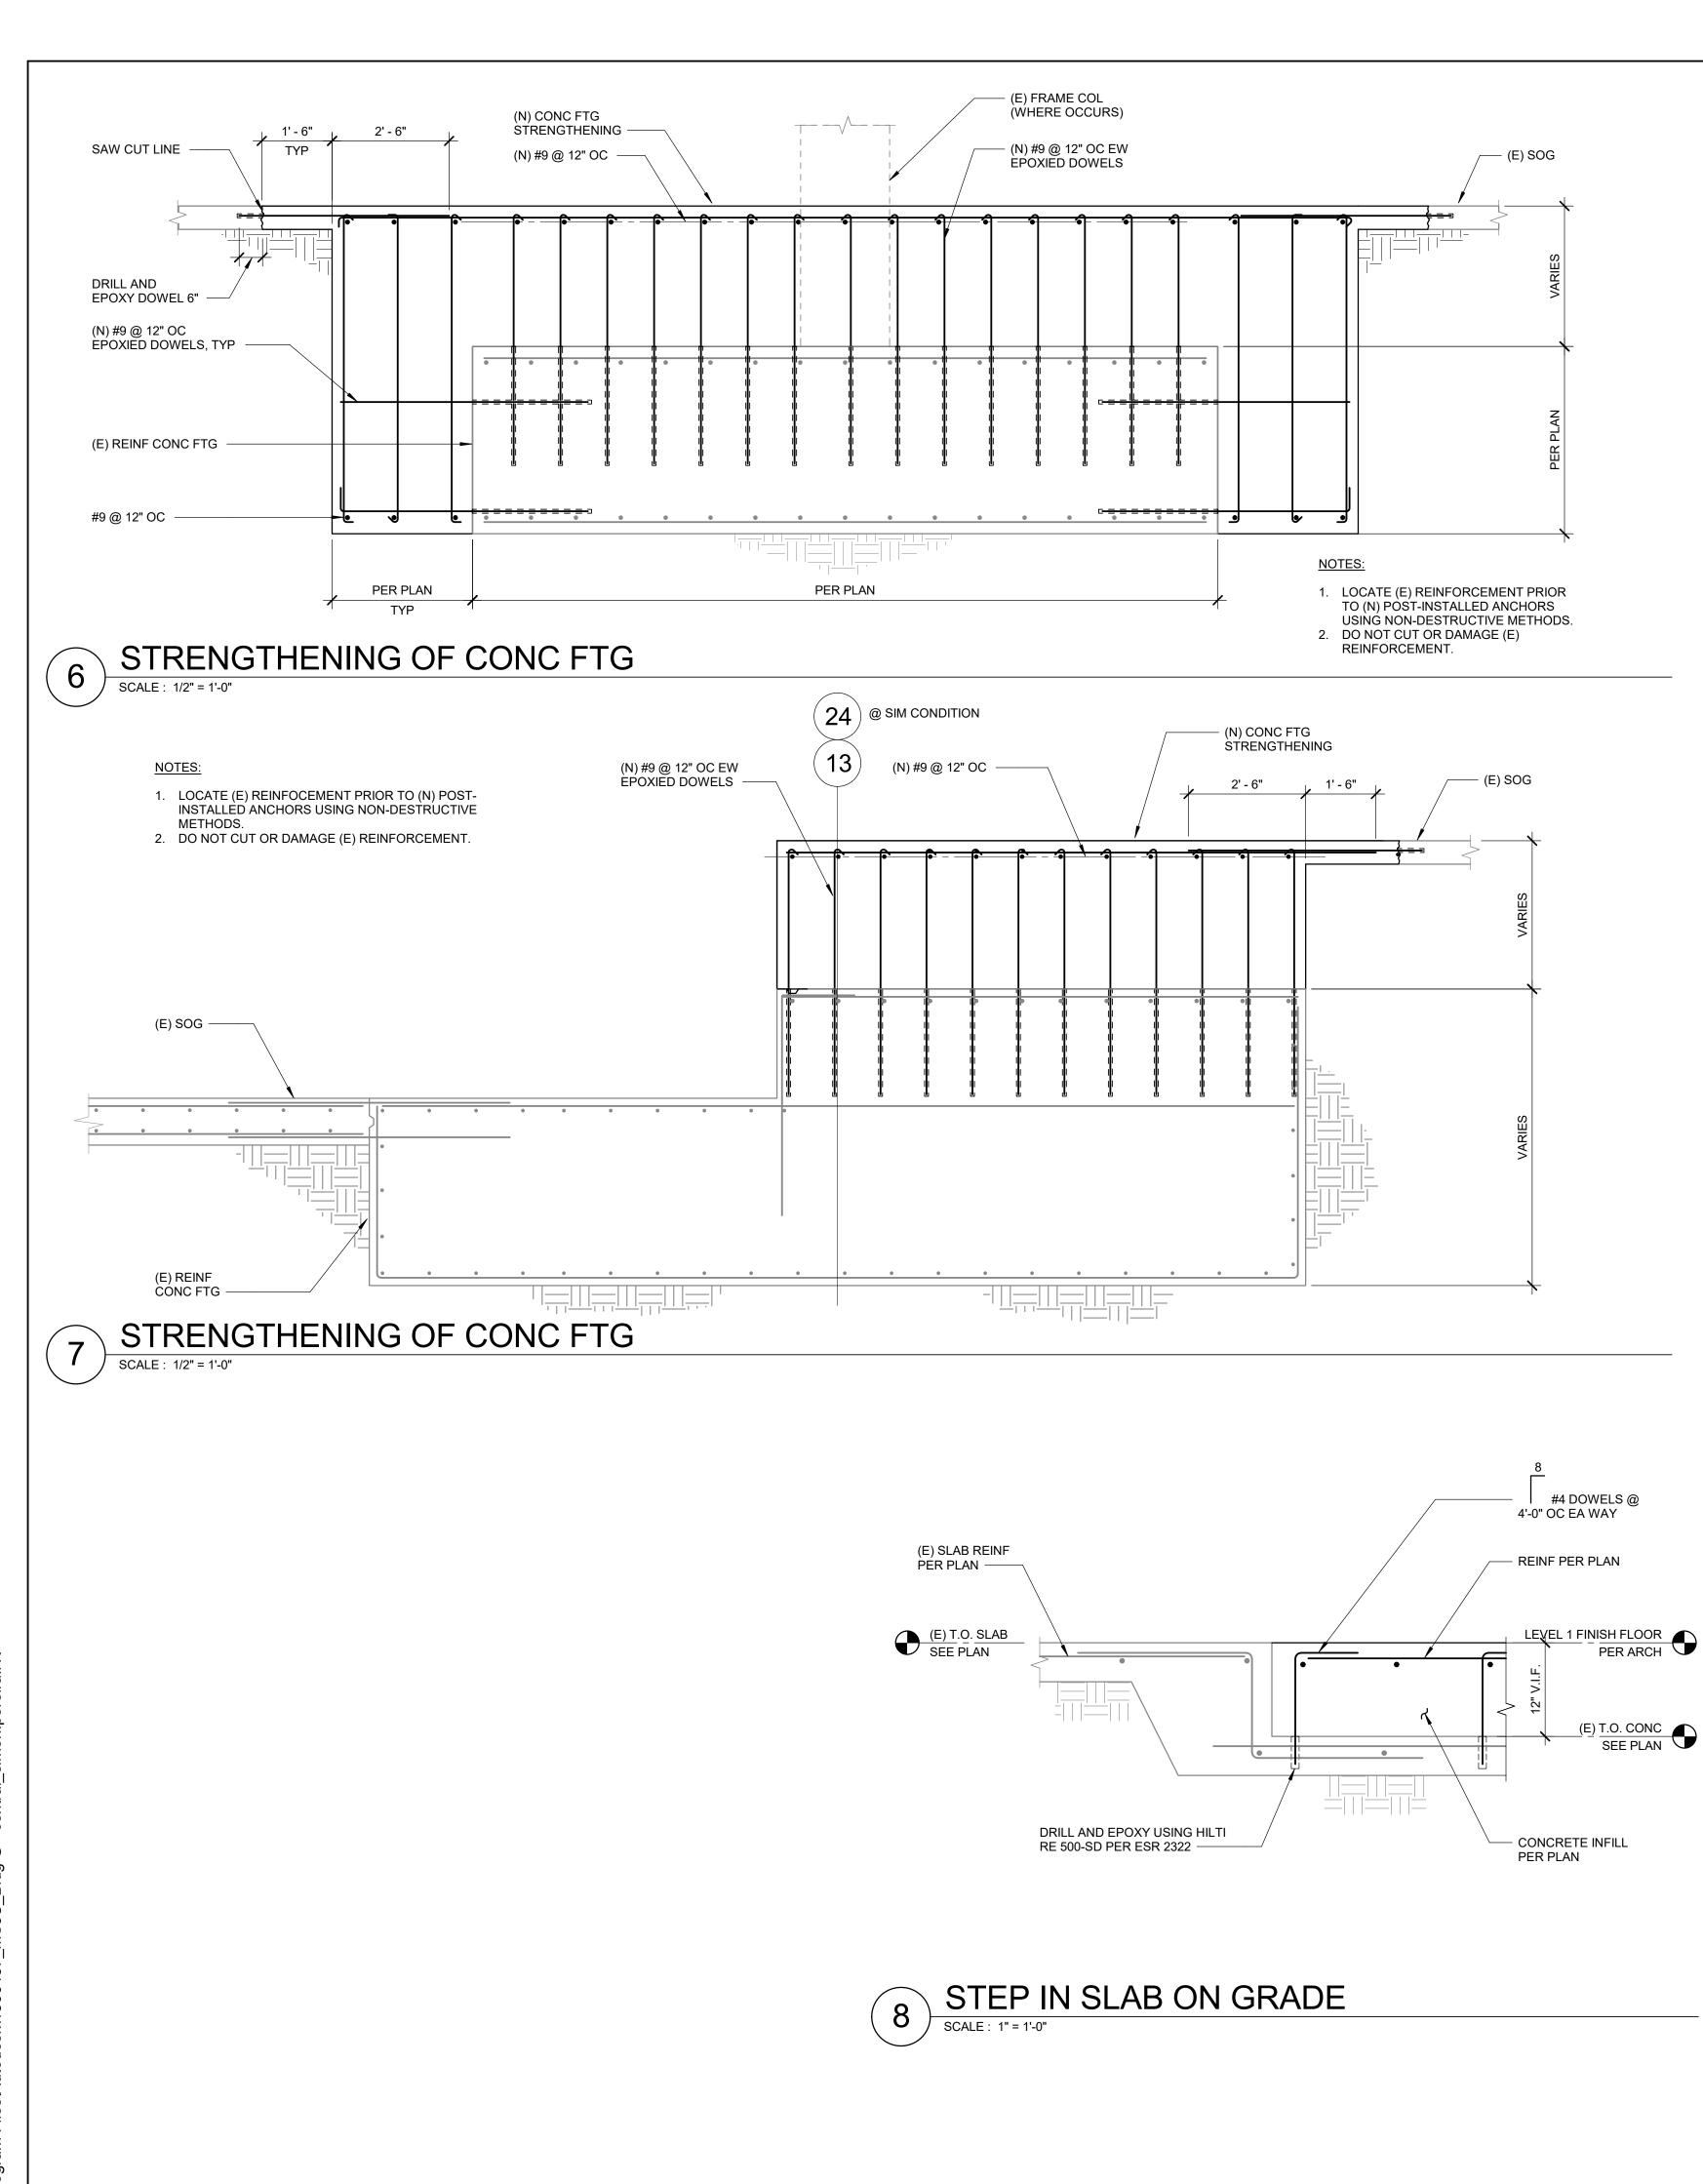
41888 Motor Car Pkwy, Temecula, CA 92591

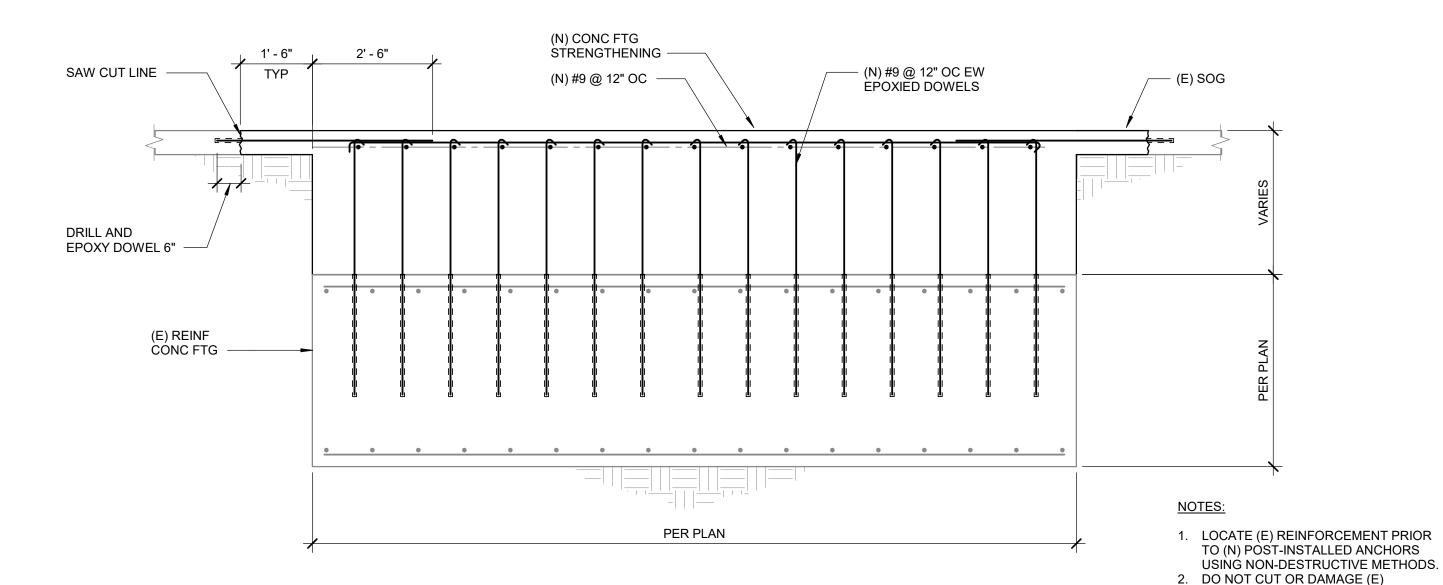
SHEET TITLE

TYPICAL CONCRETE **DETAILS**

> JOB NUMBER: 1800457 DRAWN BY: Author SHEET NO.

S-500 DATE: Issue Date





STRENGTHENING OF CONC FTG

(N) METALDECK TO MATCH (E) AND OVERLAP

(N) COLUMN COVER PLATE PER 2/S-601

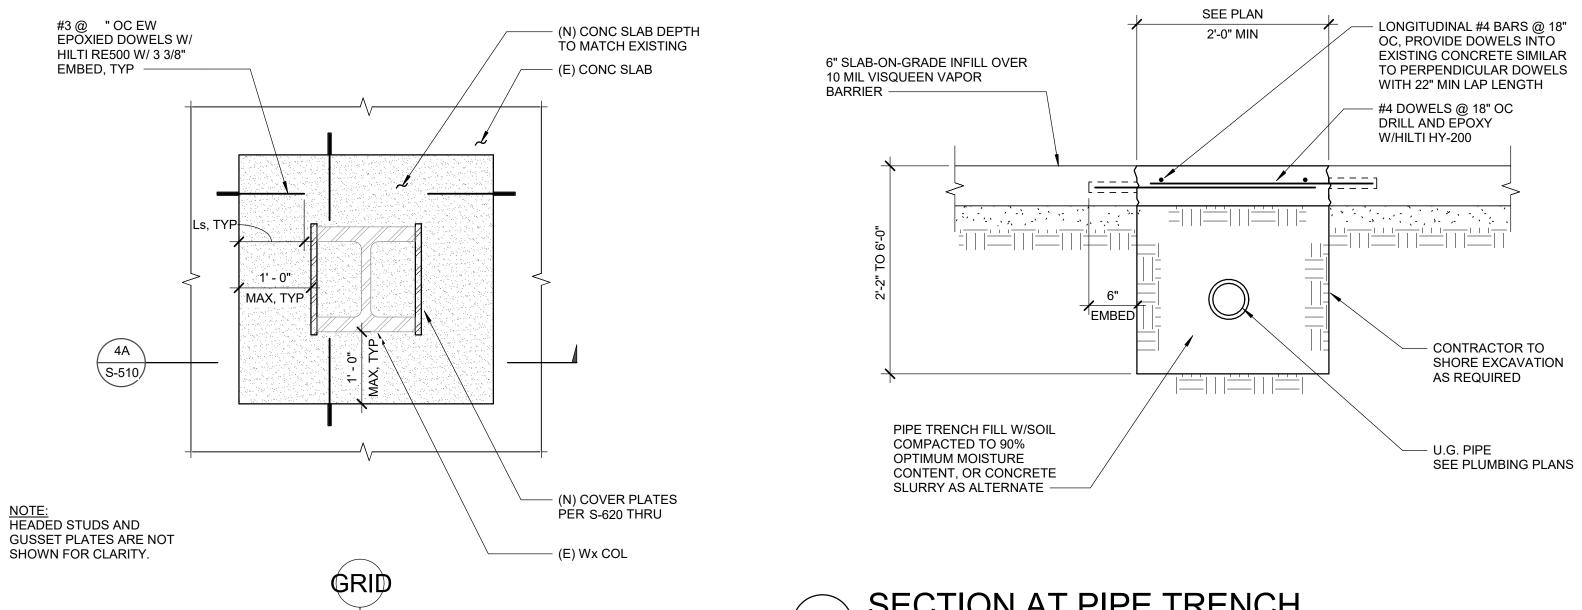
(E) STEEL COLUMN

CONSTR JOINT

(4A) SECTION

SLAB REPAIR AROUND COLUMN

W/ (E) METAL DECK



- (N) REBAR

— (N) CONC SLAB

— (E) STEEL BEAM

- FILL AROUND COLUMN W/

(E) COLUMN

(N) COVER PLATES

JOINT TYP

CONCRETE TO MATCH (E) SOG

(E) CONC

ŠĽAB

SECTION AT PIPE TRENCH

	"TOP" REINFORCI	EMENT	"OTHER" REINFORCEMENT				
BAR SIZE	DEVELOPMENT LENGTH (I _d)	SPLICE LENGTH (I _S)	DEVELOPMENT LENGTH (Id)	SPLICE LENGTI			
#3	1'-7"	2'-0"	1'-3"	1'-7"			
#4	2'-1"	2'-8"	1'-7"	2'-1"			
#5	2'-7"	3'-4"	2'-0"	2'-7"			
#6	3'-1"	4'-0"	2'-5"	3'-1"			
#7	4'-6"	5'-11"	3'-6"	4'-6"			
#8	5'-2"	6'-9"	4'-0"	5'-2"			
#9	5'-10"	7'-7"	4'-6"	5'-10"			
#10	6'-7"	8'-6"	5'-1"	6'-7"			
#11	7'-3"	9'-6"	5'-7"	7'-3"			

REINFORCEMENT.

- 1. USE SPLICE LENGTH (Is) INDICATED ON TABLE FOR ALL DOWEL LENGTHS NOT SHOWN ON PLANS UNLESS OTHERWISE PERMITTED BY ENGINEER.
 - 2. DEVELOPMENT LENGTHS (Id) AND SPLICE LENGTHS (Is) SHOWN IN THE SCHEDULE ABOVE ARE IN ACCORDANCE WITH ACI 318-05 AND CORRESPOND TO GRADE 60 BARS EMBEDDED IN NORMAL WEIGHT CONCRETE (f'c=4000 PSI). FOR CONCRETE WITH f'c=3000 psi MULTIPLY VALUES IN TABLE BY 1.16. FOR LT
 - 3. THIS SCHEDULE SHALL BE USED WHERE DEVELOPMENT AND SPLICE LENGTHS ARE NOT SPECIFICALLY
 - 4. THE SCHEDULE ABOVE IS APPLICABLE FOR THE FOLLOWING CONDITIONS:
 - a) CLEAR SPACING OF BARS BEING DEVELOPED OR SPLICED NOT LESS THAN db, CLEAR COVER NOT LESS THAN db, AND STIRRUPS OR TIES THROUGHOUT Id NOT LESS THAN THE CODE MINIMUM.
 - COVER NOT LESS THAN db.
 - OF FRESH CONCRETE IS CAST IN THE MEMBER BELOW THE DEVELOPMENT OR SPLICE LENGTH. "OTHER" REINFORCEMENT INCLUDES ALL VERTICAL BARS AND HORIZONTAL BARS WITH LESS THAN 12" OF CONCRETE CAST BELOW BAR.
 - 6. WHERE BARS OF DIFFERENT SIZE ARE LAP SPLICED, SPLICE LENGTH SHALL BE THE LARGER OF DEVELOPMENT LENGTH OF LARGER BAR, OR SPLICE LENGTH OF SMALLER BAR.

DEVELOPMENT AND SPLICES OF 3 REINFORCEMENT
SCALE: 1" = 1'-0"

- WT AGGREGATE CONCRETE, MULTIPLY VALUES IN TABLE BY 1.3.
- DETAILED AND DIMENSIONED ON THE DRAWINGS.

- b) CLEAR SPACING OF BARS BEING DEVELOPED OR SPLICED NOT LESS THAN 2d b AND CLEAR
- 5. "TOP" REINFORCEMENT IS DEFINED AS HORIZONTAL REINFORCEMENT SO PLACED THAT MORE THAN 12"
- 7. THE LAP SPLICES ARE CLASS B.

ARCHITECTS

SANTA BARBARA, CA 93103 TEL (805) 963-1955 CONSULTANTS

802 EAST COTA STREET, SUITE A

CONSULTANT STAMP

AGENCY APPROVAL

DESCRIPTION 100% DD SUBMITTAL PROGRESS SET 03/29/2019

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PROJECT OWNER & TITLE

MT. SAN JACINTO **COMMUNITY COLLEGE** DISTRICT

TEMECULA VALLEY CAMPUS

41888 Motor Car Pkwy, Temecula, CA 92591

SHEET TITLE

CONCRETE DETAILS

JOB NUMBER: 1800457 DRAWN BY: Author

SHEET NO. **S-510** DATE: Issue Date

(E) SLAB ON GRADE REPAIR DETAIL

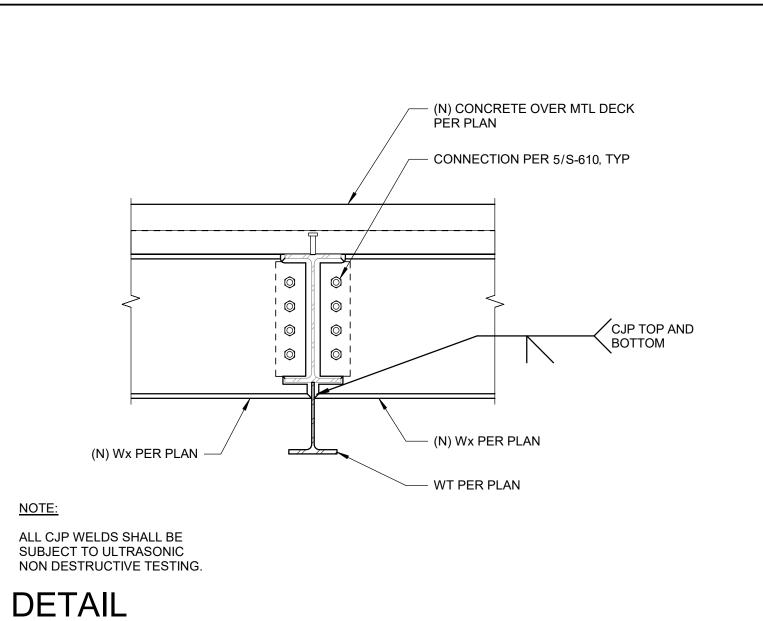
SCALE: 1" = 1'-0"

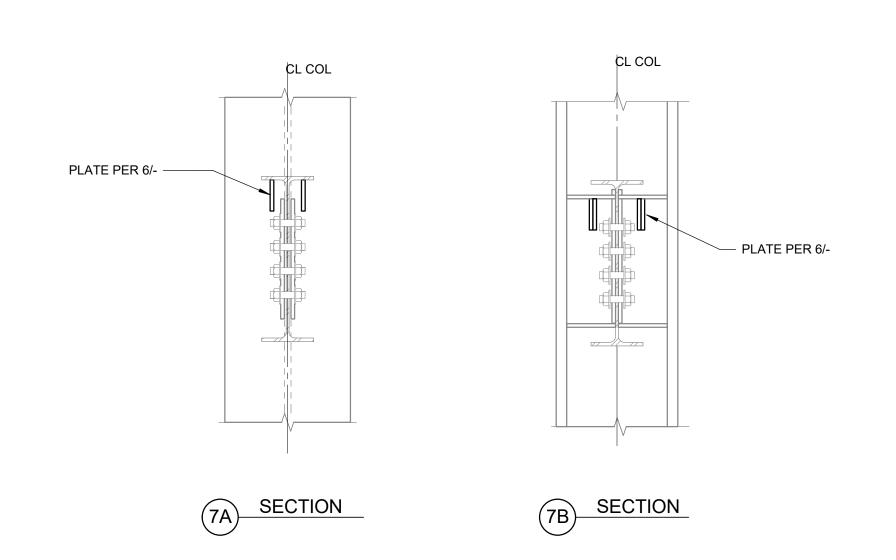
PREVENT BOND -

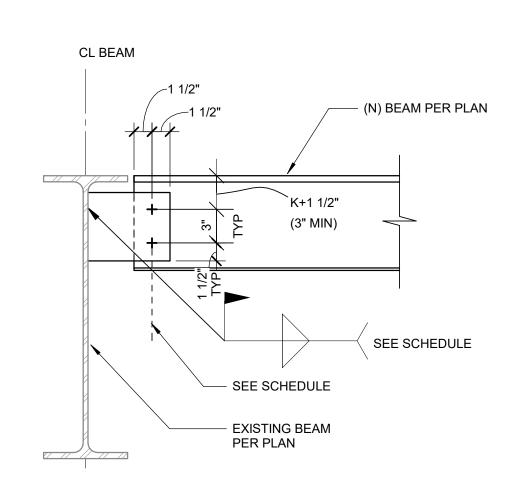
— 1:4 SLOPE MAX

1 1/2" CONT KEY

CONSTRUCTION JOINT










SCALE: 1" = 1'-0"

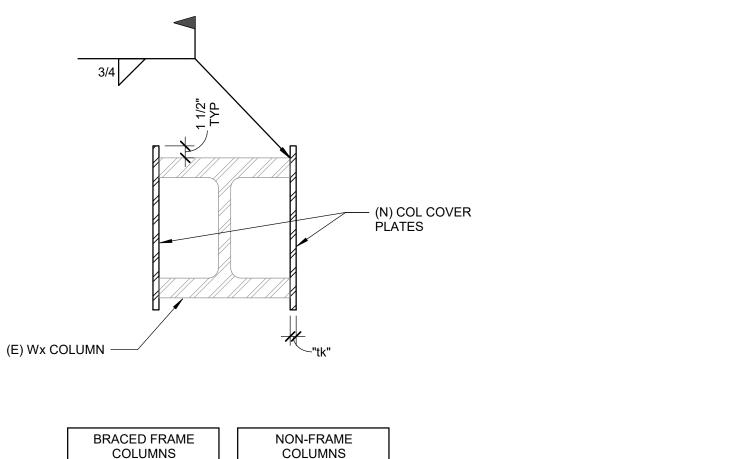

FLOOR tk


1st-5th 5/8"

7	DRAG CONNECTION STRENGTHENING									
	SCALE: 1" = 1'-0"									



CONNECTION NOTES:

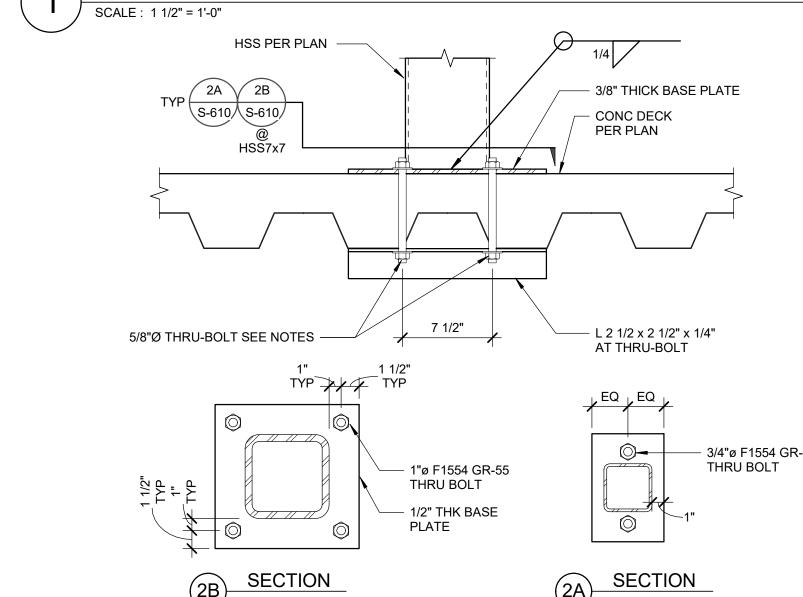
1. ALL BOLTS TO BE ASTM A325-N.




NOT USED



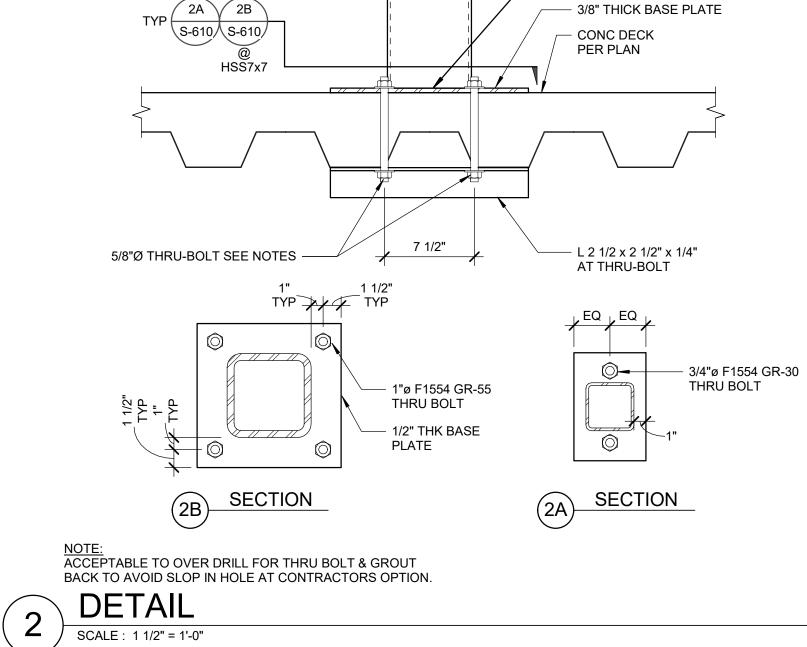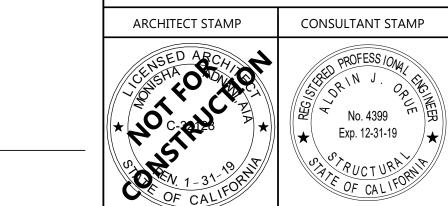1/4"





DESCRIPTION 100% DD SUBMITTAL

PROGRESS SET

03/29/2019

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RESPONSIBILITY FOR THESE PLANS AND

PROJECT OWNER & TITLE

MT. SAN JACINTO

COMMUNITY COLLEGE

AGENCY APPROVAL

Wx FRAME COLUMN STRENGTHENING

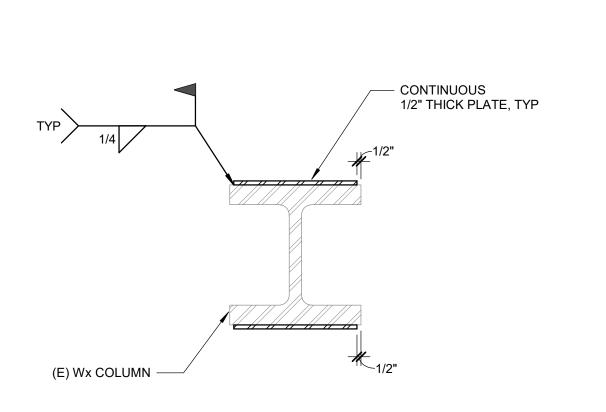
SCALE: 1" = 1'-0"

1 1/2"

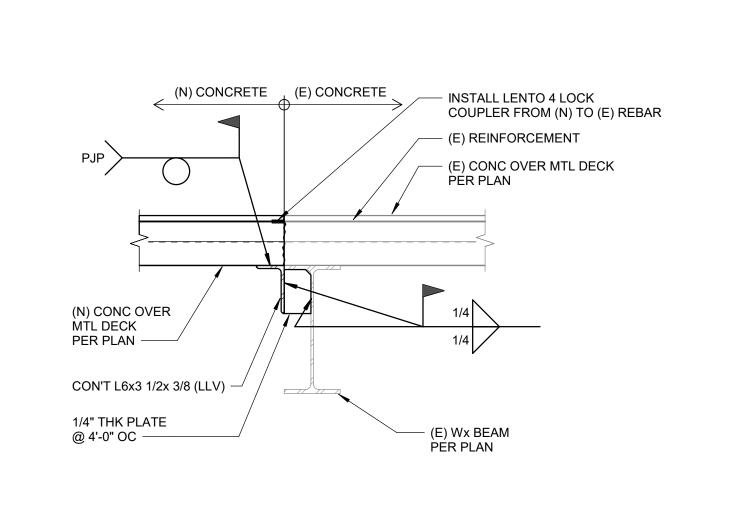
FLOOR

1st-2nd

3rd-4th








NEW TO EXISTING CONCRETE CONN.

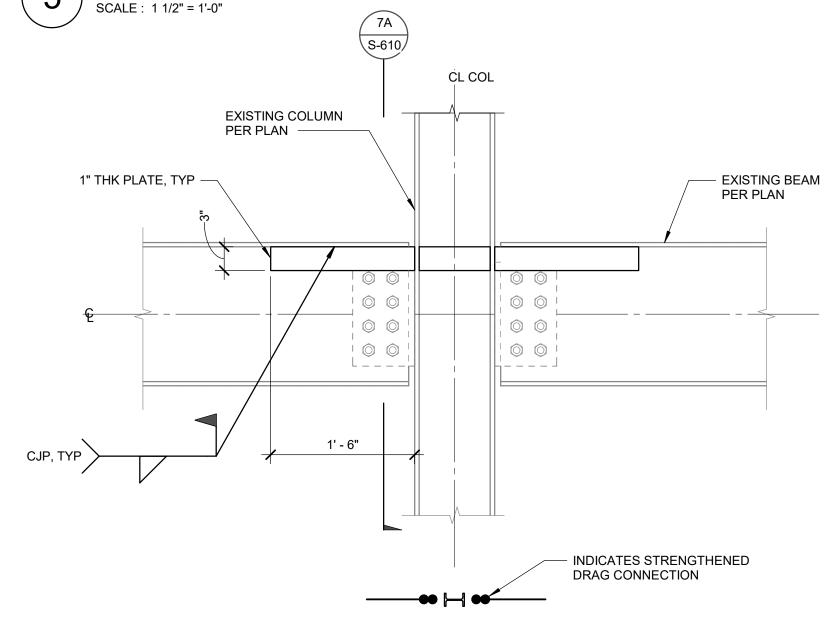- (E) Wx BEAM



DRAG CONNECTION AT COL FLANGE

CL COL

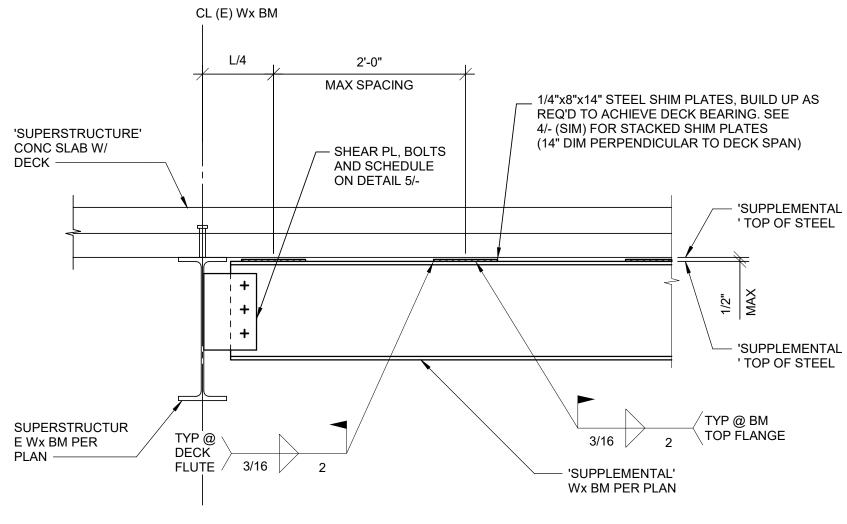
2. BOLTS IN BEAM TO BEAM CONNECTIONS SHALL BE TIGHTENED TO AISC "SNUG

3. CONNECTION PLATES TO HAVE AISC STANDARD ROUND HOLES UNLESS NOTED


5. CONTRACTOR OPTION TO REPLACE BOLTS WITH A 1/4" FILLET FIELD WELD FULL

TIGHT" CONDITION UNLESS NOTED OTHERWISE IN DETAILS

4. ALL CONNECTION PLATE MATERIAL TO BE A992 GR 50.



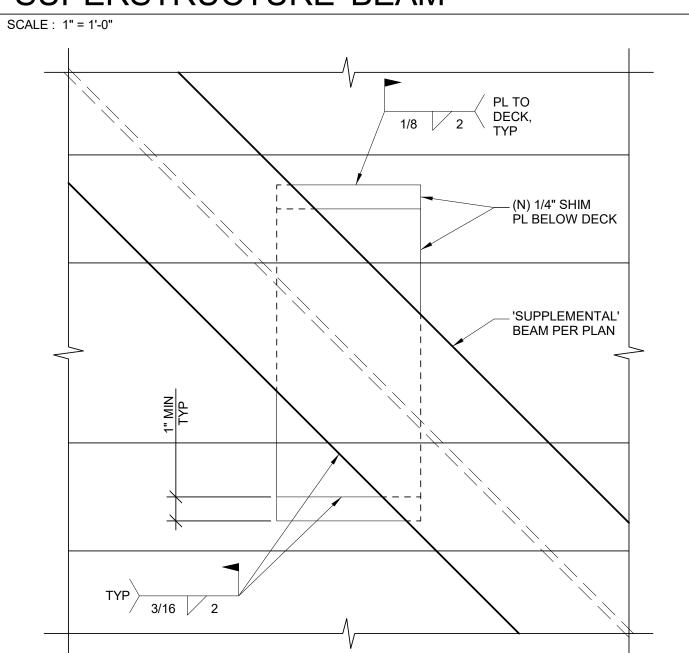
'SUPPLEMENTAL' BEAM CONNECTION TO 'SUPERSTRUCTURE' BEAM



'SUPPLEMENTAL' BEAM TO DECK SHIM DETAIL

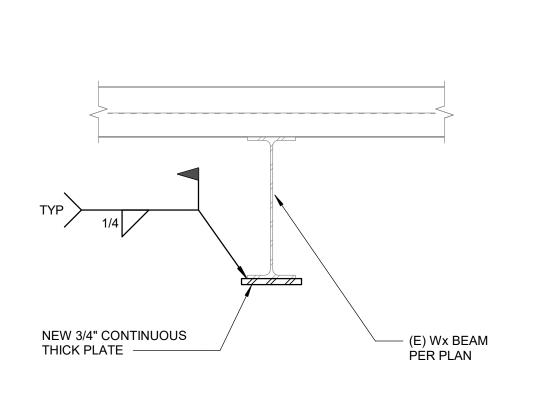SCALE: 3" = 1'-0"






TYP Wx BEAM STRENGTHENING

SCALE: 1" = 1'-0"



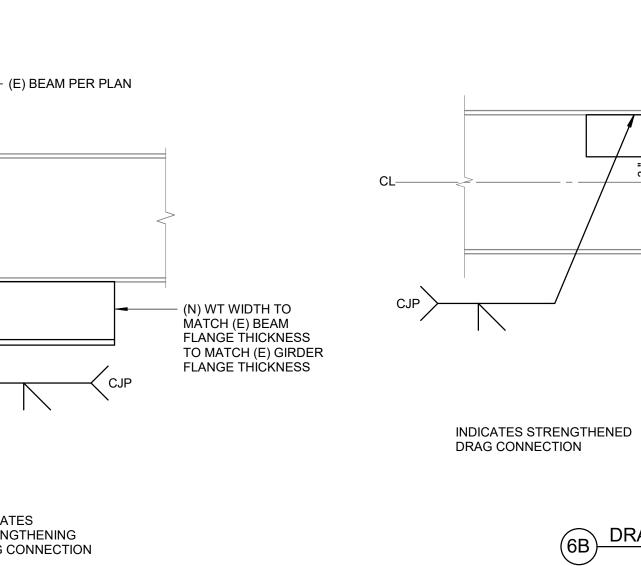STRENGTHENING DRAG CONNECTION



6 DRAG CONNECTION (STRENGTHENING)

SCALE: 1" = 1'-0"

(6B) DRAG CONNECTION TO COL WEB

EXISTING COLUMN

PER PLAN

PER PLAN

- EXISTING BEAM

TEMECULA VALLEY CAMPUS 41888 Motor Car Pkwy, Temecula, CA 92591 SHEET TITLE

DISTRICT

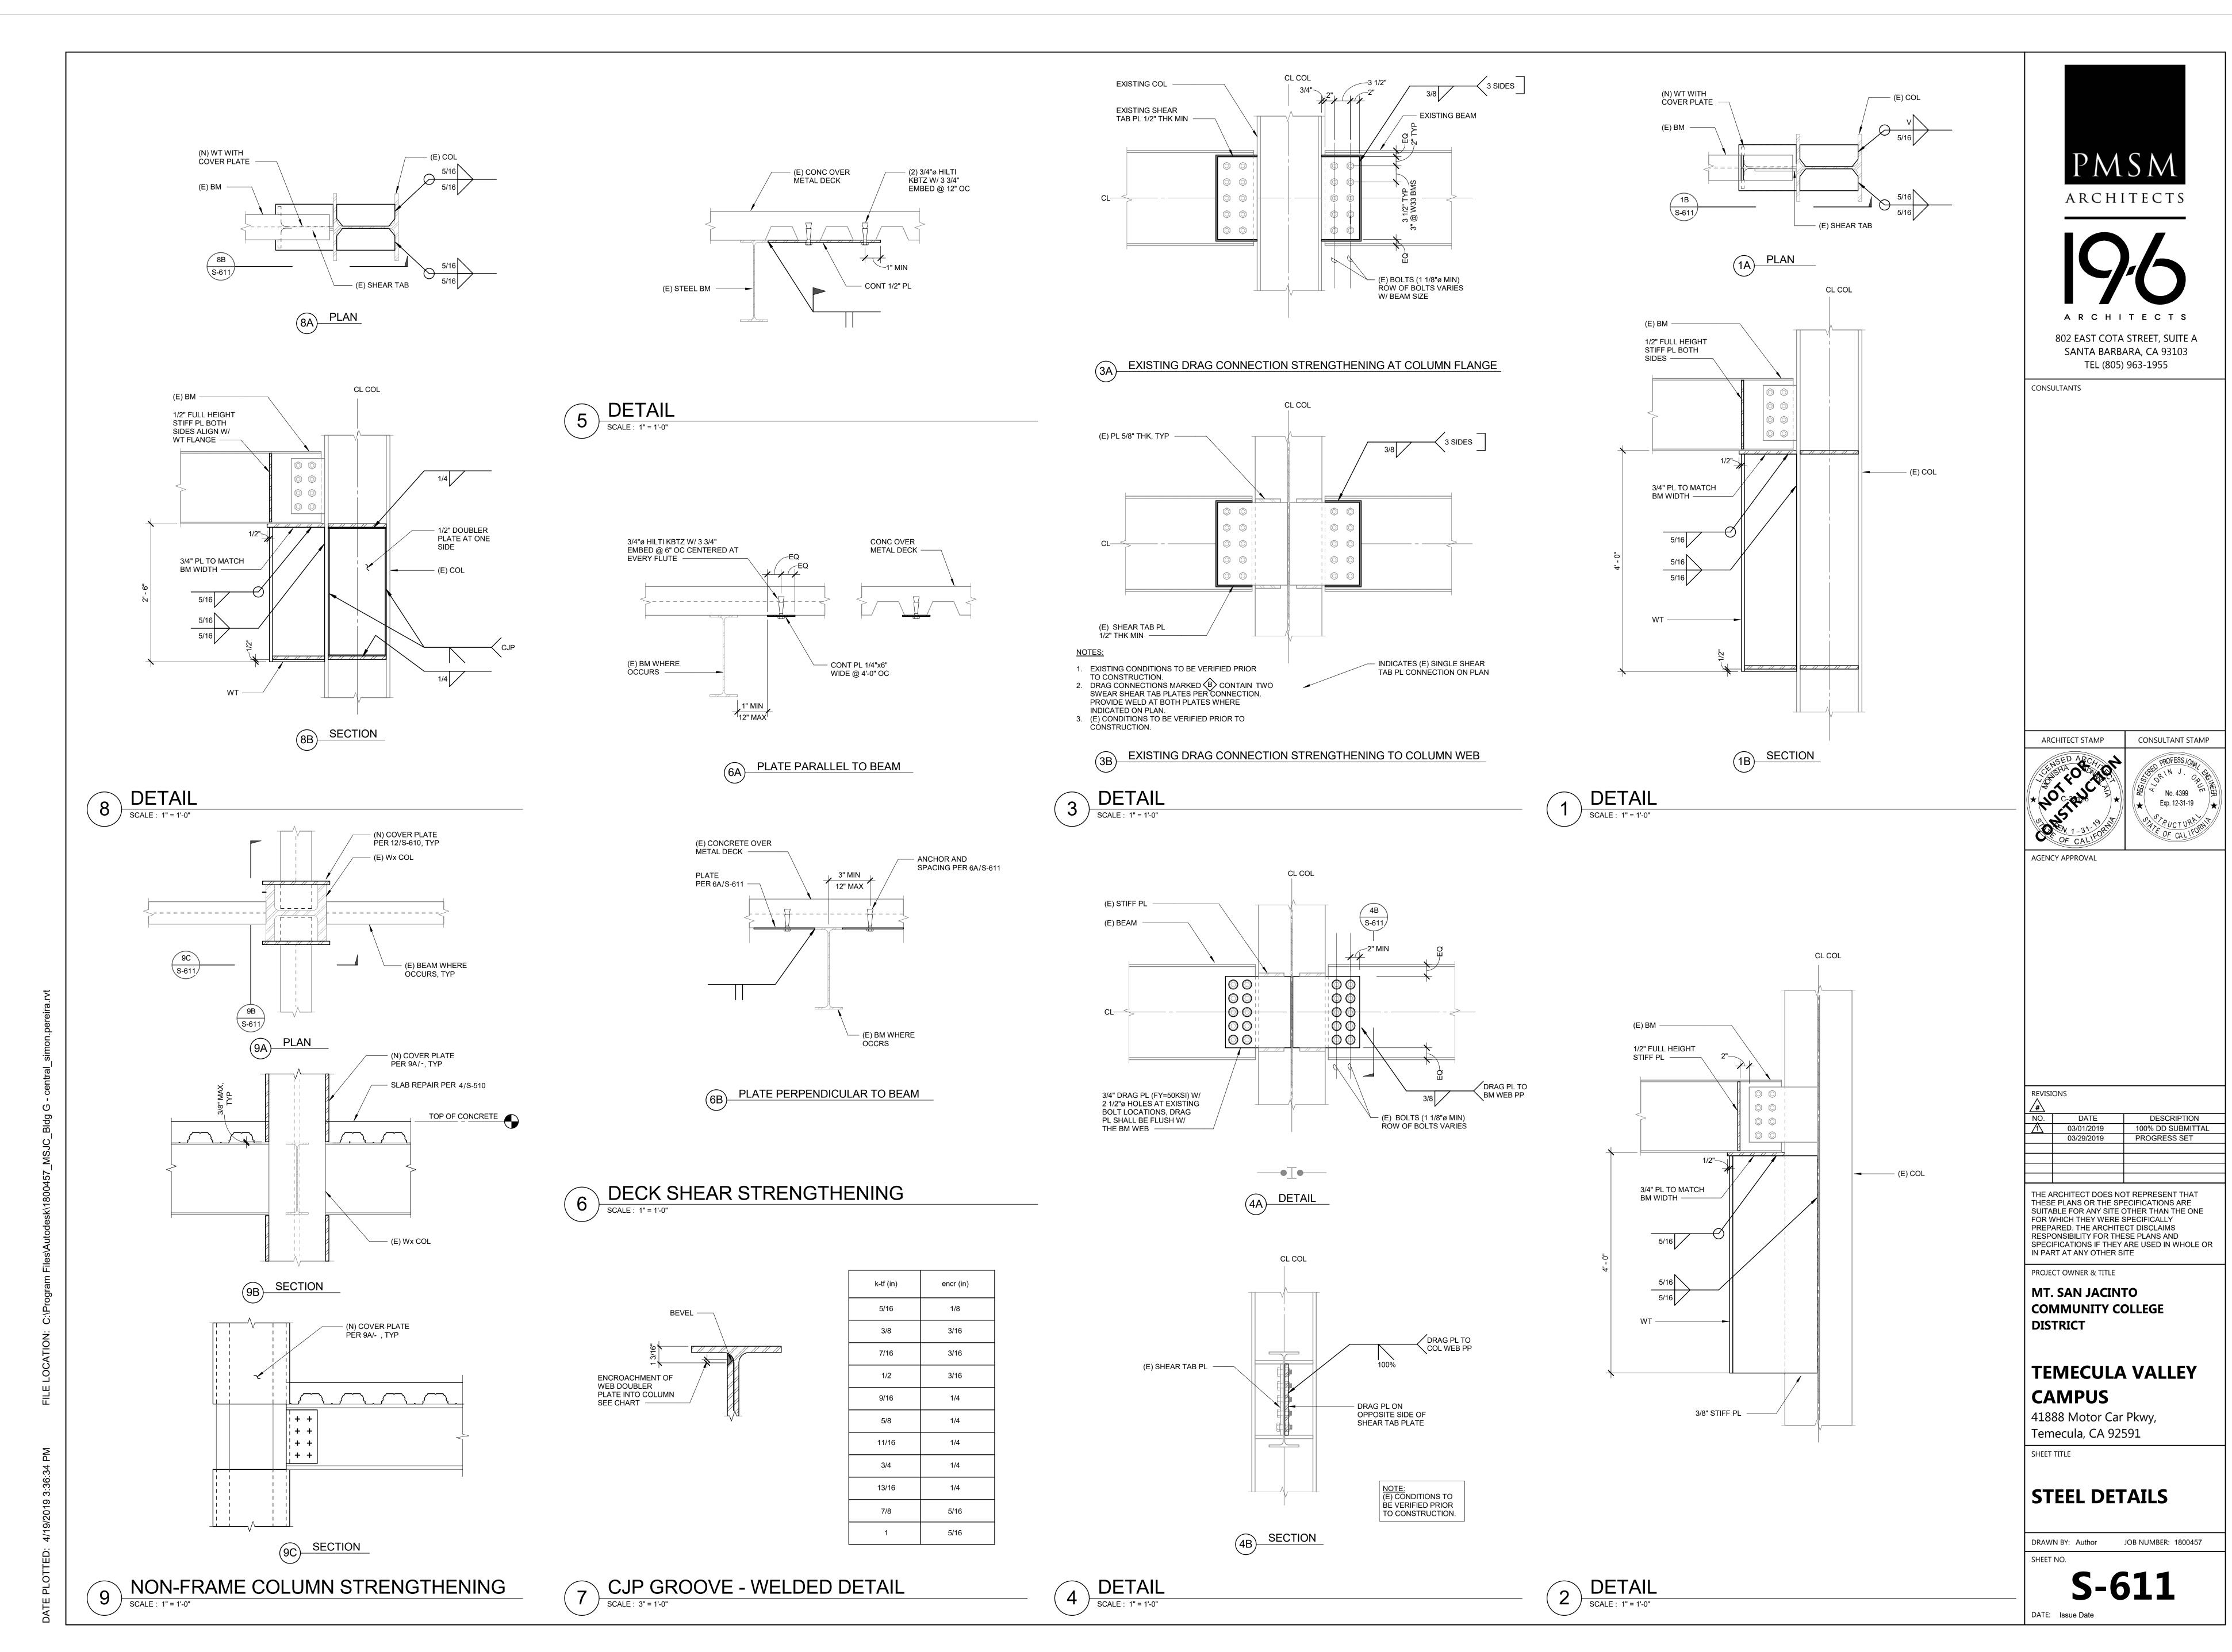
STEEL DETAILS

DRAWN BY: Author

DATE: Issue Date


SHEET NO. **S-610**


JOB NUMBER: 1800457




Project Status

SYMBOL IN PLAN	DETAIL	ALTERNATE DETAIL	REMARK
A	2/S6.12	3/\$6.12	
В	4/S6.12	NONE	
0	1/S6.11	NONE	
			<u> </u>

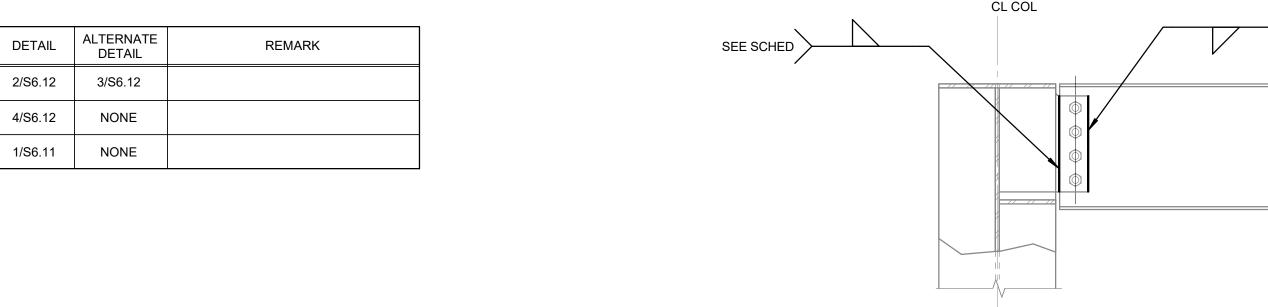

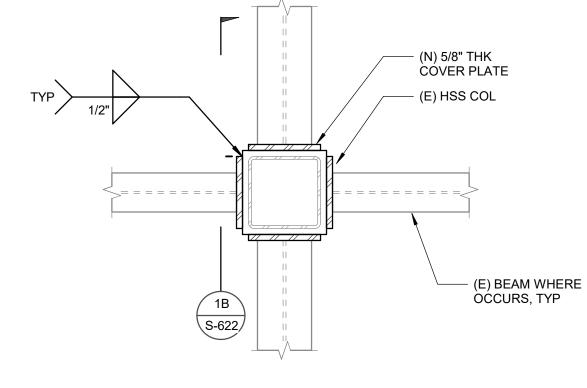




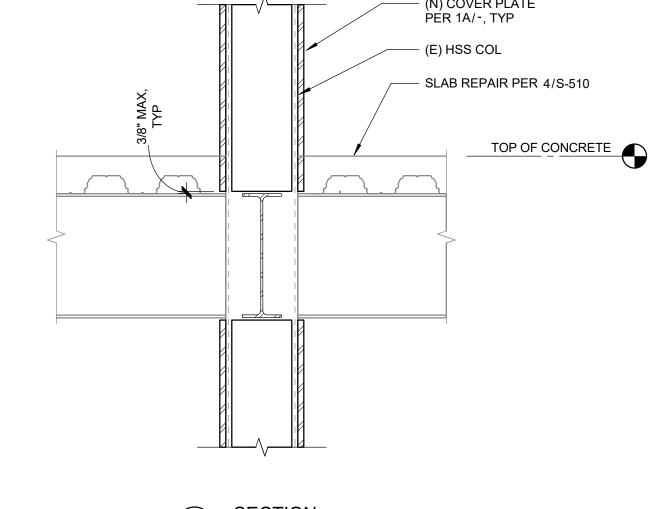

NOTE: THIS DETAIL SHALL NOT BE USED WITHOUT PRIOR PERMISSION FROM SEOR.

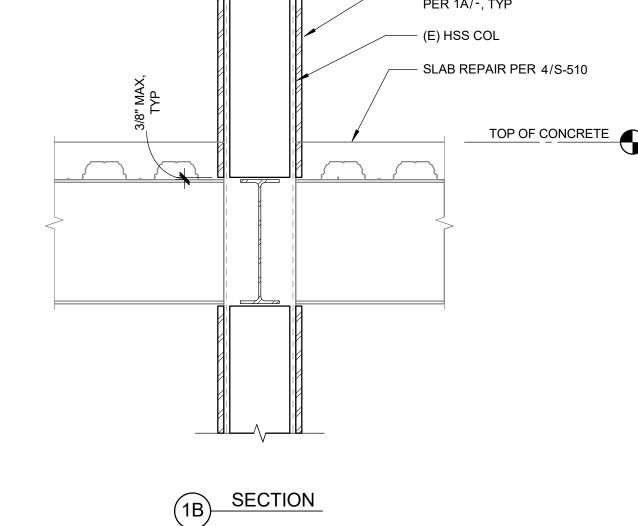NON-FRAME COLUMN STRENGTHENING SCALE: 3/4" = 1'-0"



ARCHITECT STAMP	CONSULTANT STAMP
CHISED ARCHICLE COLOR A COLO	PROFESS IONAL PROFESS IONAL PROFESS IONAL PROFESS IONAL PROPESS IONAL PR
AGENCY APPROVAL	

DATE DESCRIPTION

03/01/2019 100% DD SUBMITTAL

03/29/2019 PROGRESS SET

ARCHITECTS

802 EAST COTA STREET, SUITE A SANTA BARBARA, CA 93103

TEL (805) 963-1955

CONSULTANTS

CL COL	SEE SCHEDULE 3 SIDES, TYP

CL COL	THE ARCHITECT DOES NOT REPRESENT THAT THESE PLANS OR THE SPECIFICATIONS ARE SUITABLE FOR ANY SITE OTHER THAN THE ONE FOR WHICH THEY WERE SPECIFICALLY PREPARED. THE ARCHITECT DISCLAIMS RESPONSIBILITY FOR THESE PLANS AND SPECIFICATIONS IF THEY ARE USED IN WHOLE OR IN PART AT ANY OTHER SITE
SEE SCHEDULE 3 SIDES	PROJECT OWNER & TITLE
	MT. SAN JACINTO
	COMMUNITY COLLEGE
	DISTRICT
	TEMECULA VALLEY

TEMECULA VALLEY
CAMPUS

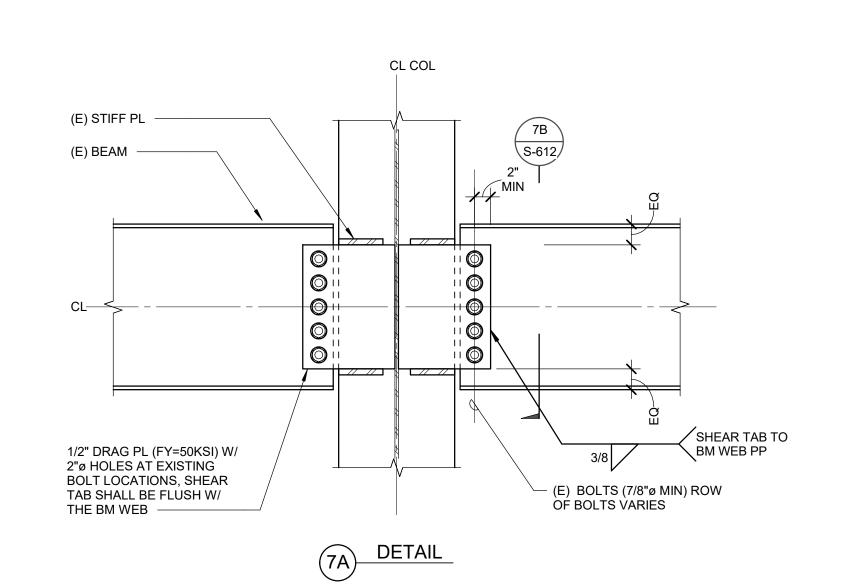
REVISIONS

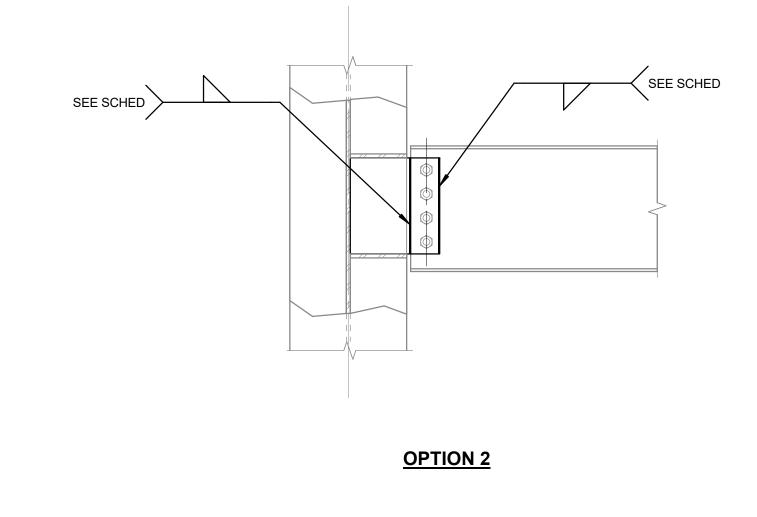
41888 Motor Car Pkwy, Temecula, CA 92591 SHEET TITLE

STEEL DETAILS

DRAWN BY: Author JOB NUMBER: 1800457 **S-612** DATE: Issue Date

STANDARD CONNECTION 6 STRENGTHENING SCHEDULE
SCALE: 3/4" = 1'-0"









CONNECTION NOTES: DOES NOT APPLY TO DRAG CONNECTIONS. FOR DRAG CONNECTIONS SEE DETAIL 3/S-611.

	DETAIL
4/	SCALE: 1" = 1'-0"

(E) SHE	AR TAB PL ——	CL COL	SHEAR TAB TO COL WEB PP 100% SHEAR TAB ON OPPOSITE SIDE OF SHEAR TAB PLATE
NOTE: (E) CONDITIONS TO BE VERIFIED PRIOR TO CONSTRUCTION.		SECTION	

7	DETAIL	
1	SCALE: 1" = 1'-0"	

EXISTING COL EXISTING SHEAR TAB PL 1/2" THK MINI TAKEN FROM 3A/S611		CL COL 3/4" 2" 3/8 EXISTING BEAM 9 1 1 1 1 1 1 1 1 1 1 1 1	'
CL -		3 12" TYP 3" @W33 BWS	
1/2 PLATE TO I WTX THICK	MATCH NESS	WTX FLAN WEB THIC TO MATC FLANGE N MATCH B	CKNESS H BM MIN. WIDTH TO


SYMBOL IN PLAN	DETAIL	ALTERNATE DETAIL	REMARK
A	3/\$6.11	4/S6.11	EXISTING SINGLE SHEAR TAB PLATE
B	3/\$6.11	NONE	EXISTING SINGLE SHEAR TAB PLATE
©	4/S6.11	NONE	EXISTING SINGLE SHEAR TAB PLATE
(1/S6.11	NONE	
Е	10/S6.10	NONE	
F	8/S6.12	NONE	

	DRAG CONNECTION
(<u>F</u>	STRENGTHENING SCHEDULE SCALE: 3/4" = 1'-0"
(3)	SCALE : 3/4" = 1'-0"

2 BEAM TO COLUMN WEB

SCALE: 1" = 1'-0"

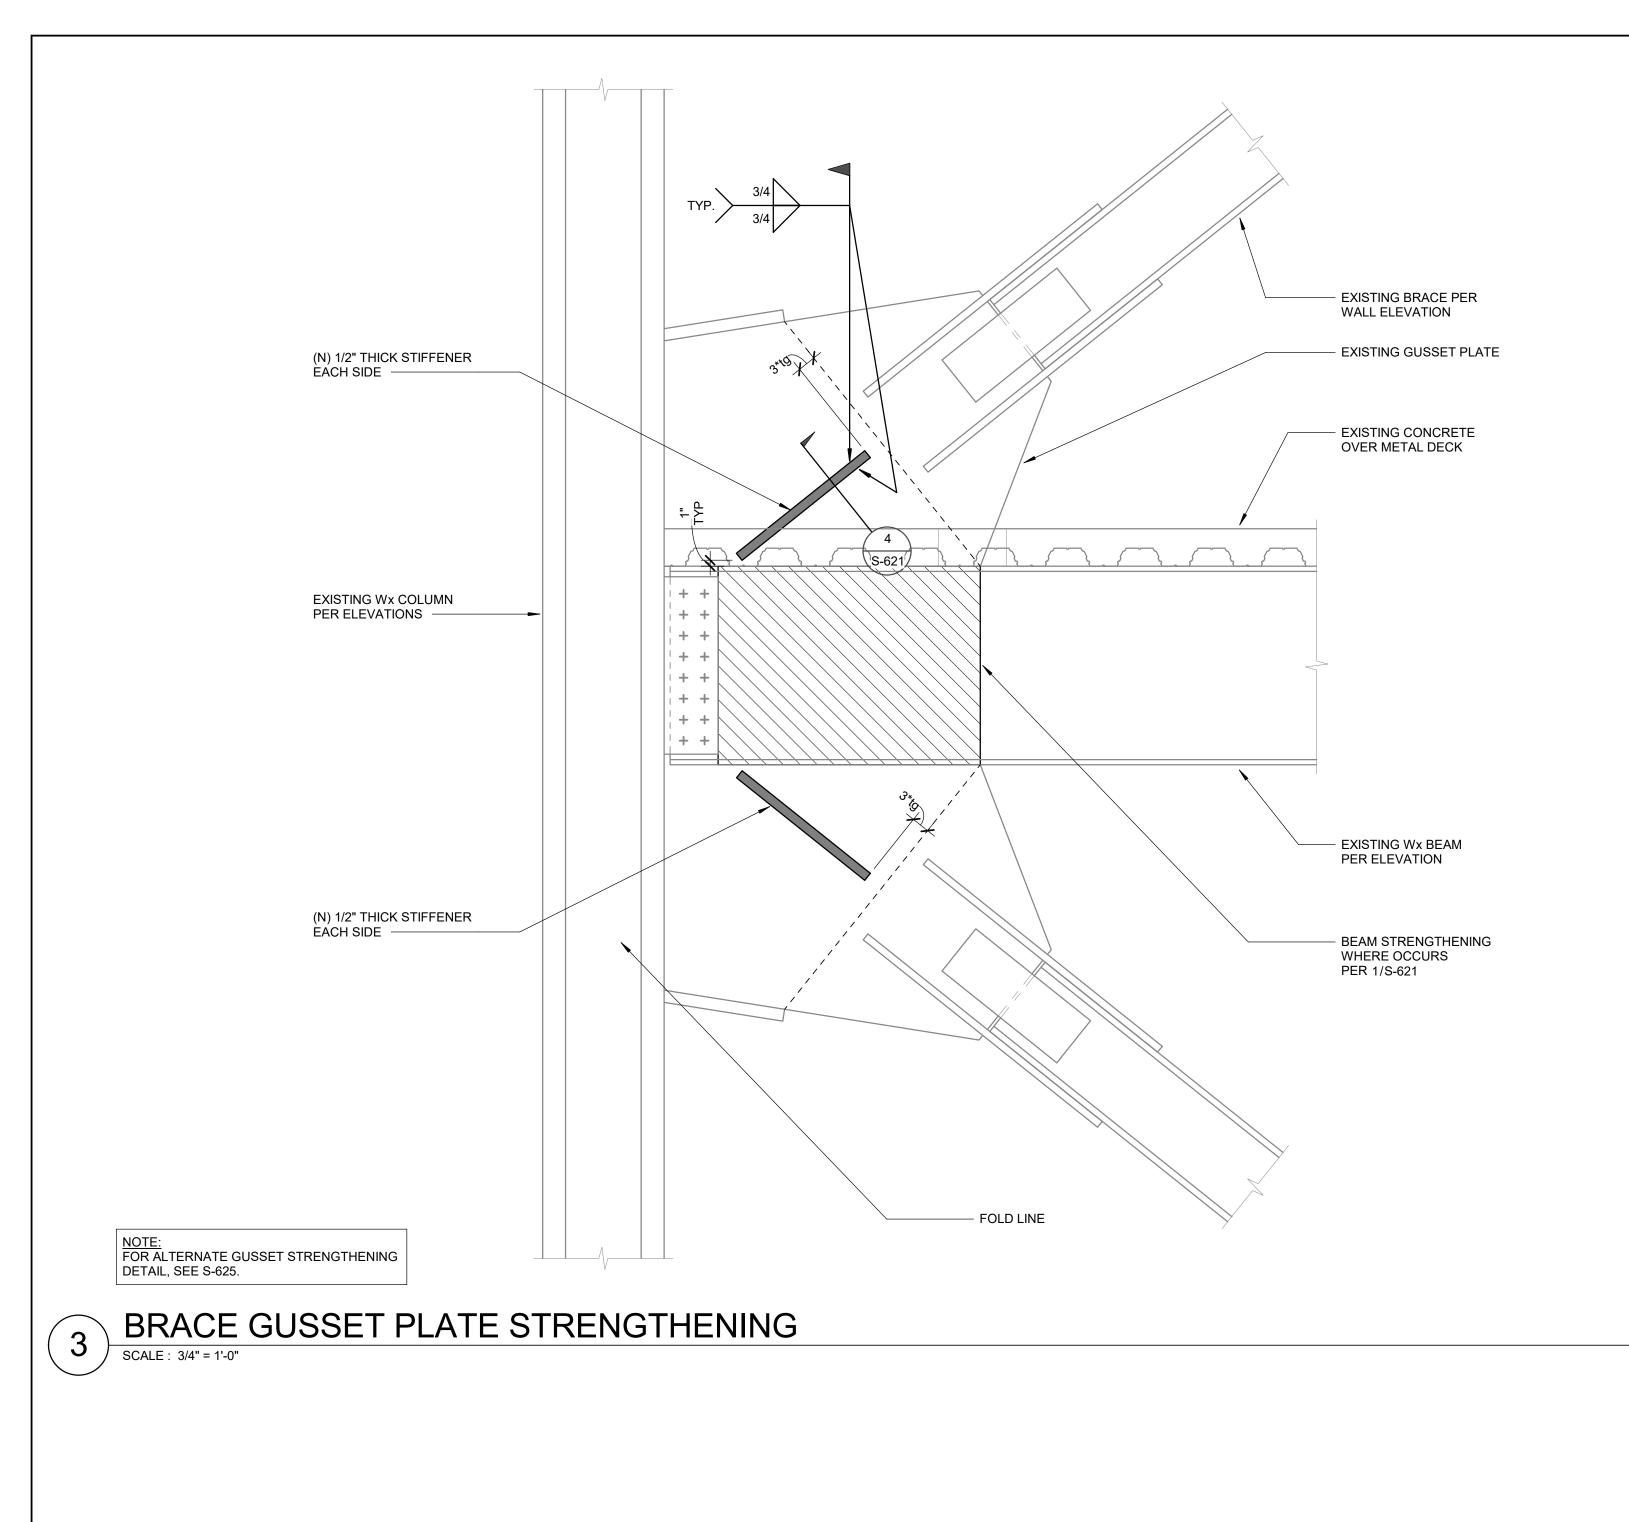
OPTION 1



- (N) 1/2" THICK STIFFENER EACH SIDE - EXISTING BRACE PER WALL ELEVATION - EXISTING GUSSET PLATE - EXISTING CONCRETE OVER METAL DECK S-621 - EXISTING Wx BEAM PER ELEVATION (N) 1/2" THICK STIFFENER EACH SIDE — - EXISTING GUSSET

NOTE: FOR ALTERNATE GUSSET STRENGTHENING DETAIL, SEE S-625.

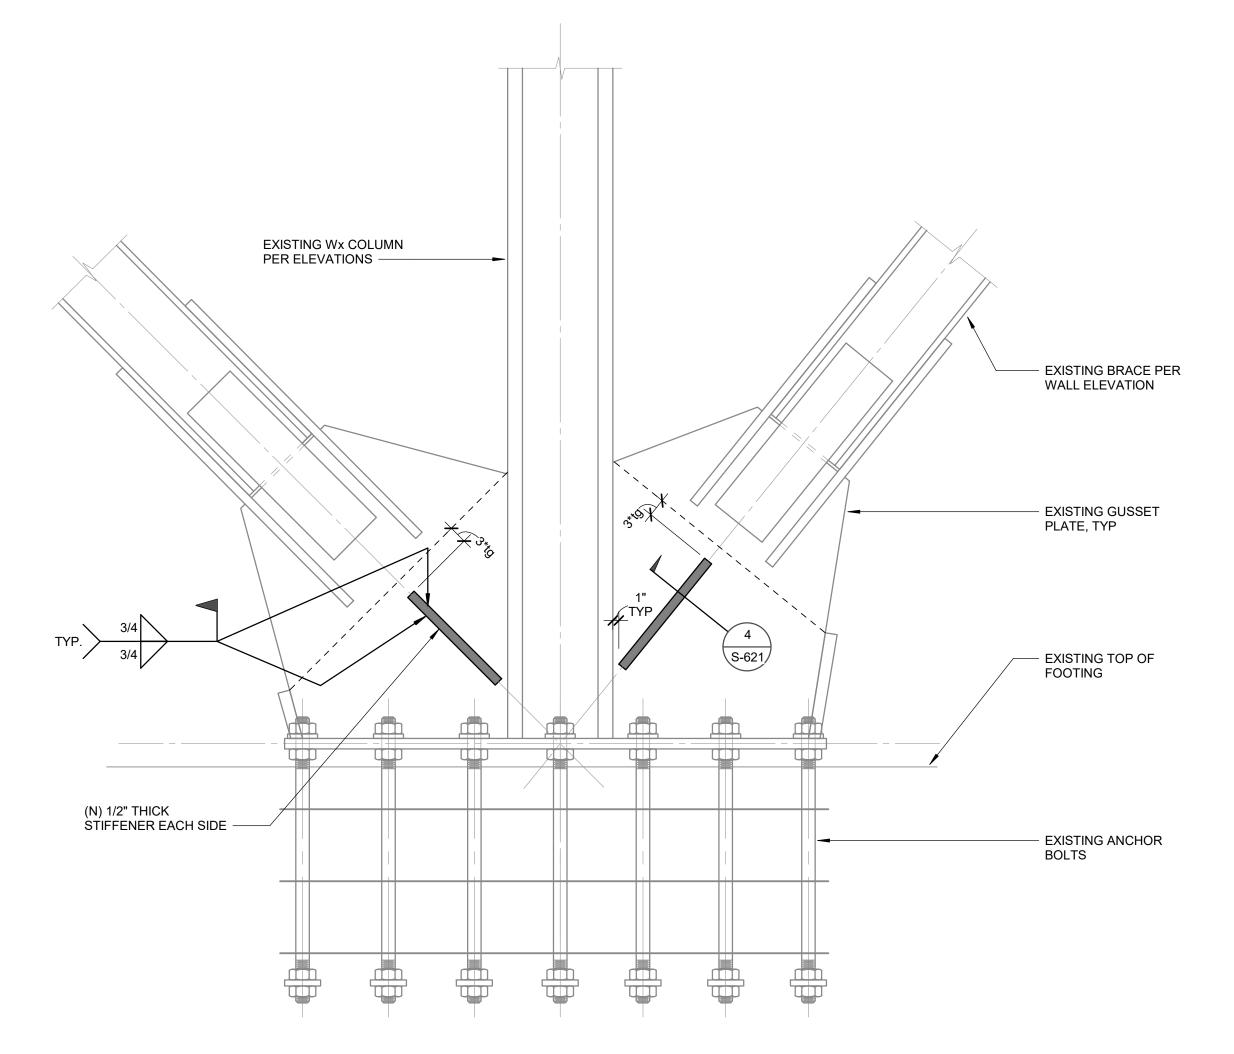
BRACE GUSSET PLATE STRENGTHENING



NOTE: FOR ALTERNATE GUSSET STRENGTHENING DETAIL, SEE S-625.

BRACE GUSSET PLATE STRENGTHENING

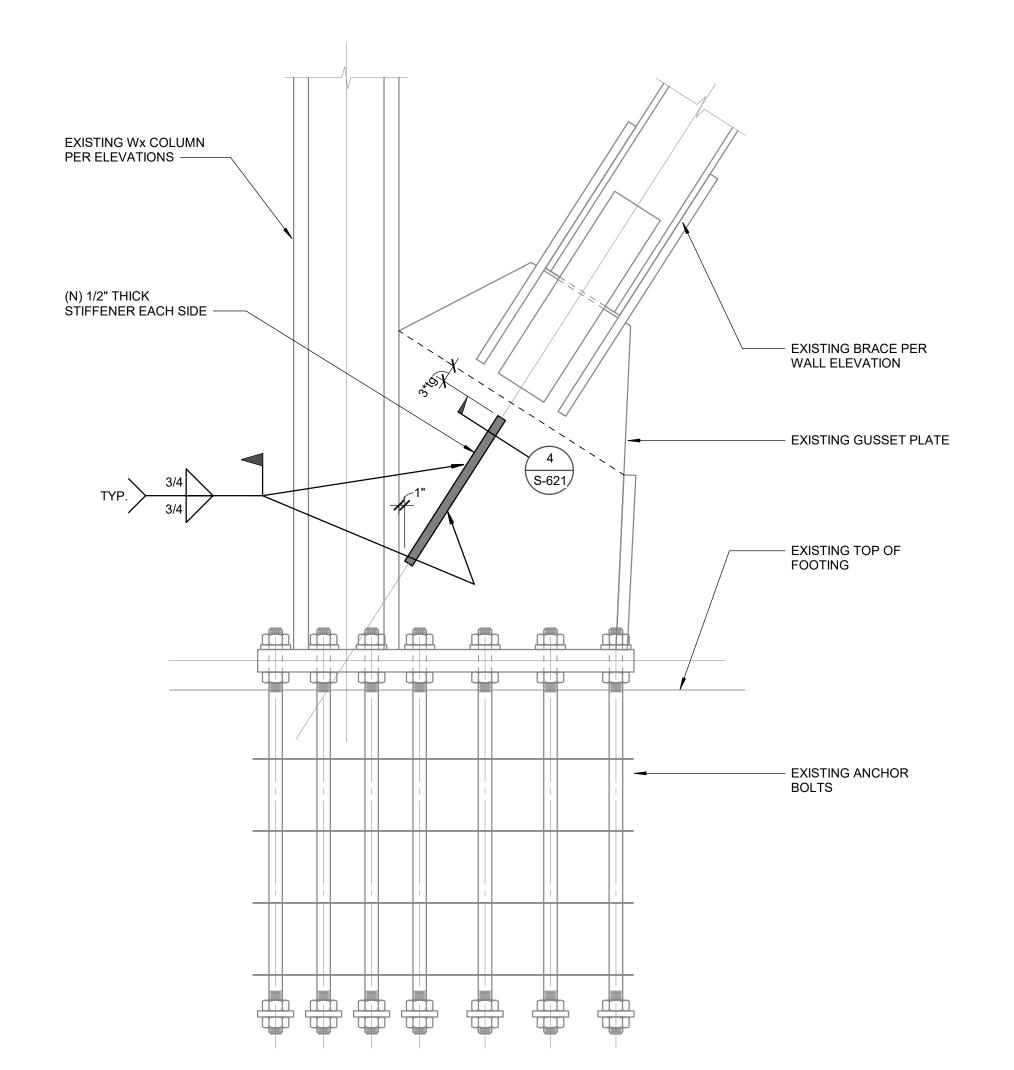SCALE: 3/4" = 1'-0"



NOTE: FOR ALTERNATE GUSSET STRENGTHENING DETAIL, SEE S-625.

BRACE GUSSET PLATE STRENGTHENING

SCALE: 3/4" = 1'-0"



CONSULTANTS

ARCHITECT STAMP CONSULTANT STAMP AGENCY APPROVAL

DESCRIPTION 100% DD SUBMITTAL PROGRESS SET 03/29/2019 THE ARCHITECT DOES NOT REPRESENT THAT THESE PLANS OR THE SPECIFICATIONS ARE

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PROJECT OWNER & TITLE

MT. SAN JACINTO COMMUNITY COLLEGE DISTRICT

TEMECULA VALLEY CAMPUS

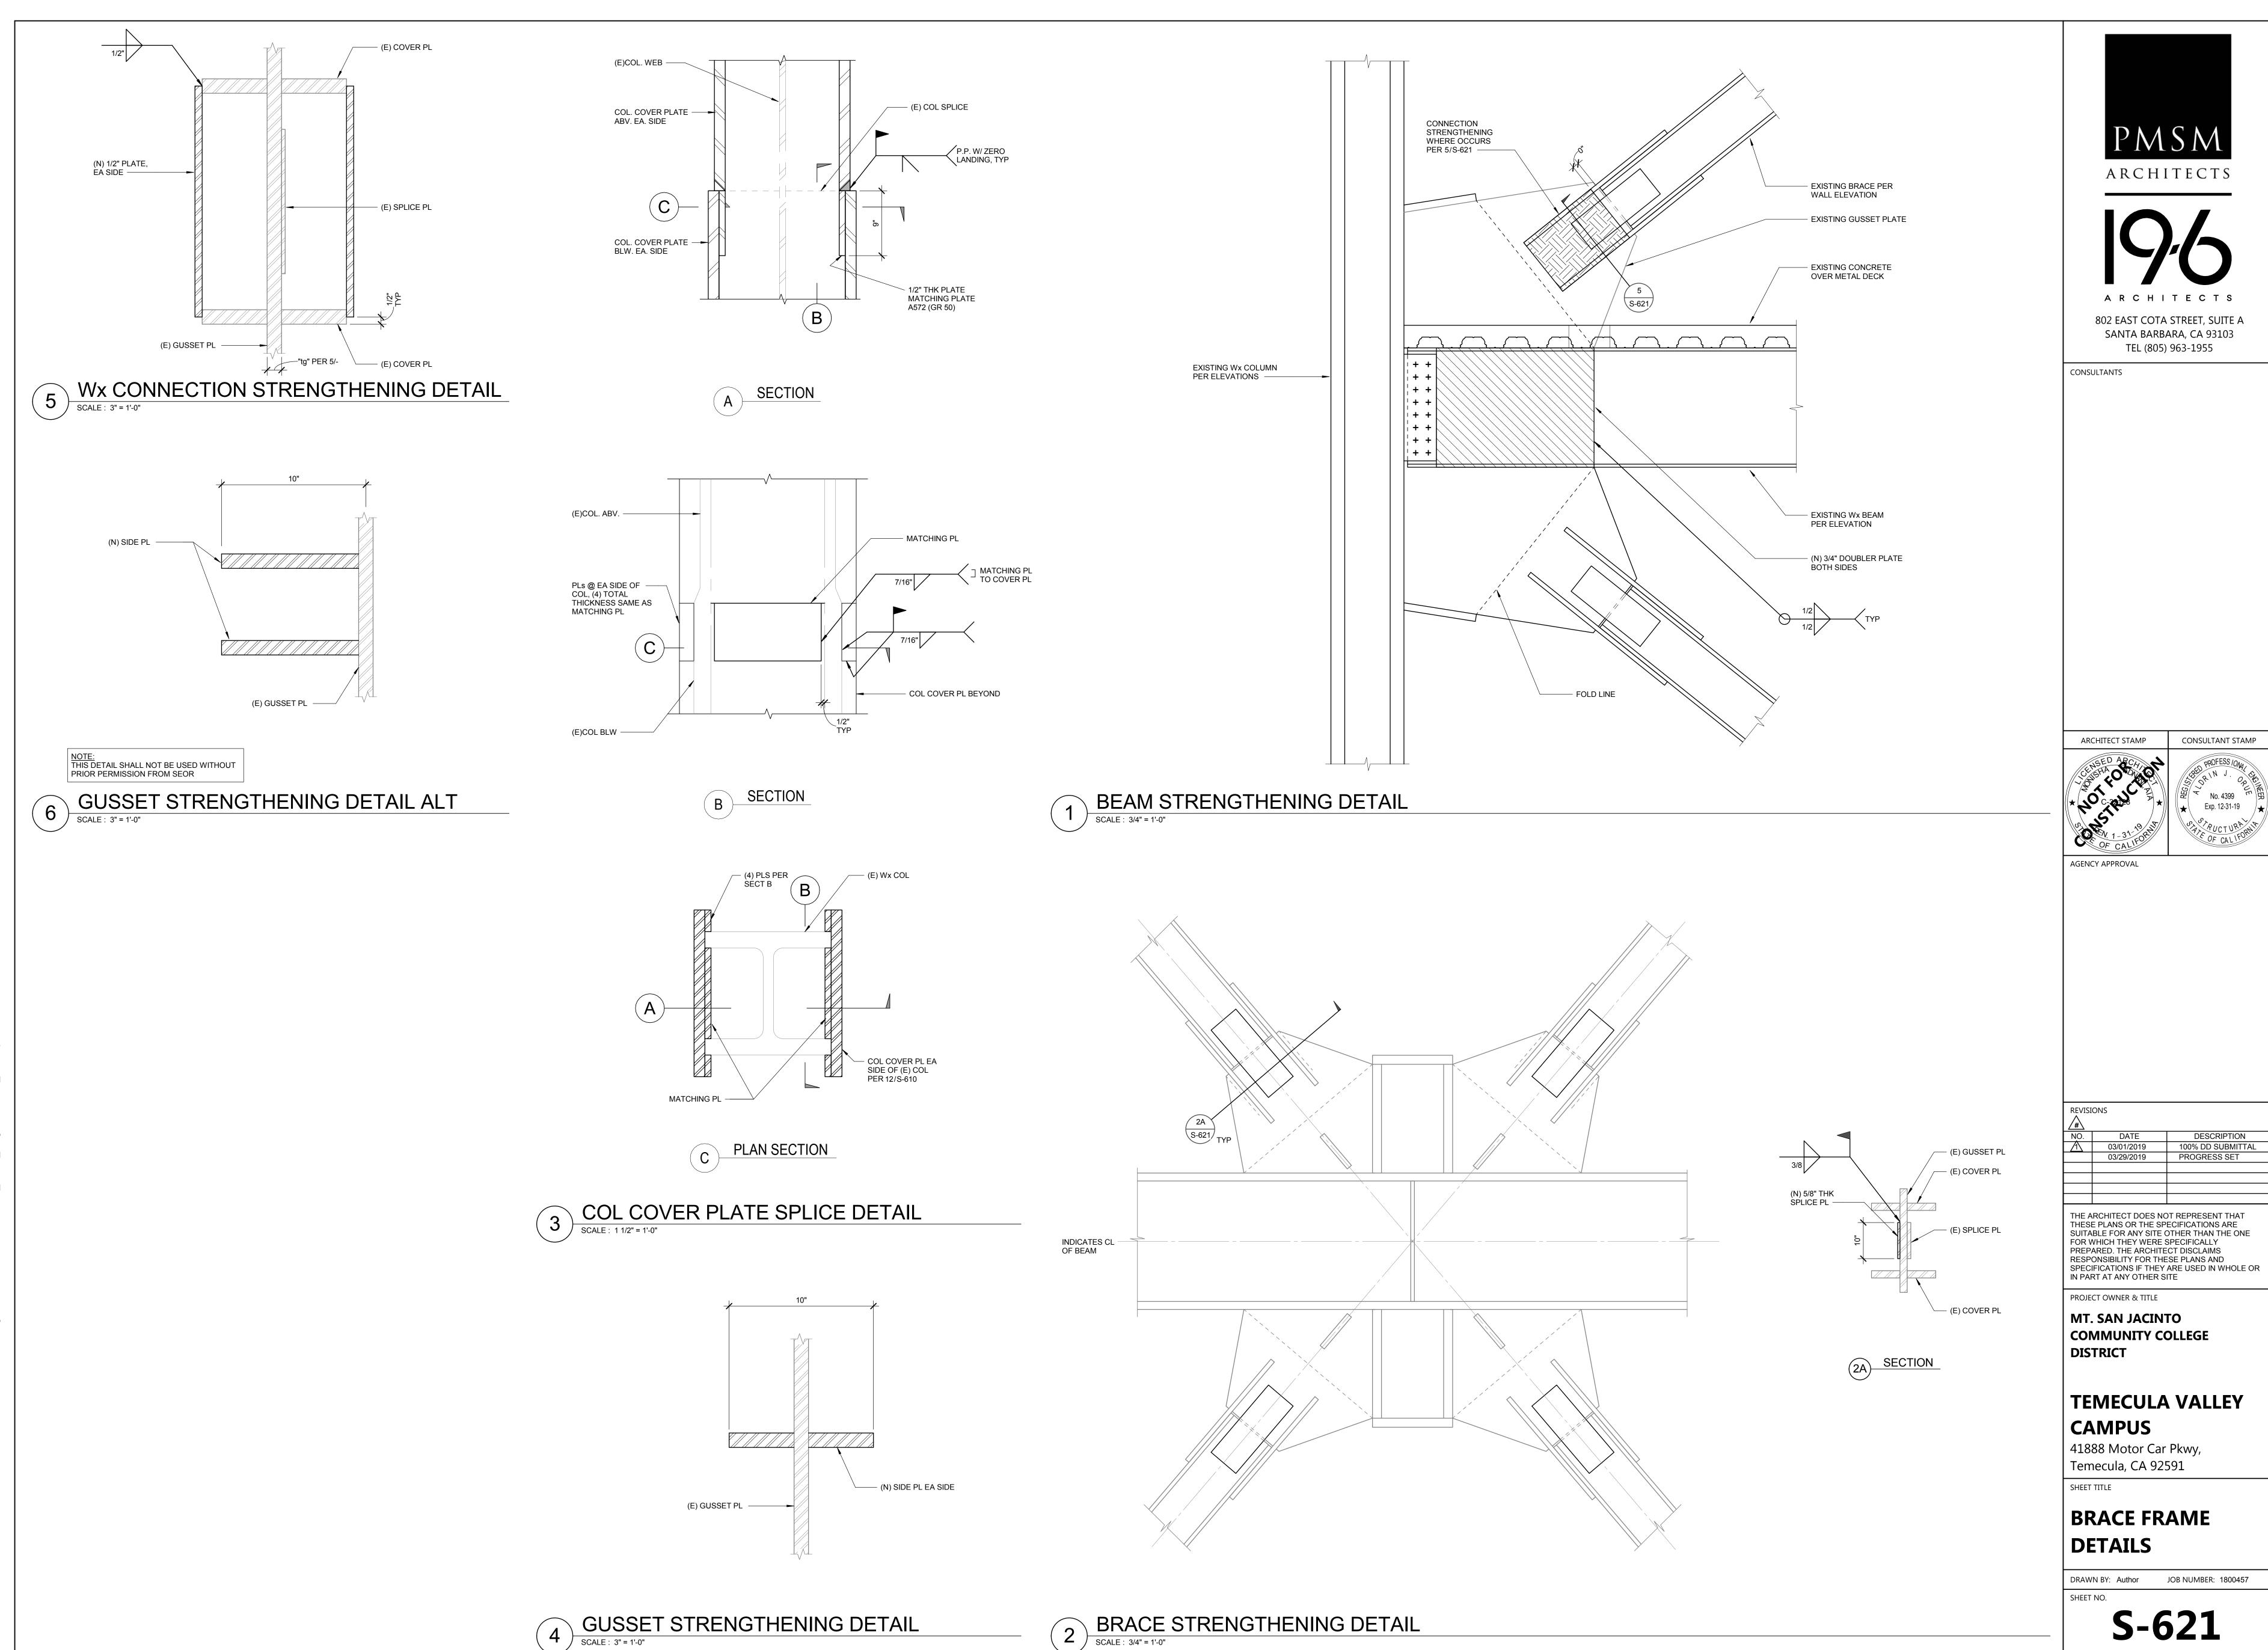
41888 Motor Car Pkwy, Temecula, CA 92591

SHEET TITLE

BRACE FRAME DETAILS

DRAWN BY: Author JOB NUMBER: 1800457


S-620 DATE: Issue Date



4 GUSSET STRENGTHENING DETAIL

SCALE: 3" = 1'-0"

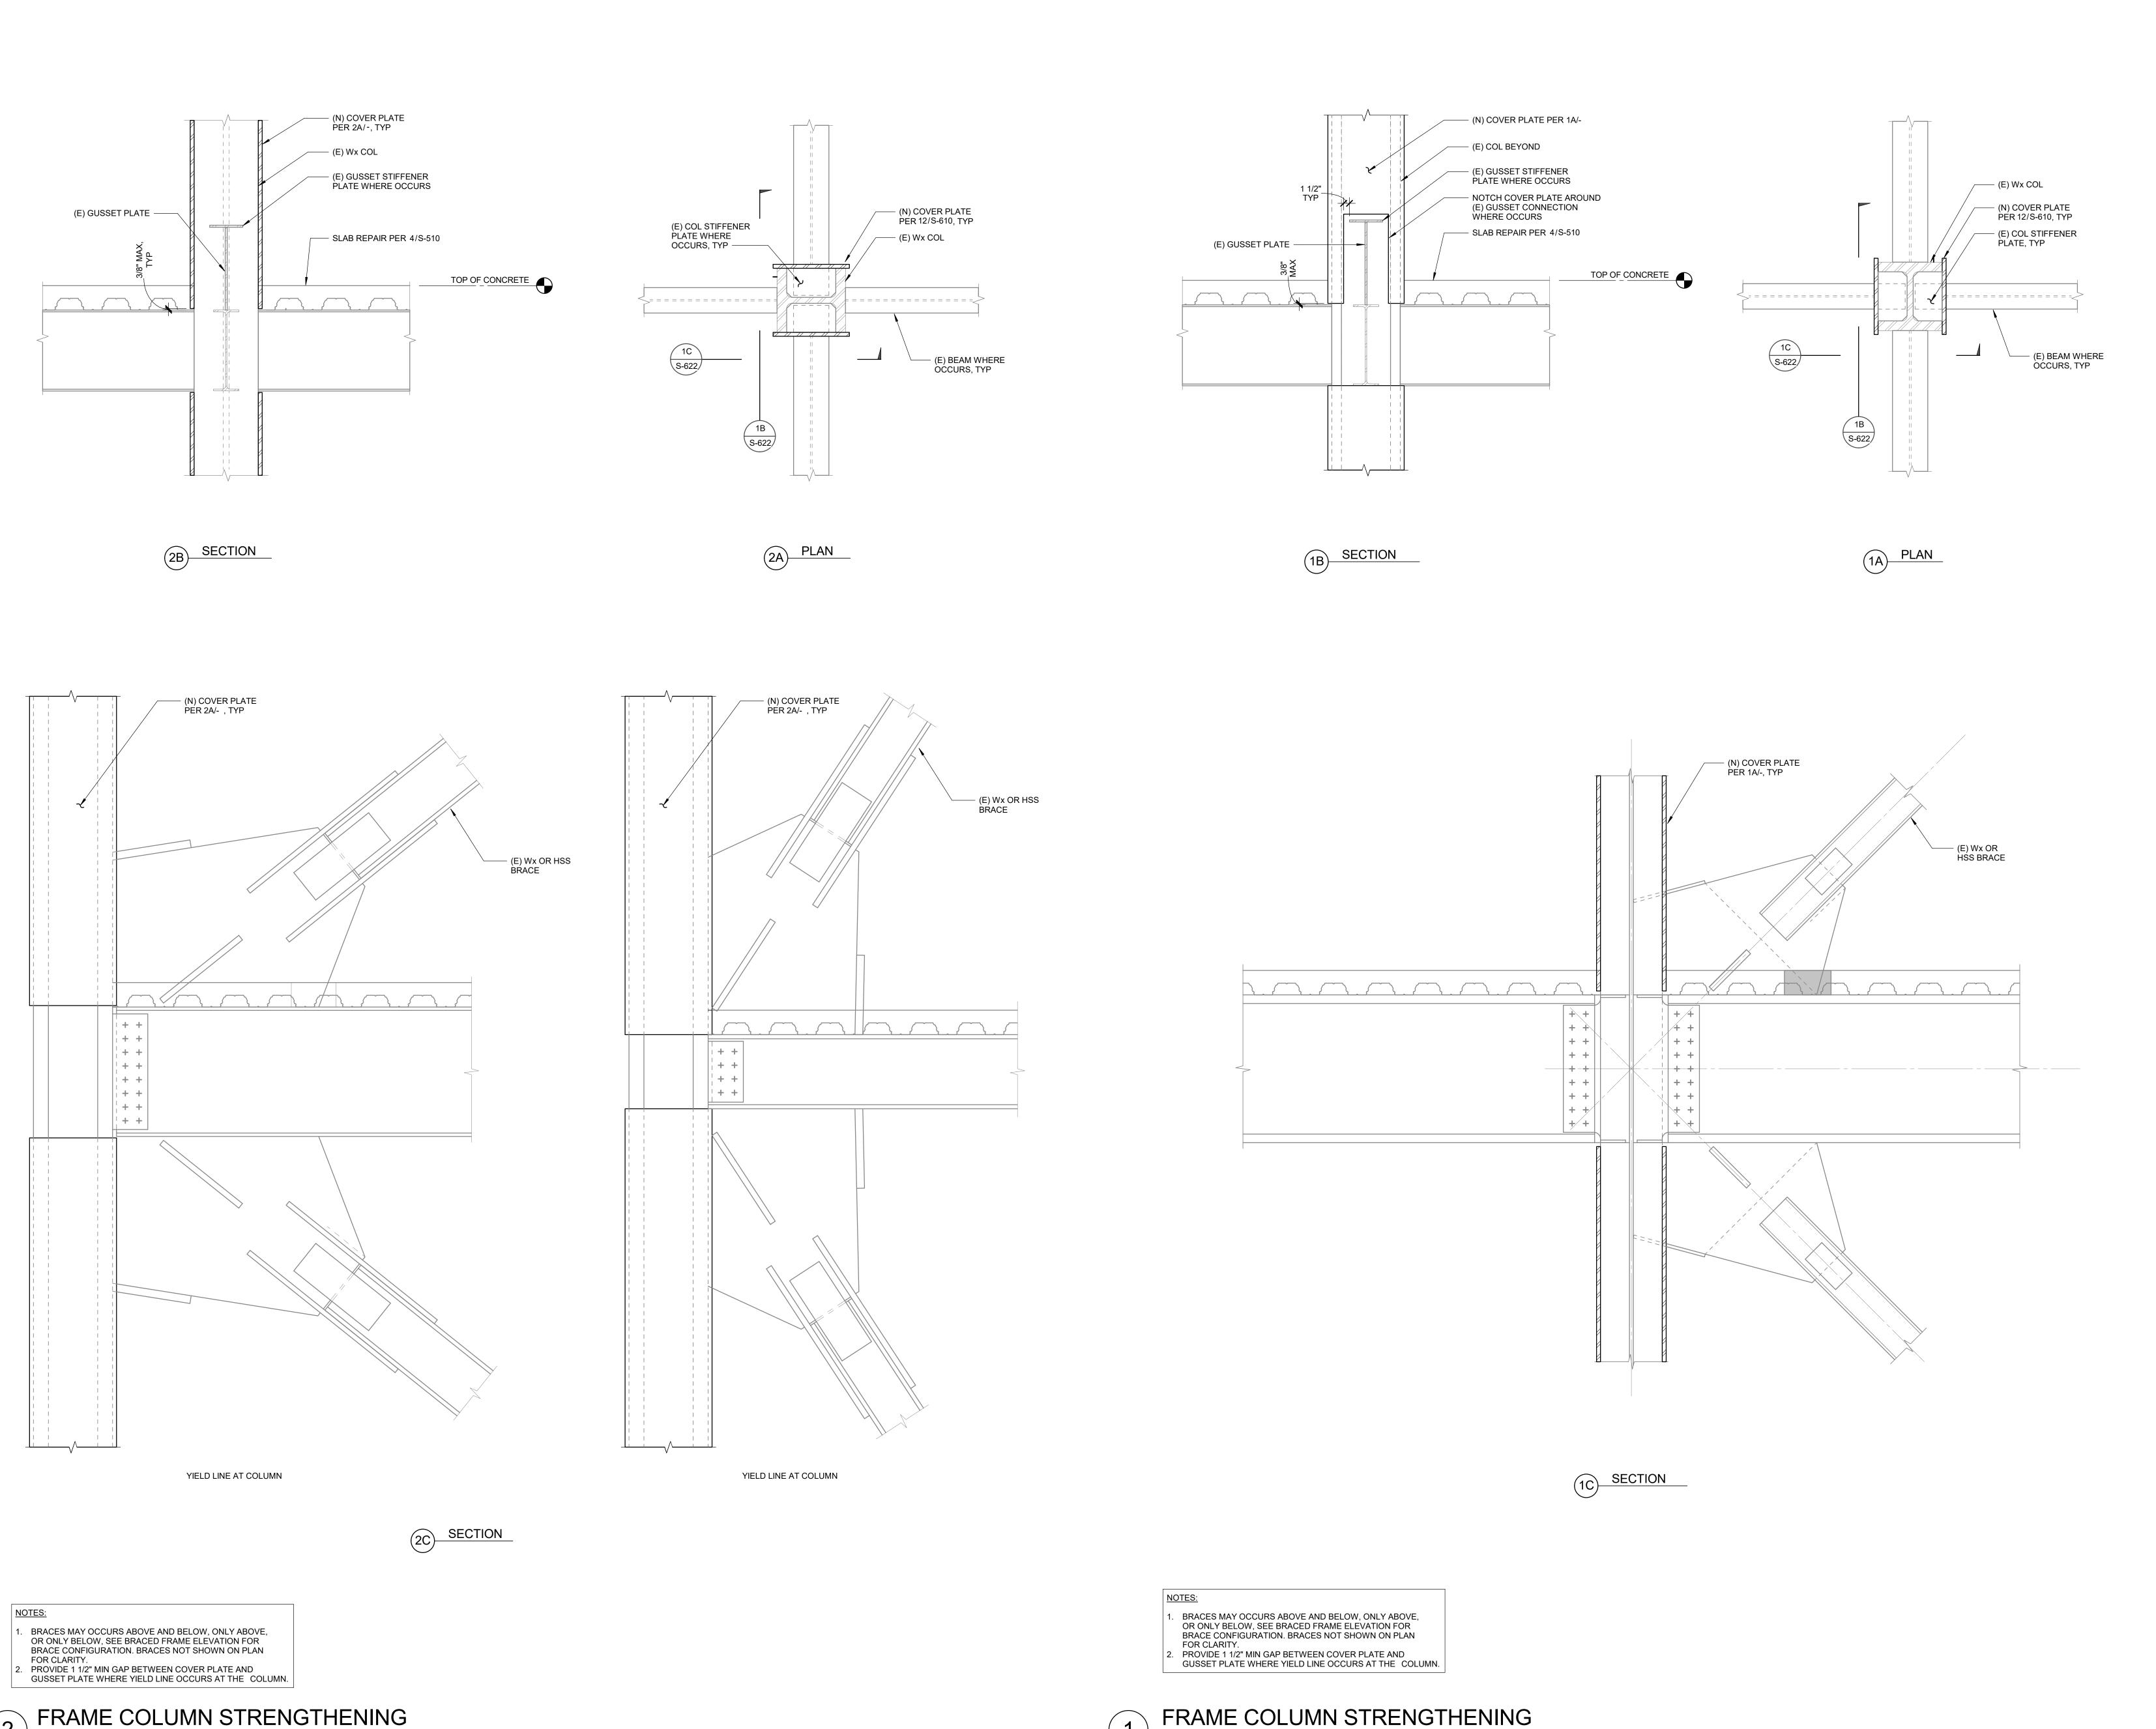S-621 DATE: Issue Date



ARCHITECTS ARCHITECTS 802 EAST COTA STREET, SUITE A SANTA BARBARA, CA 93103 TEL (805) 963-1955 CONSULTANTS

ARCHITECT STAMP CONSULTANT STAMP AGENCY APPROVAL

DESCRIPTION 03/01/2019 100% DD SUBMITTAL 03/29/2019 PROGRESS SET

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PROJECT OWNER & TITLE

MT. SAN JACINTO COMMUNITY COLLEGE DISTRICT

TEMECULA VALLEY **CAMPUS**

41888 Motor Car Pkwy, Temecula, CA 92591

SHEET TITLE

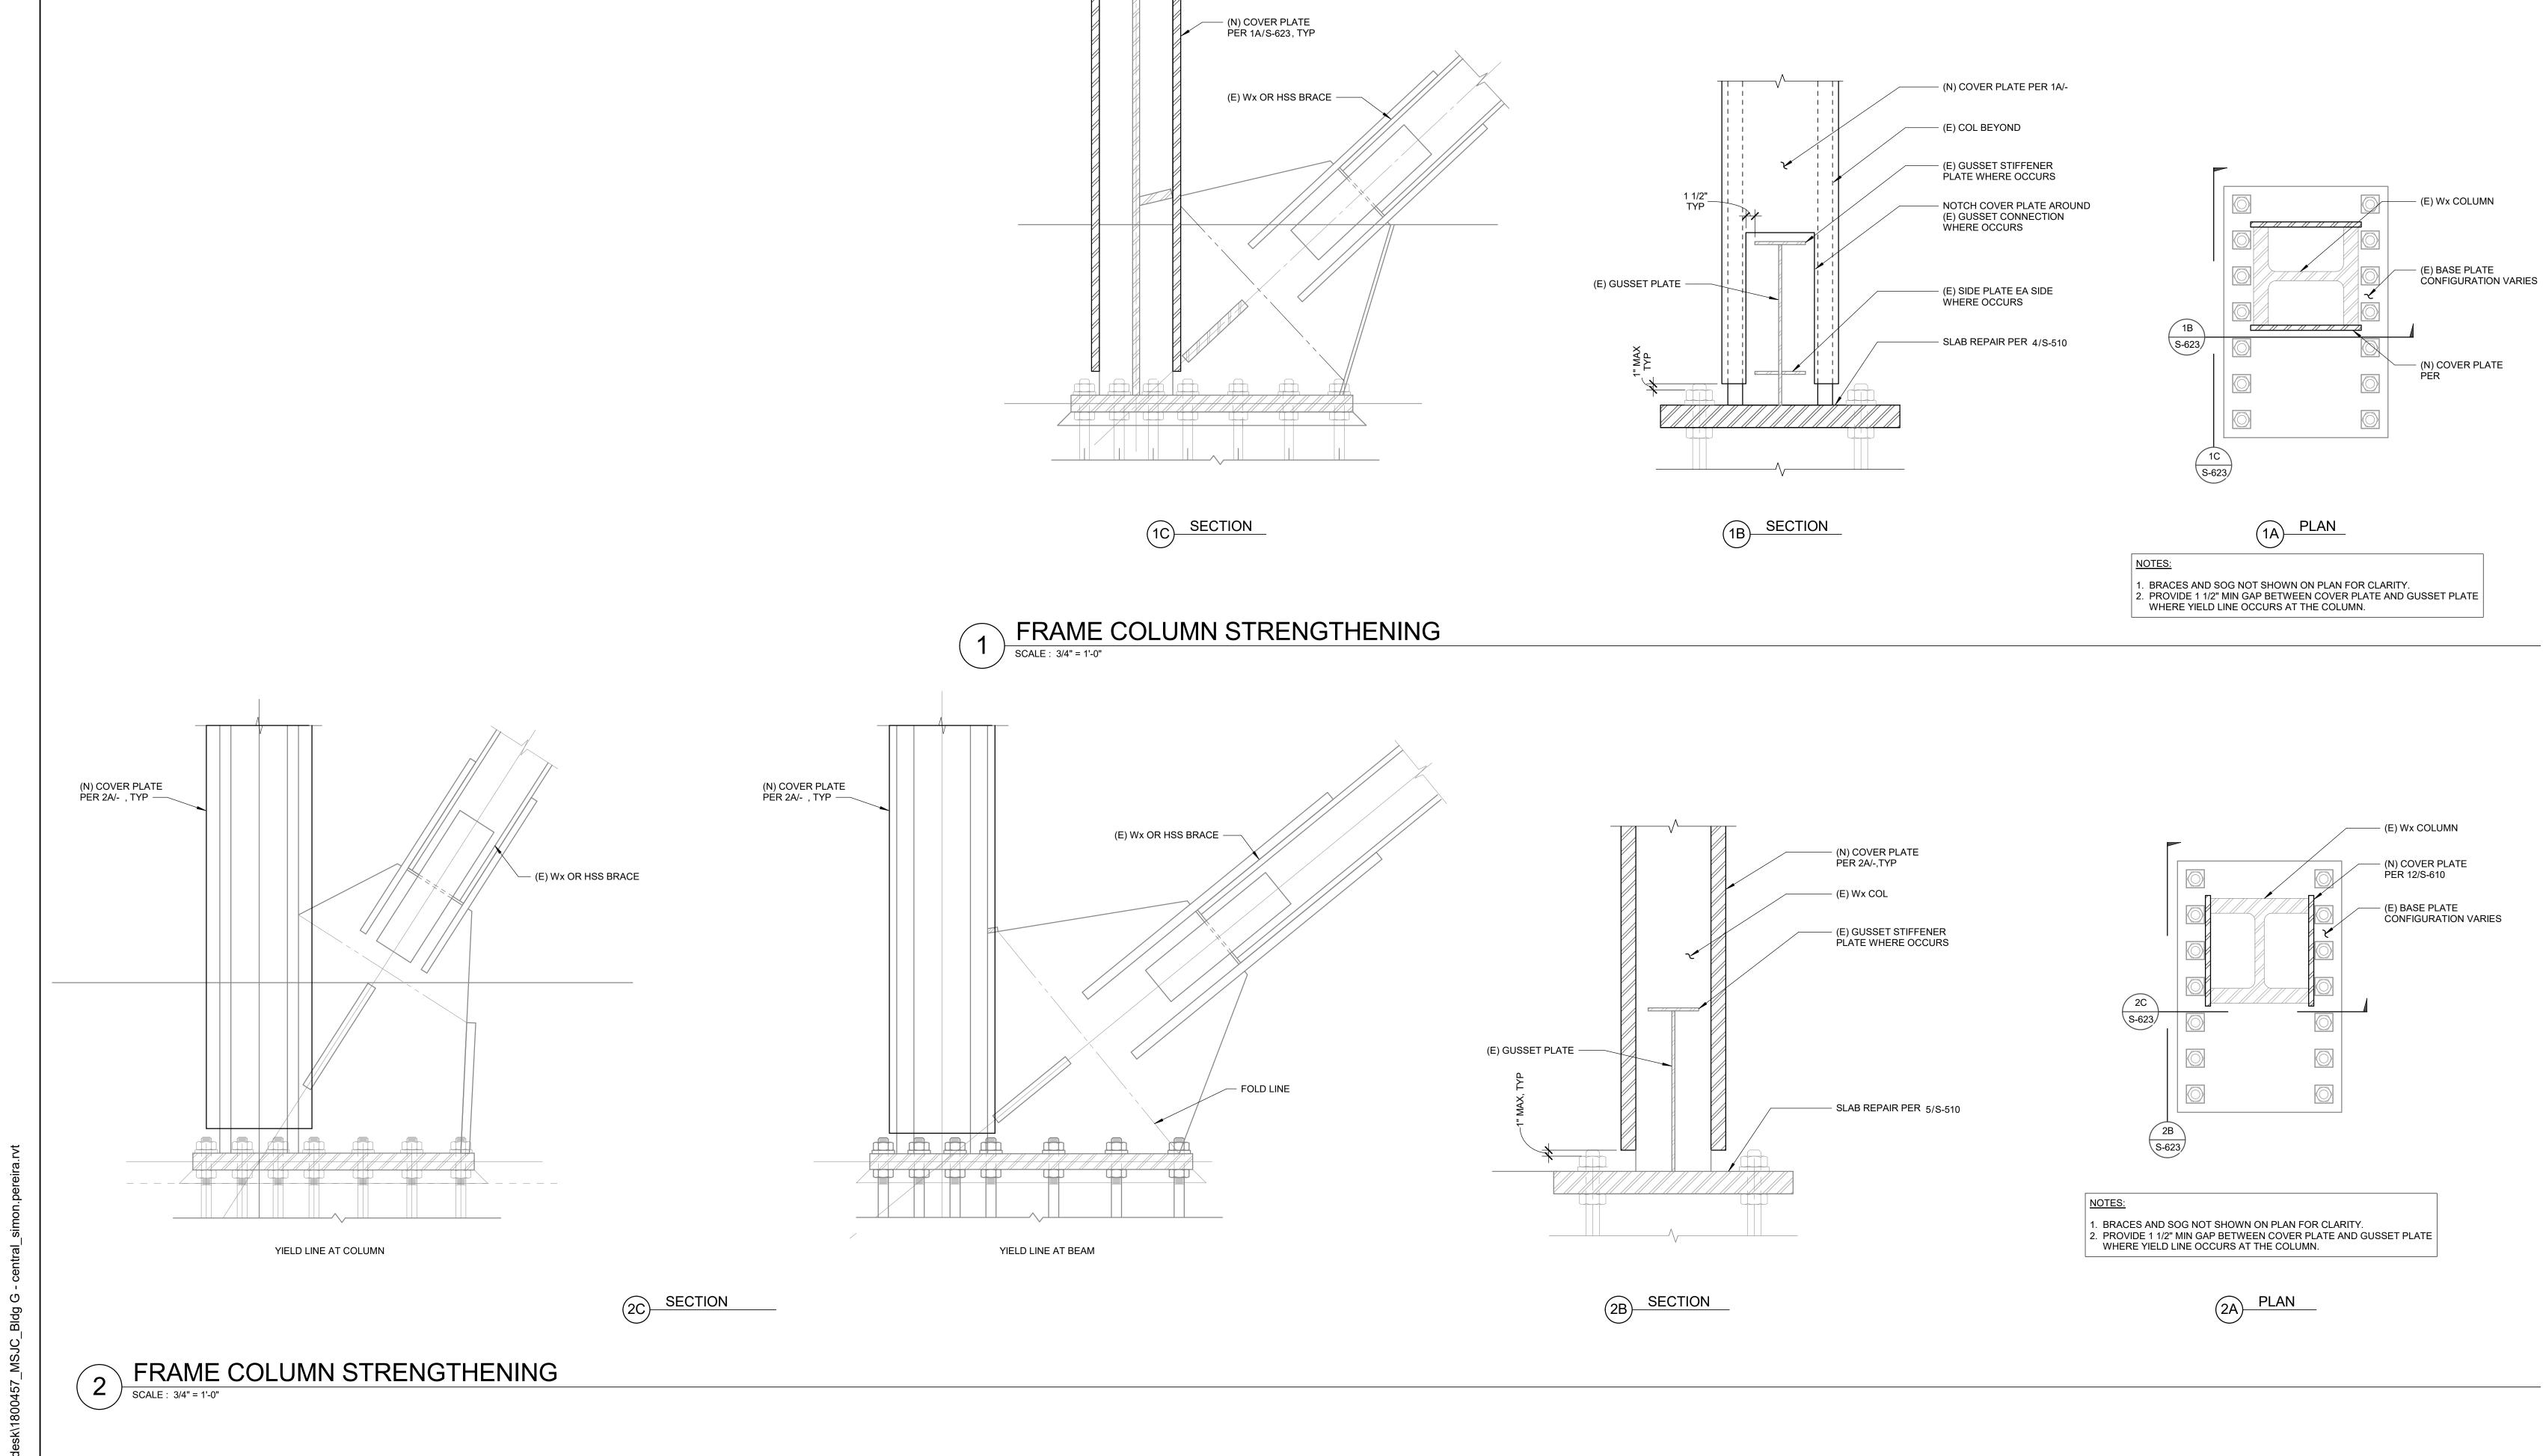
BRACE FRAME DETAILS

DRAWN BY: Author JOB NUMBER: 1800457 SHEET NO.

S-622 DATE: Issue Date

FRAME COLUMN STRENGTHENING 2 FRAME

SCALE: 3/4" = 1'-0"





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CHISED ARCHICAL CHISED	PROFESS /ONA/CERT OF CALLFORNIA
AGENCY APPROVAL	

REVISIO	ONS	
/#		
NO.	DATE	DESCRIPTION
1	03/01/2019	100% DD SUBMITTA
	03/29/2019	PROGRESS SET

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PROJECT OWNER & TITLE

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TEMECULA VALLEY CAMPUS

41888 Motor Car Pkwy, Temecula, CA 92591

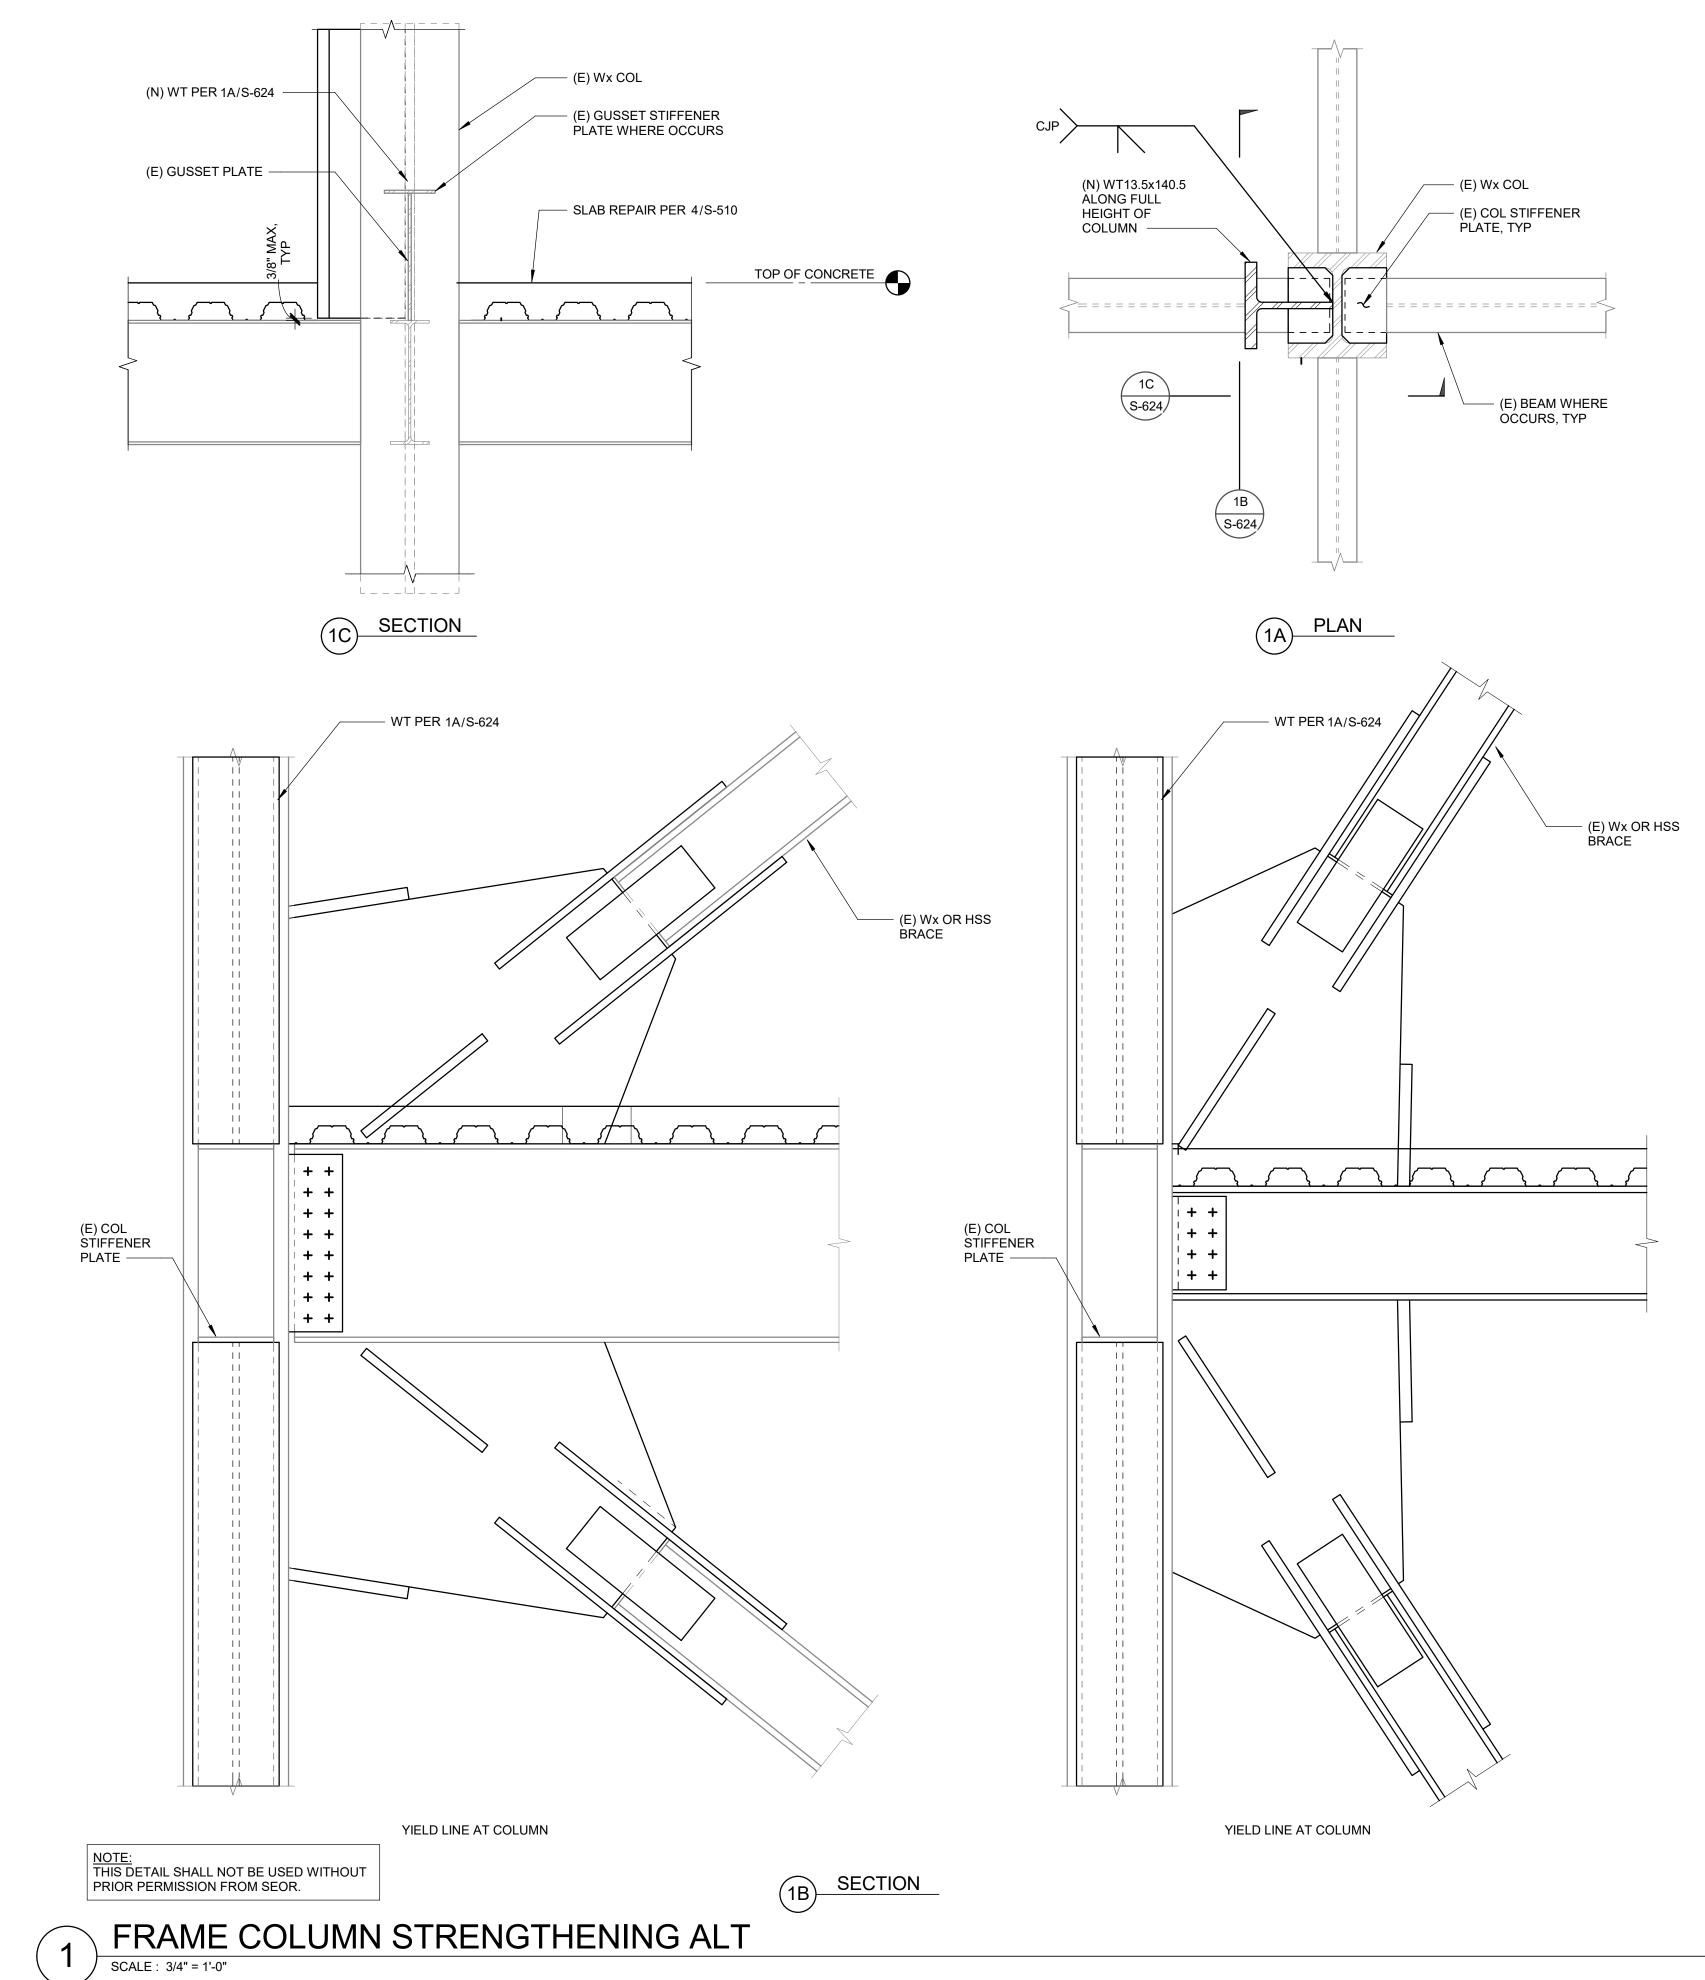
DATE: Issue Date

BRACE FRAME DETAILS

DRAWN BY: Author JOB NUMBER: 1800457 **S-623**







PMSM
ARCHITECTS

ARCHITECTS

ARCHITECTS

802 EAST COTA STREET, SUITE A
SANTA BARBARA, CA 93103
TEL (805) 963-1955

CONSULTANTS

ARCHITECT STAMP

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No. 4399

Exp. 12-31-19

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CONSULTANT STAMP

AGENCY APPROVAL

REVISIONS

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NO. DATE DESCRIPTION

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PROJECT OWNER & TITLE

MT. SAN JACINTO
COMMUNITY COLLEGE
DISTRICT

TEMECULA VALLEY CAMPUS

41888 Motor Car Pkwy, Temecula, CA 92591

SHEET TITLE

BRACE FRAME DETAILS

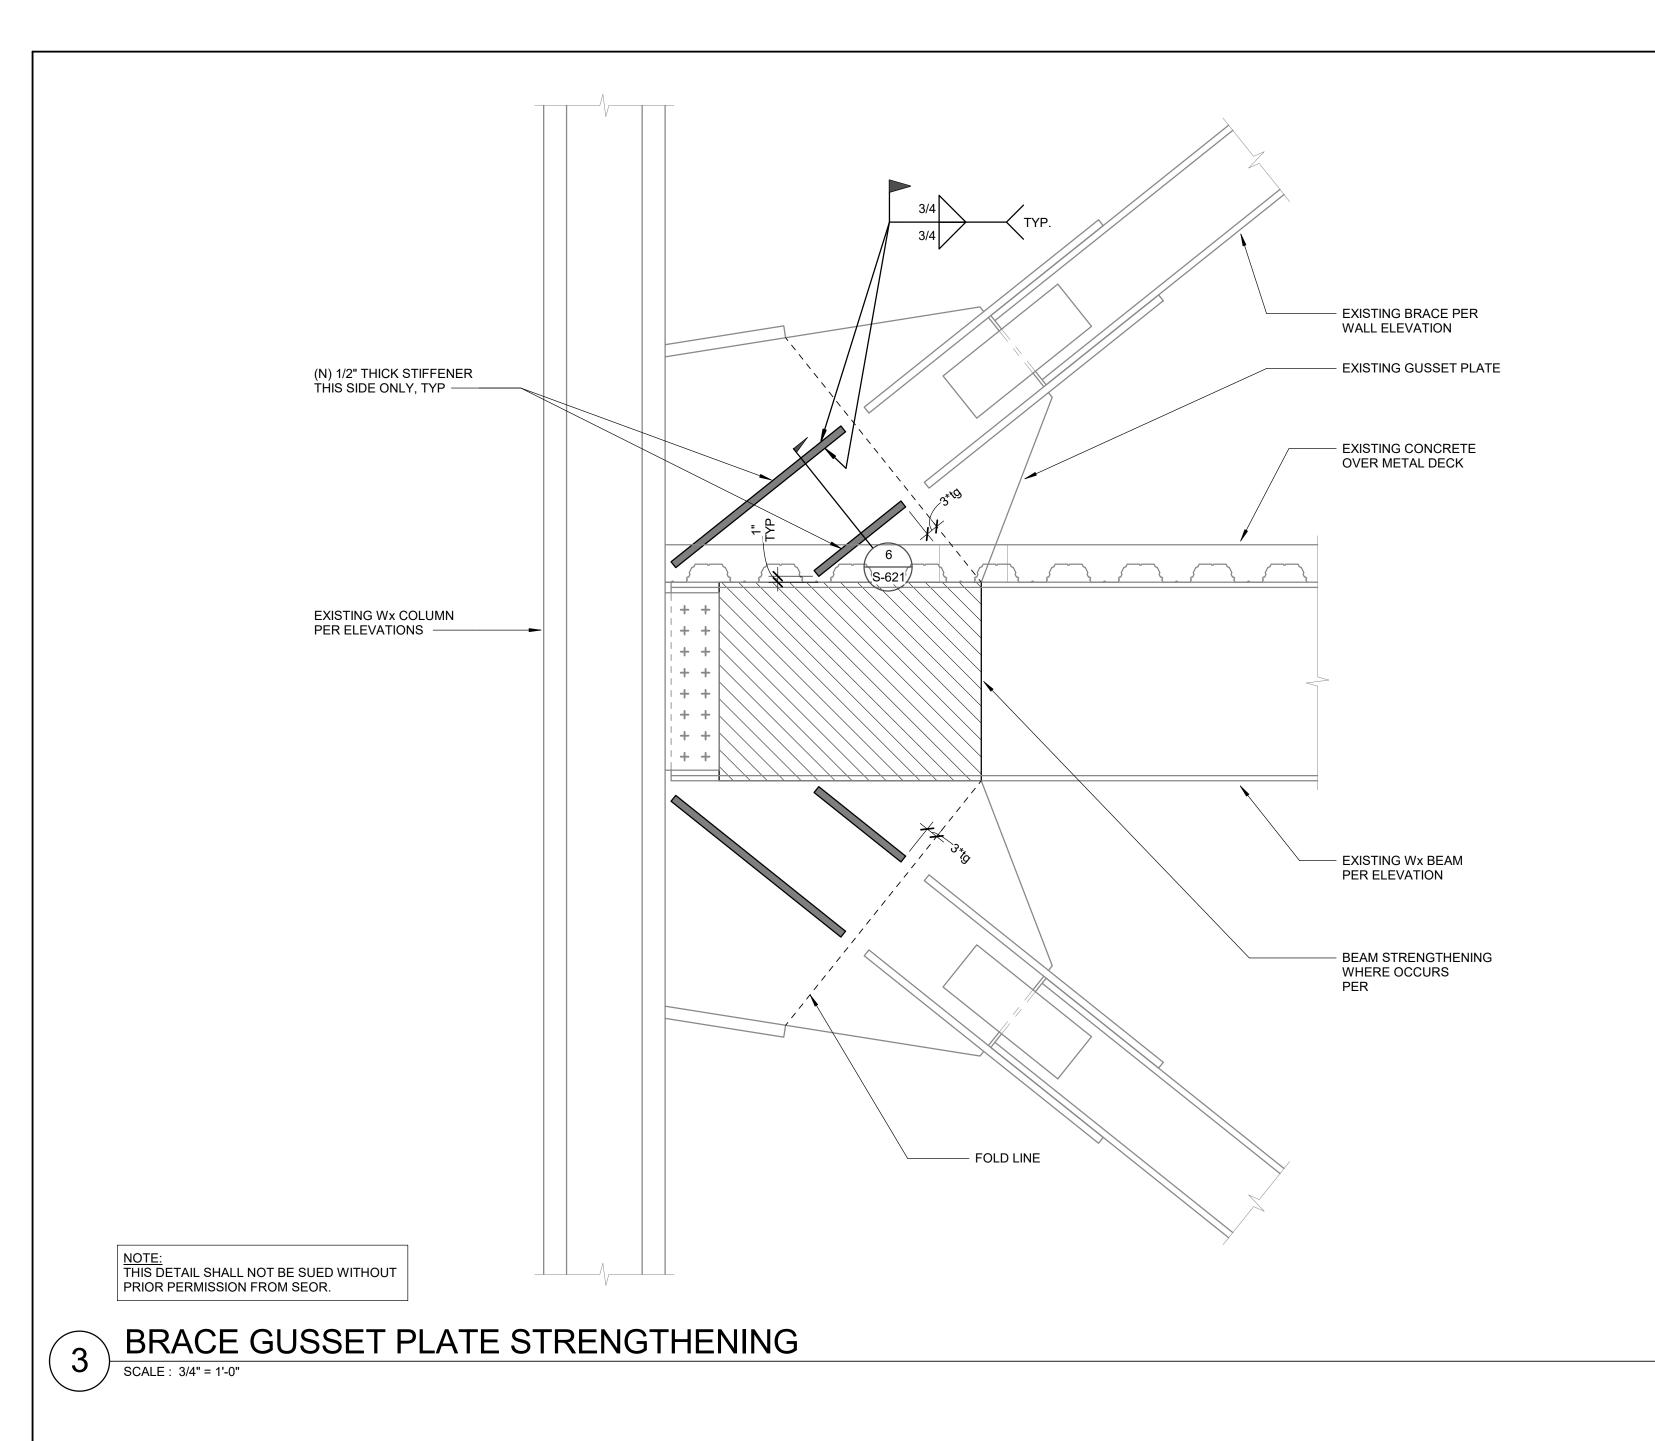
DRAWN BY: Author JOB NUMBER: 1800457
SHEET NO.

SHEET NO.

SHEET NO.

DATE: Issue Date

Project Statu



- (N) 1/2" THICK STIFFENER THIS SIDE ONLY, TYP - EXISTING BRACE PER WALL ELEVATION - EXISTING GUSSET PLATE - EXISTING CONCRETE OVER METAL DECK - EXISTING Wx BEAM PER ELEVATION (N) 1/2" THICK STIFFENER THIS SIDE ONLY, TYP — - EXISTING GUSSET

BRACE GUSSET PLATE STRENGTHENING

NOTE:
THIS DETAIL SHALL NOT BE SUED WITHOUT PRIOR PERMISSION FROM SEOR.

EXISTING Wx COLUMN PER ELEVATIONS ——— EXISTING BRACE PER WALL ELEVATION — EXISTING GUSSET PLATE, TYP EXISTING TOP OF FOOTING (N) 1/2" THICK STIFFENER THIS SIDE ONLY, TYP EXISTING ANCHOR BOLTS

NOTE:
THIS DETAIL SHALL NOT BE SUED WITHOUT PRIOR PERMISSION FROM SEOR.

2 BRACE GUSSET PLATE STRENGTHENING

SCALE: 3/4" = 1'-0"

EXISTING Wx COLUMN PER ELEVATIONS — (N) 1/2" THICK STIFFENER THIS SIDE - EXISTING BRACE PER WALL ELEVATION - EXISTING GUSSET PLATE - EXISTING TOP OF FOOTING EXISTING ANCHOR BOLTS

COMMUNITY COLLEGE TEMECULA VALLEY **CAMPUS** 41888 Motor Car Pkwy, Temecula, CA 92591

DESCRIPTION

100% DD SUBMITTAL PROGRESS SET

ARCHITECTS

802 EAST COTA STREET, SUITE A SANTA BARBARA, CA 93103 TEL (805) 963-1955

CONSULTANTS

ARCHITECT STAMP

AGENCY APPROVAL

CONSULTANT STAMP

BRACE FRAME DETAILS

03/29/2019

PROJECT OWNER & TITLE

DISTRICT

SHEET TITLE

MT. SAN JACINTO

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DRAWN BY: Author JOB NUMBER: 1800457

S-625 DATE: Issue Date

NOTE:
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BRACE GUSSET PLATE STRENGTHENING

SCALE: 3/4" = 1'-0"

NOTE:
1. SEE DETAIL 1/- FOR METAL STUD PROPERTIES.
2. USE L 1/2"x1/2"x 16 GA x 0'-3 1/2" @ 4" STUD WALLS.

TYPICAL METAL STUD FRAMING

L 1/2x1/2x16GAx0'-4"

— JAMB STUD

HEADER & JAMB DETAIL FOR 12'-0" MAX OPENING

(2) #10 SMS @ — EA STUD

L 1/2x1/2x16GAx0'-4" W/ (3) #10 SMS EA LEG

T&B, SEE NOTE #2

SILL & JAMB DETAIL FOR 12'-0" MAX OPENING


SECTION

NOTE:
1. SEE DETAIL 1/- FOR METAL STUD PROPERTIES.
2. USE L 1/2"x1/2"x 16 GA x 0'-3 1/2" @ 4" STUD WALLS.

W/ (3) #10 SMS EA LEG T&B, SEE NOTE #2

#10 SMS -EA SIDE



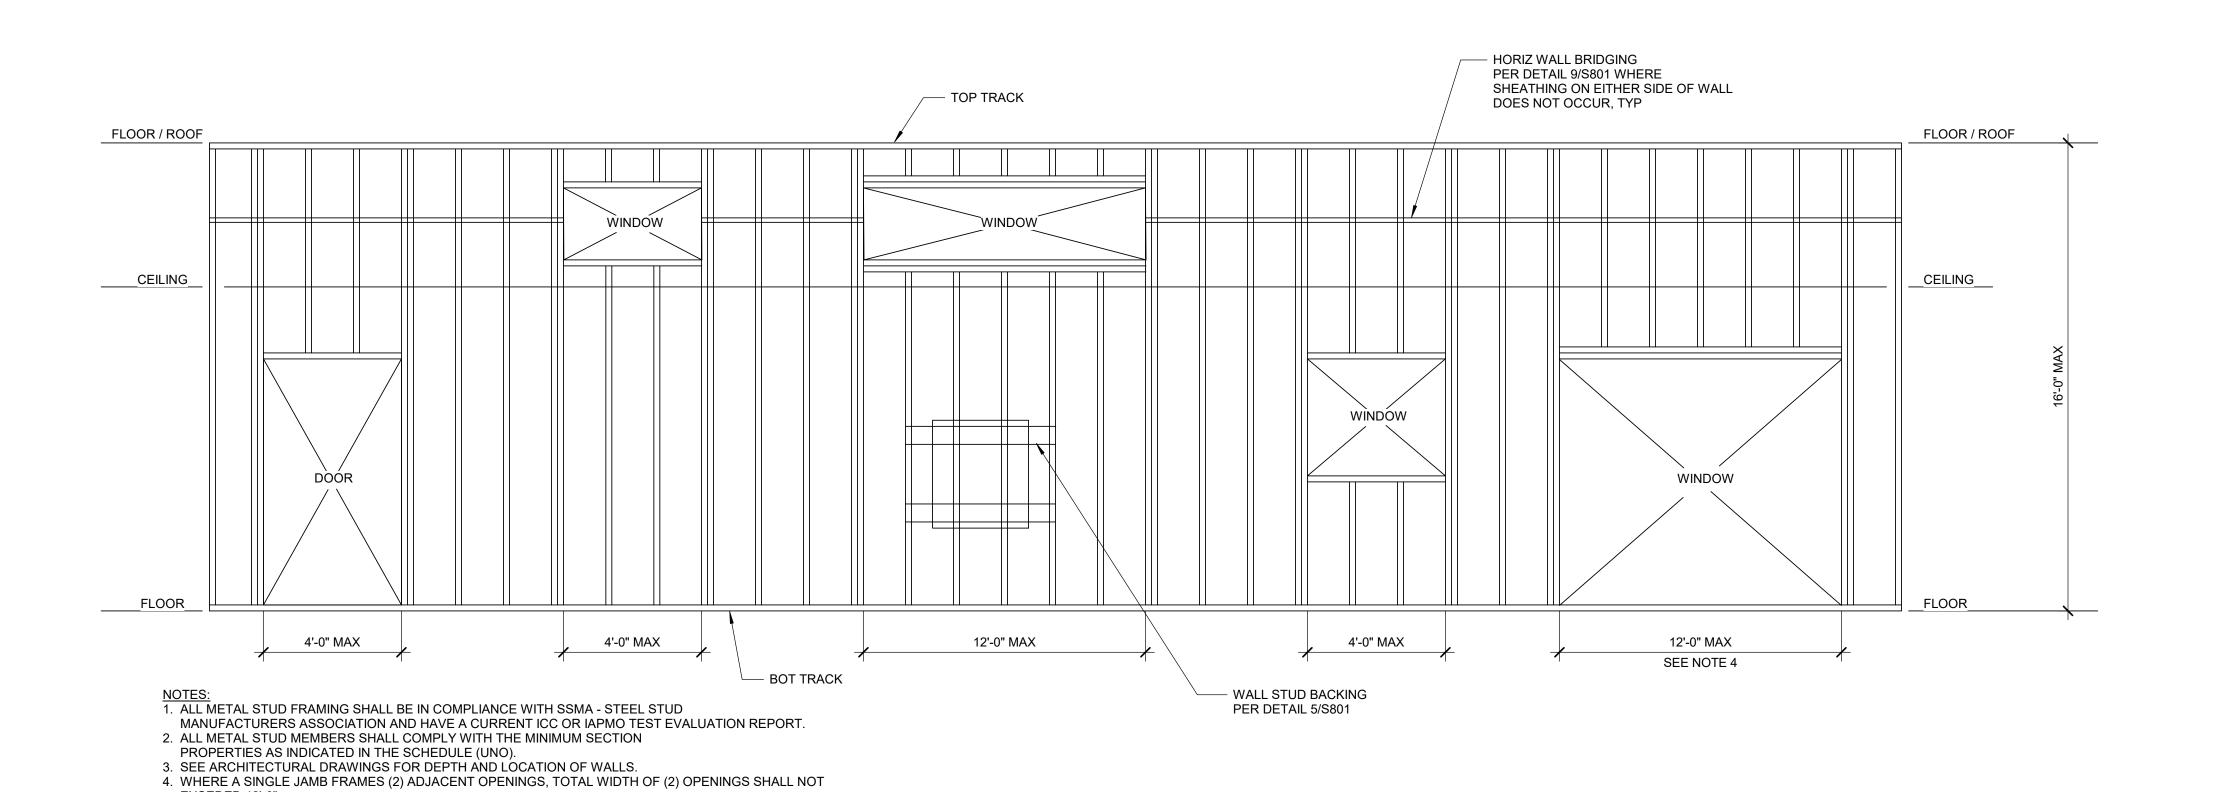

A ELEVATION

- (8) #10 SMS @

JAMB EA SIDE

CUT FLANGES OF HORIZ
 C-STUD AND ATTACH WEB

TO MULTIPLE STUDS AT

- BOX STUD JAMB

TYP STUD

ÈÁ STUD

BOT TRACK

- 6x16GA C-STUD EA SIDE

— TRACK T&B 1 1/2" FLANGE W/ #10 SMS @ 6" OC EA SIDE

— TRACK T&B 1 1/2" FLANGE W/ #10 SMS @ 6" OC EA SIDE


— TOP TRACK


- C-STUD SEE SCHED


SECTION

- (2) #10 SMS @


TYPIC	AL WALL STUD PROPERTIES	SSMA DESIGNATION	DEPTH	THICKNESS	FLANGE WIDTH	GROSS AREA (in2)	EFFECTIVE Sxx (in3)	EFFECT lxx (in-
6" W	VALL STUDS @ 16"OC MAX					,		
L .	C-STUD	600S162-54	6"	16 GA	1 5/8"	0.556	0.953	2.86
	C-STUD PARAPET > 5'-0"	600S200-97	6"	12 GA	2"	1.067	1.87	5.61
TYP EXTERIOR WALL	TOP TRACK	600T150-54	6"	16 GA	1 1/2"	0.509	0.609	2.400
ERIOF	BOTTOM TRACK	600T150-54	6"	16 GA	1 1/2"	0.509	0.609	2.400
P EXT	DEFLECTION TRACK	600T200-54	6"	16 GA	2"	0.565	0.759	2.759
և	NESTED TRACK	600T250-54	6"	16 GA	2 1/2"	0.622	0.717	2.641
4" W	/ALL STUDS @ 16" OC MAX							
-	C-STUD	400S162-54	4"	16 GA	1 5/8"	0.443	0.526	1.098
TYP INTERIOR WALL (MAX HEIGHT = 14' -	TOP TRACK	400T150-43	4"	18 GA	1 1/2"	0.315	0.293	0.719
ERIOF	HANGING TOP TRACK	400T-150-54	4"	16 GA	1 1/2"	0.396	0.374	0.918
YP INT	BOTTOM TRACK	400T150-43	4"	18 GA	1 1/2"	0.315	0.293	0.719
Ţ	SLIP TRACK	-	4"	16 GA	2 1/2"	SEE 8/S8.01		•
6" W	/ALL STUDS @ 16" OC MAX							
. ("(C-STUD	600S200-68	6"	14 GA	2"	0.764	1.317	4.101
ORIENTATION HALL STAGE WALL (MAX HEIGHT = 30' - 0")	TOP TRACK	600T250-68	6"	14 GA	2 1/2"	0.783	1.017	3.871
ATION SE W# GHT =	BOTTOM TRACK	600T150-68	6"	14 GA	1 1/2"	0.783	0.641	3.162
STAC X HEI	DEFLECTION TRACK	600T200-68	6"	14 GA	2"	0.712	0.973	3.540
O (MA	NESTED TRACK	600T250-68	6"	14 GA	2 1/2"	0.783	1.017	3.871

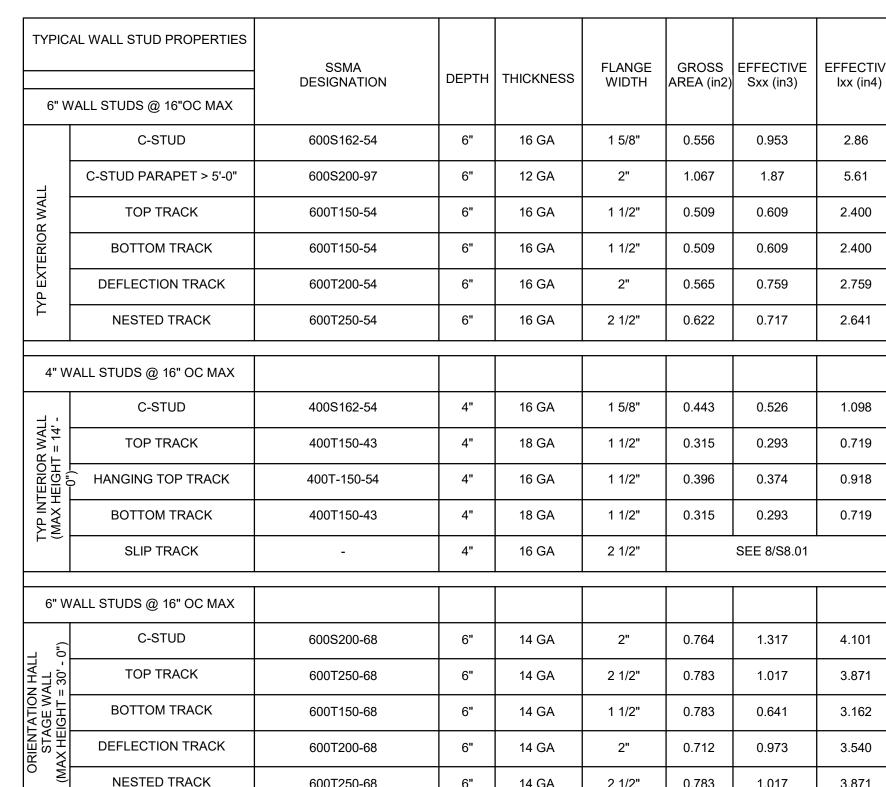

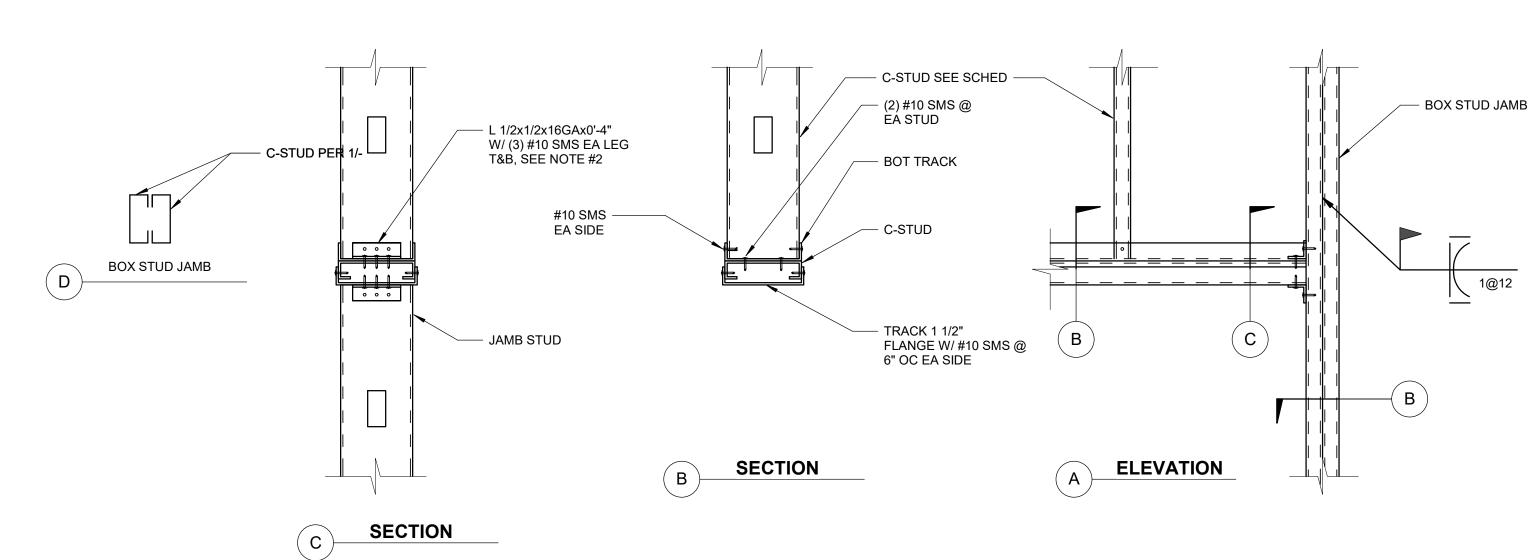

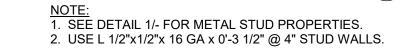



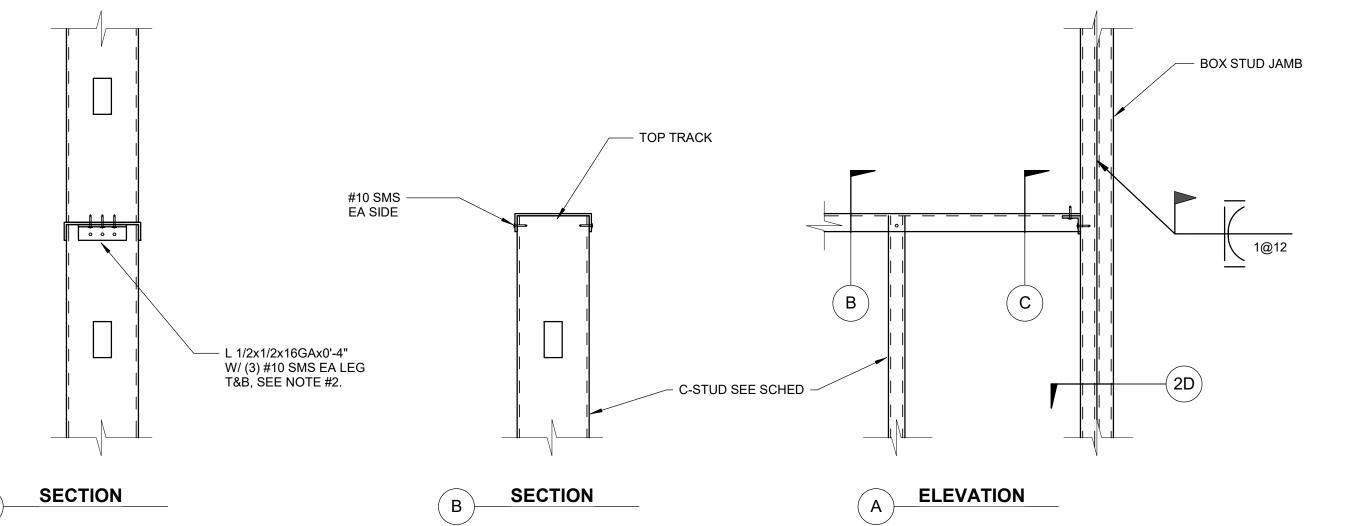

NOTE:
1. SEE DETAIL 1/- FOR METAL STUD PROPERTIES.
2. USE L 1/2"x1/2"x 16 GA x 0'-3 1/2" @ 4" STUD WALLS.

3 SILL & JAMB DETAIL FOR 4'-0" MAX OPENING
SCALE: 1 1/2" = 1'-0"

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UD JAMB	PROJECT OWNER & TITLE
	MT. SAN JACINTO COMMUNITY COLLEGE DISTRICT
1@12	TEMECULA VALLEY
	CAMPUS
	41888 Motor Car Pkwy,
	Temecula, CA 92591
	SHEET TITLE

TYPICAL METAL
STUD WALL DETAIL

ARCHITECTS

ARCHITECTS

802 EAST COTA STREET, SUITE A SANTA BARBARA, CA 93103 TEL (805) 963-1955

CONSULTANT STAMP

DESCRIPTION 100% DD SUBMITTAL

PROGRESS SET

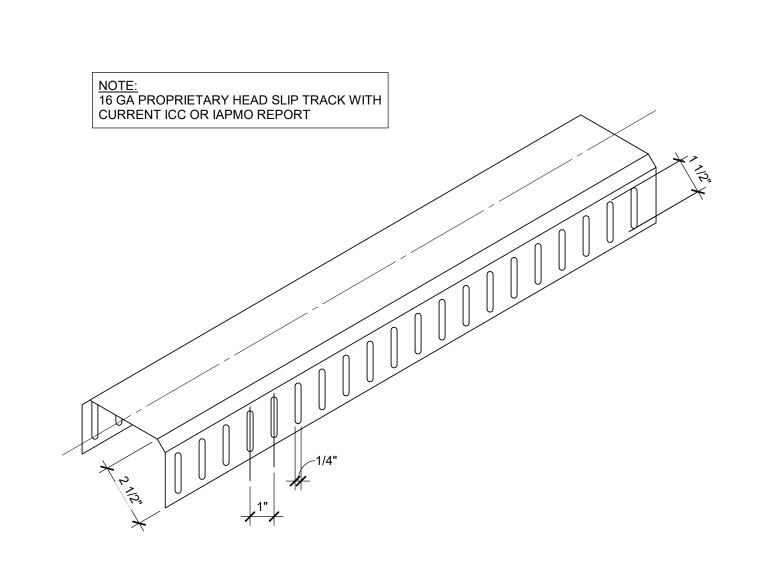
CONSULTANTS

AGENCY APPROVAL

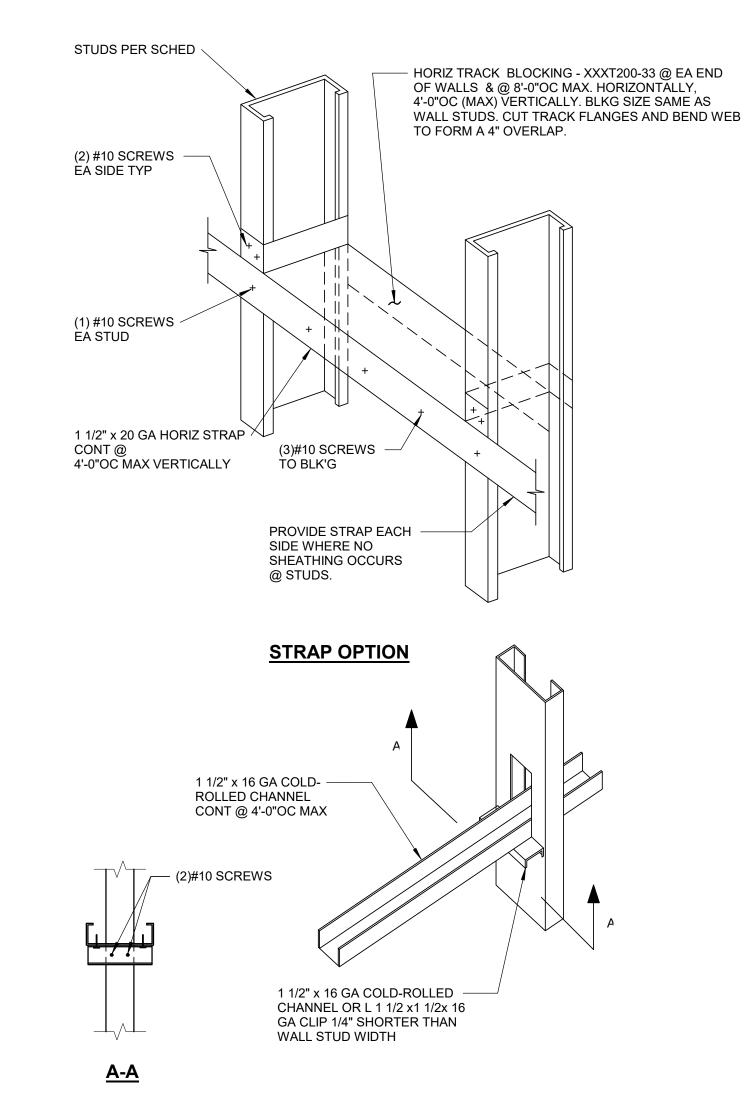
REVISIONS

03/29/2019

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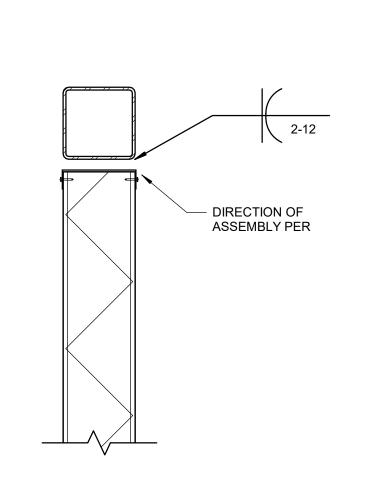


8 STEEL SLOTTED HEAD TRACK SCALE: 1" = 1'-0"



9 METAL STUD BRIDGING DETAILS SCALE: 1" = 1'-0"

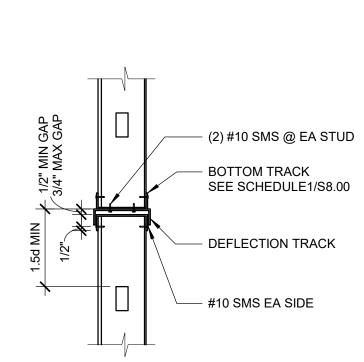
CHANNEL OPTION



NOTE:
BRIDGING NOT REQ'D WHERE
WALL IS SHEATHED W/ 1/2"
(MIN) GYPBOARD ON BOTH

STUD TO BEAM DETAIL

SCALE: 1 1/2" = 1'-0"



600T150-54 TRACK -

WALL MOUNTED ITEMS

NOTCH OVER STUDS

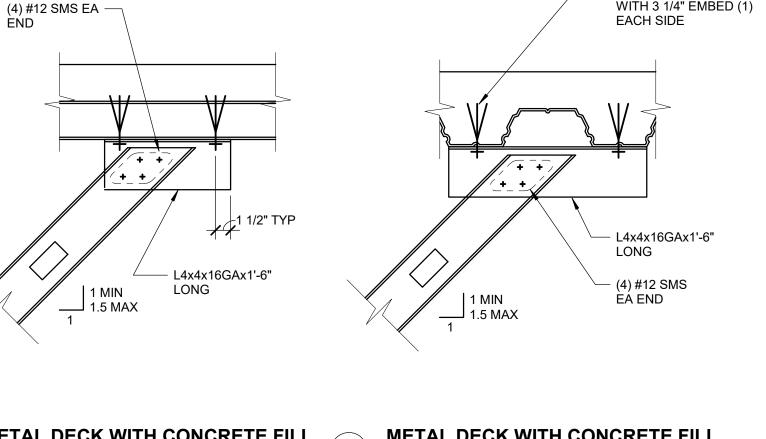
(150 LBS TO 300 LBS PER STUD)

(3) #10 x 1/2" LOW-PROFILE HEAD

SCREWS @ EA STUD, TYP

TYPICAL EXTERIOR
SLIP TRACK @ STUD TO STUD


DBL WALL STUD -



METAL DECK WITH CONCRETE FILL
FLUTES PARALLEL TO BRACE


METAL DECK WITH CONCRETE FILL
FLUTES PENDICULAR TO BRACE

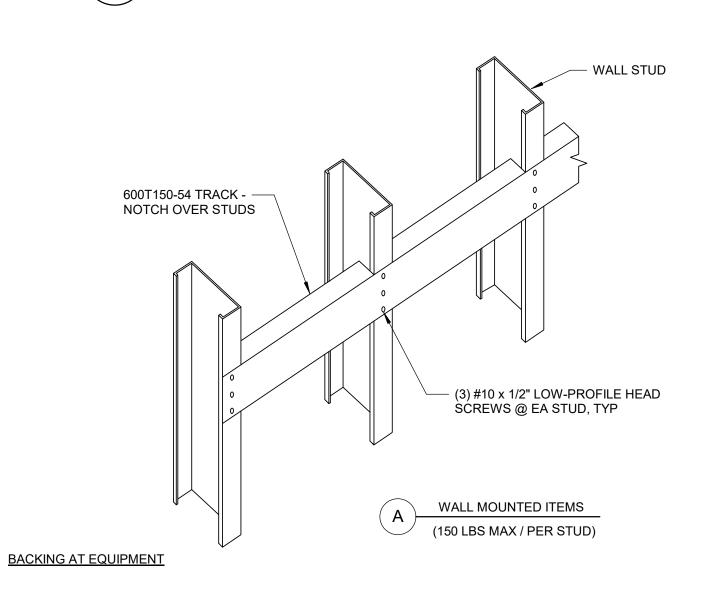3 TYPICAL BRACE ANCHORAGE DETAIL AT DECK SCALE: 1 1/2" = 1'-0"




4 METAL STUD BACKING DETAILS

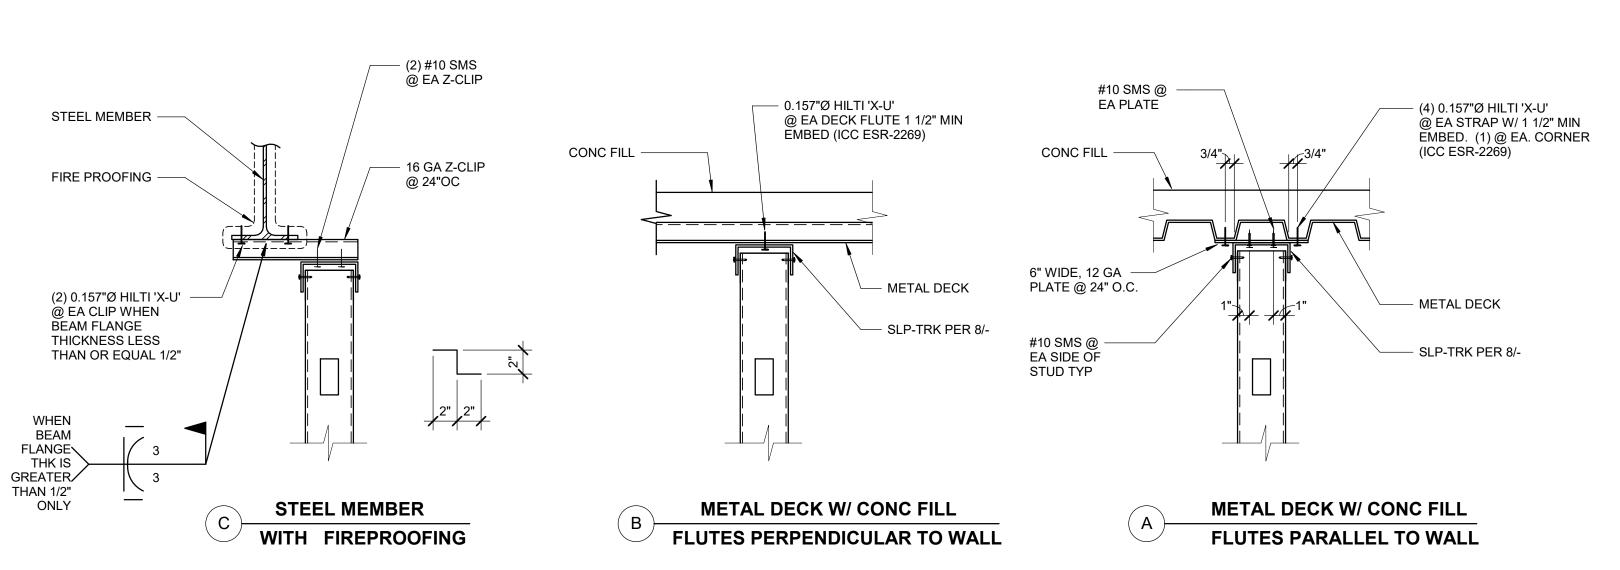
SCALE: 1" = 1'-0"




TYPICAL INTERIOR TOP TRACK ANCHORAGE

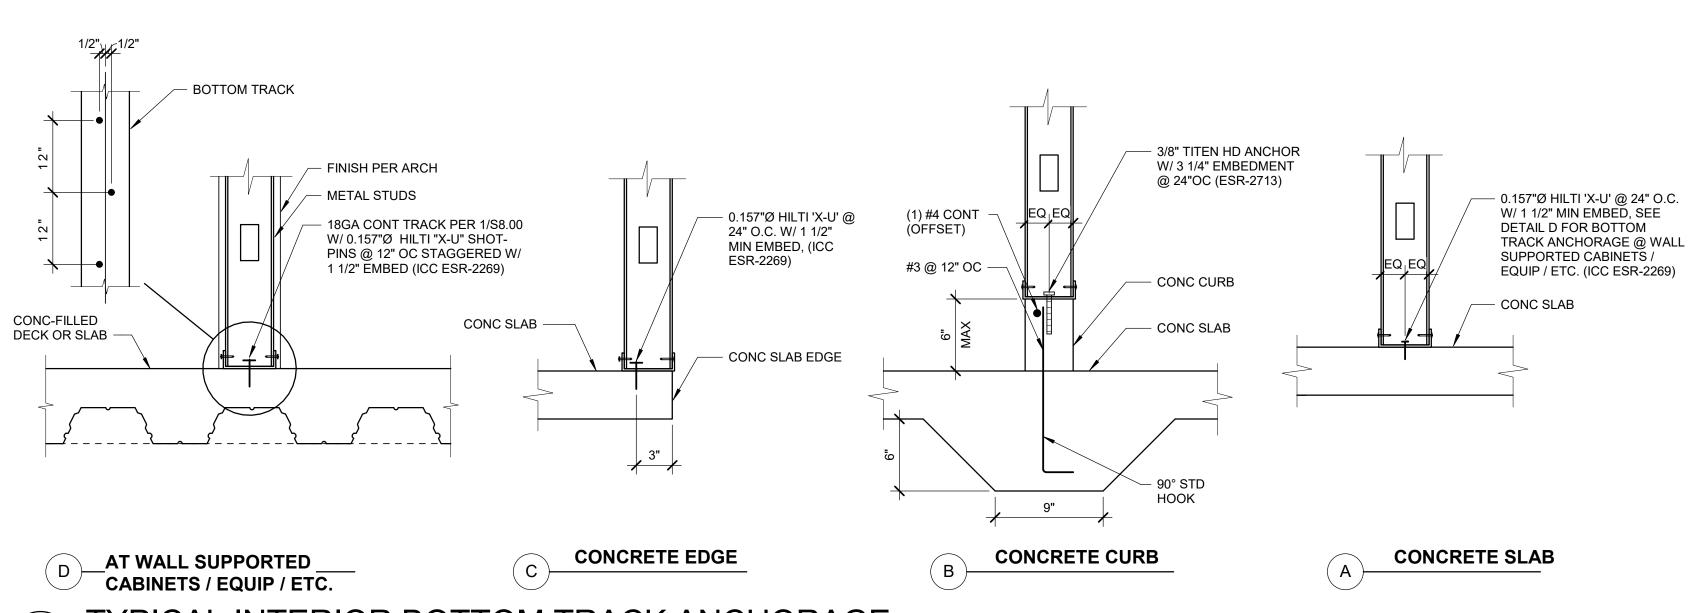


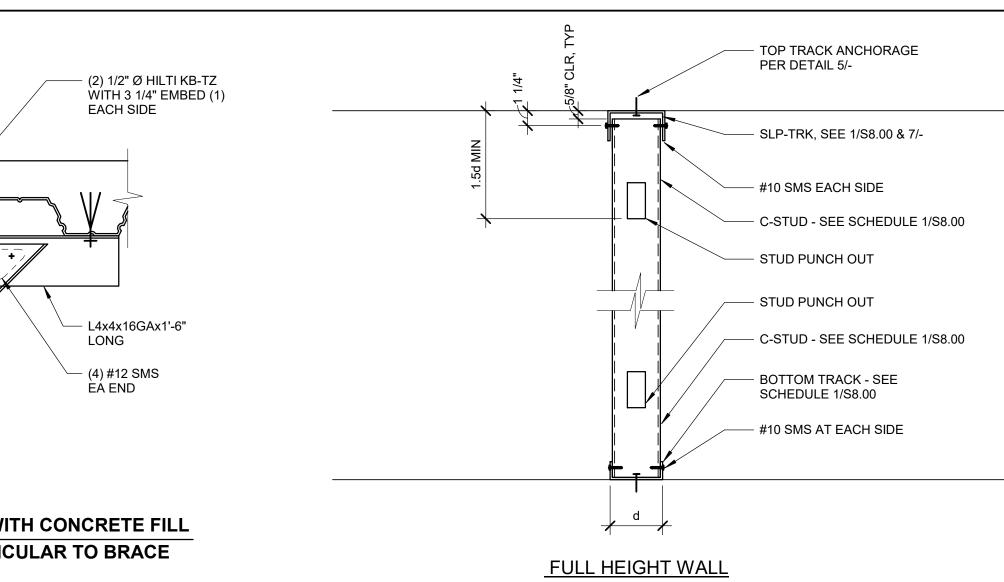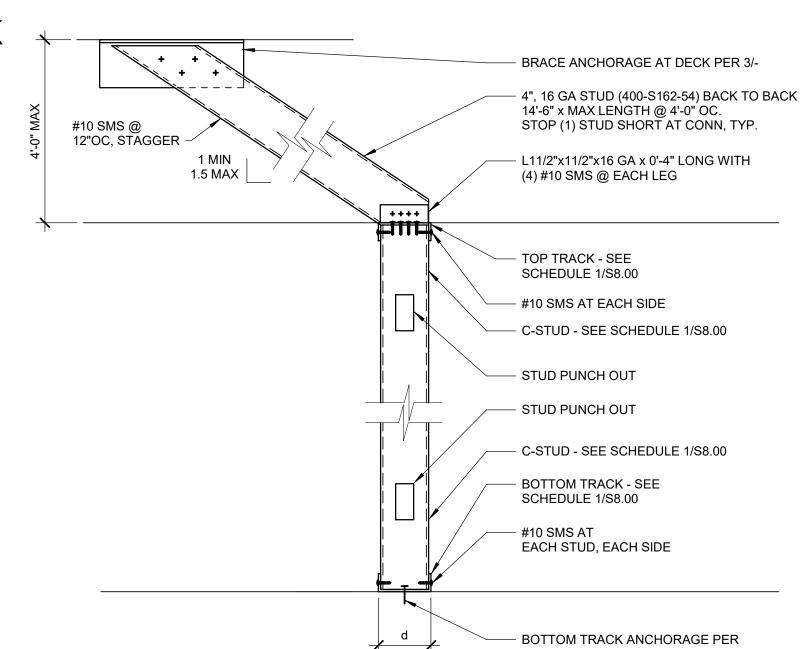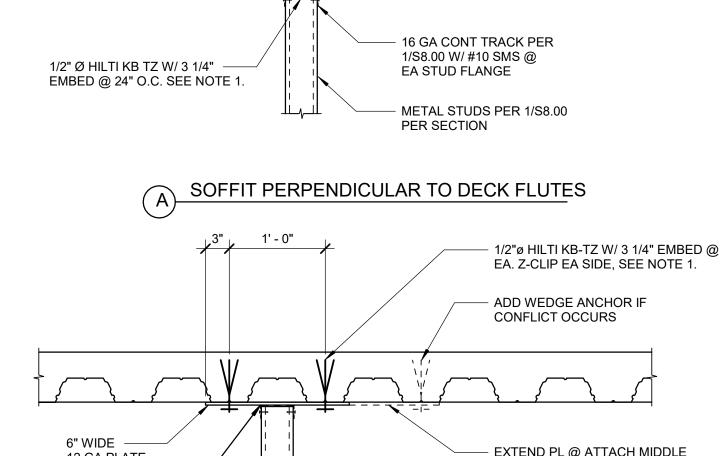6 TYPICAL INTERIOR BOTTOM TRACK ANCHORAGE
SCALE: 1 1/2" = 1'-0"











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ARCHITECT STAMP

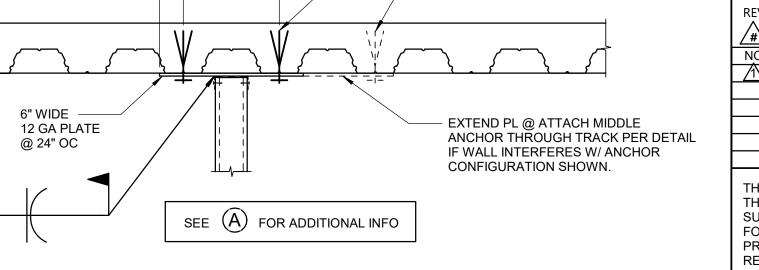
CONSULTANT STAMP

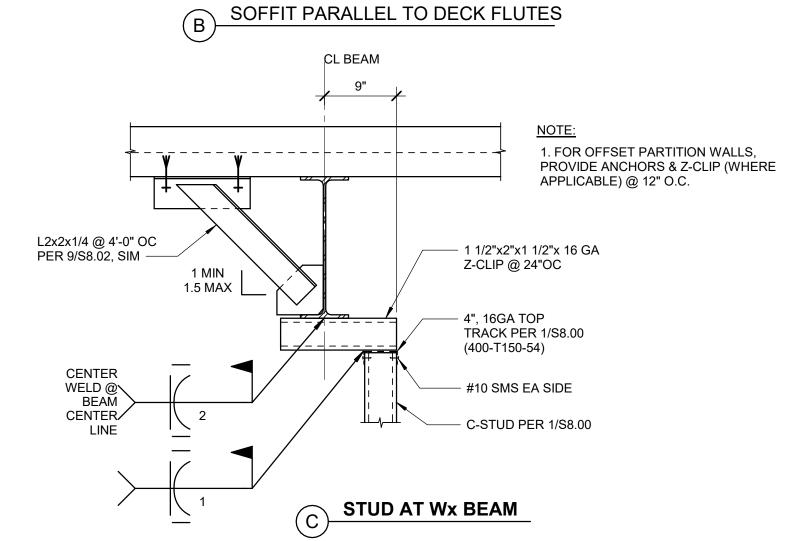PROFESS /ONLY

No. 4399

Exp. 12-31-19

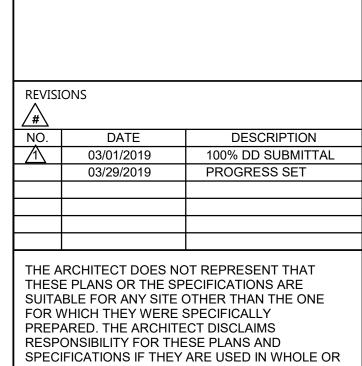AGENCY APPROVAL



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PROJECT OWNER & TITLE

MT. SAN JACINTO

COMMUNITY COLLEGE

DISTRICT

SHEET TITLE

TEMECULA VALLEY

CAMPUS 41888 Motor Car Pkwy, Temecula, CA 92591


TYPICAL METAL STUD WALL DETAILS

SHEET NO.


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DATE: Issue Date

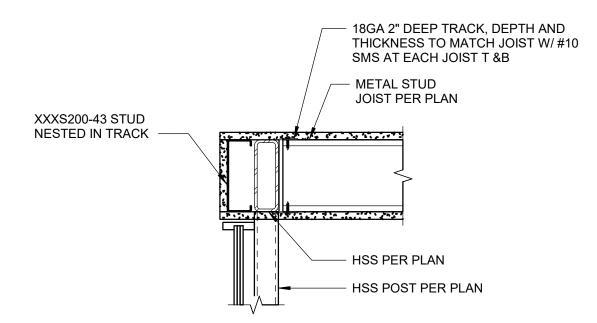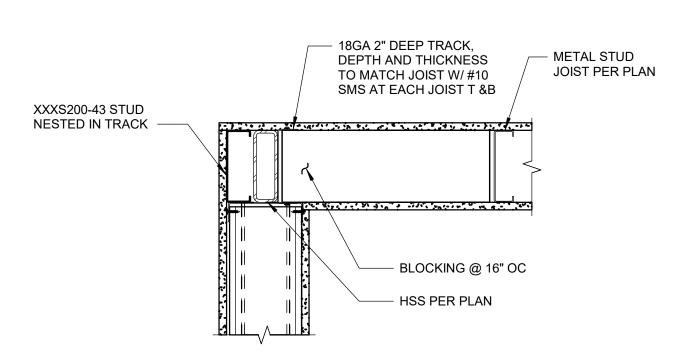
Project Status







2A CEILING AT WALL CONNECTION

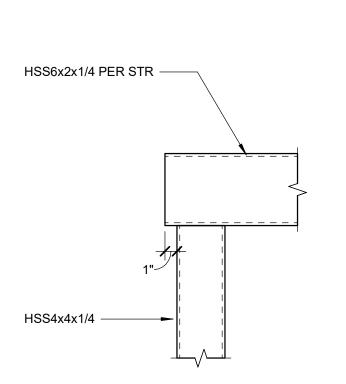

2B BEAM @ COLUMN CONNECTION AT WALL





CONSULTANT STAMP

AGENCY APPROVAL

 DATE
 DESCRIPTION

 03/01/2019
 100% DD SUBMITTAL

 03/29/2019
 PROGRESS SET

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PROJECT OWNER & TITLE

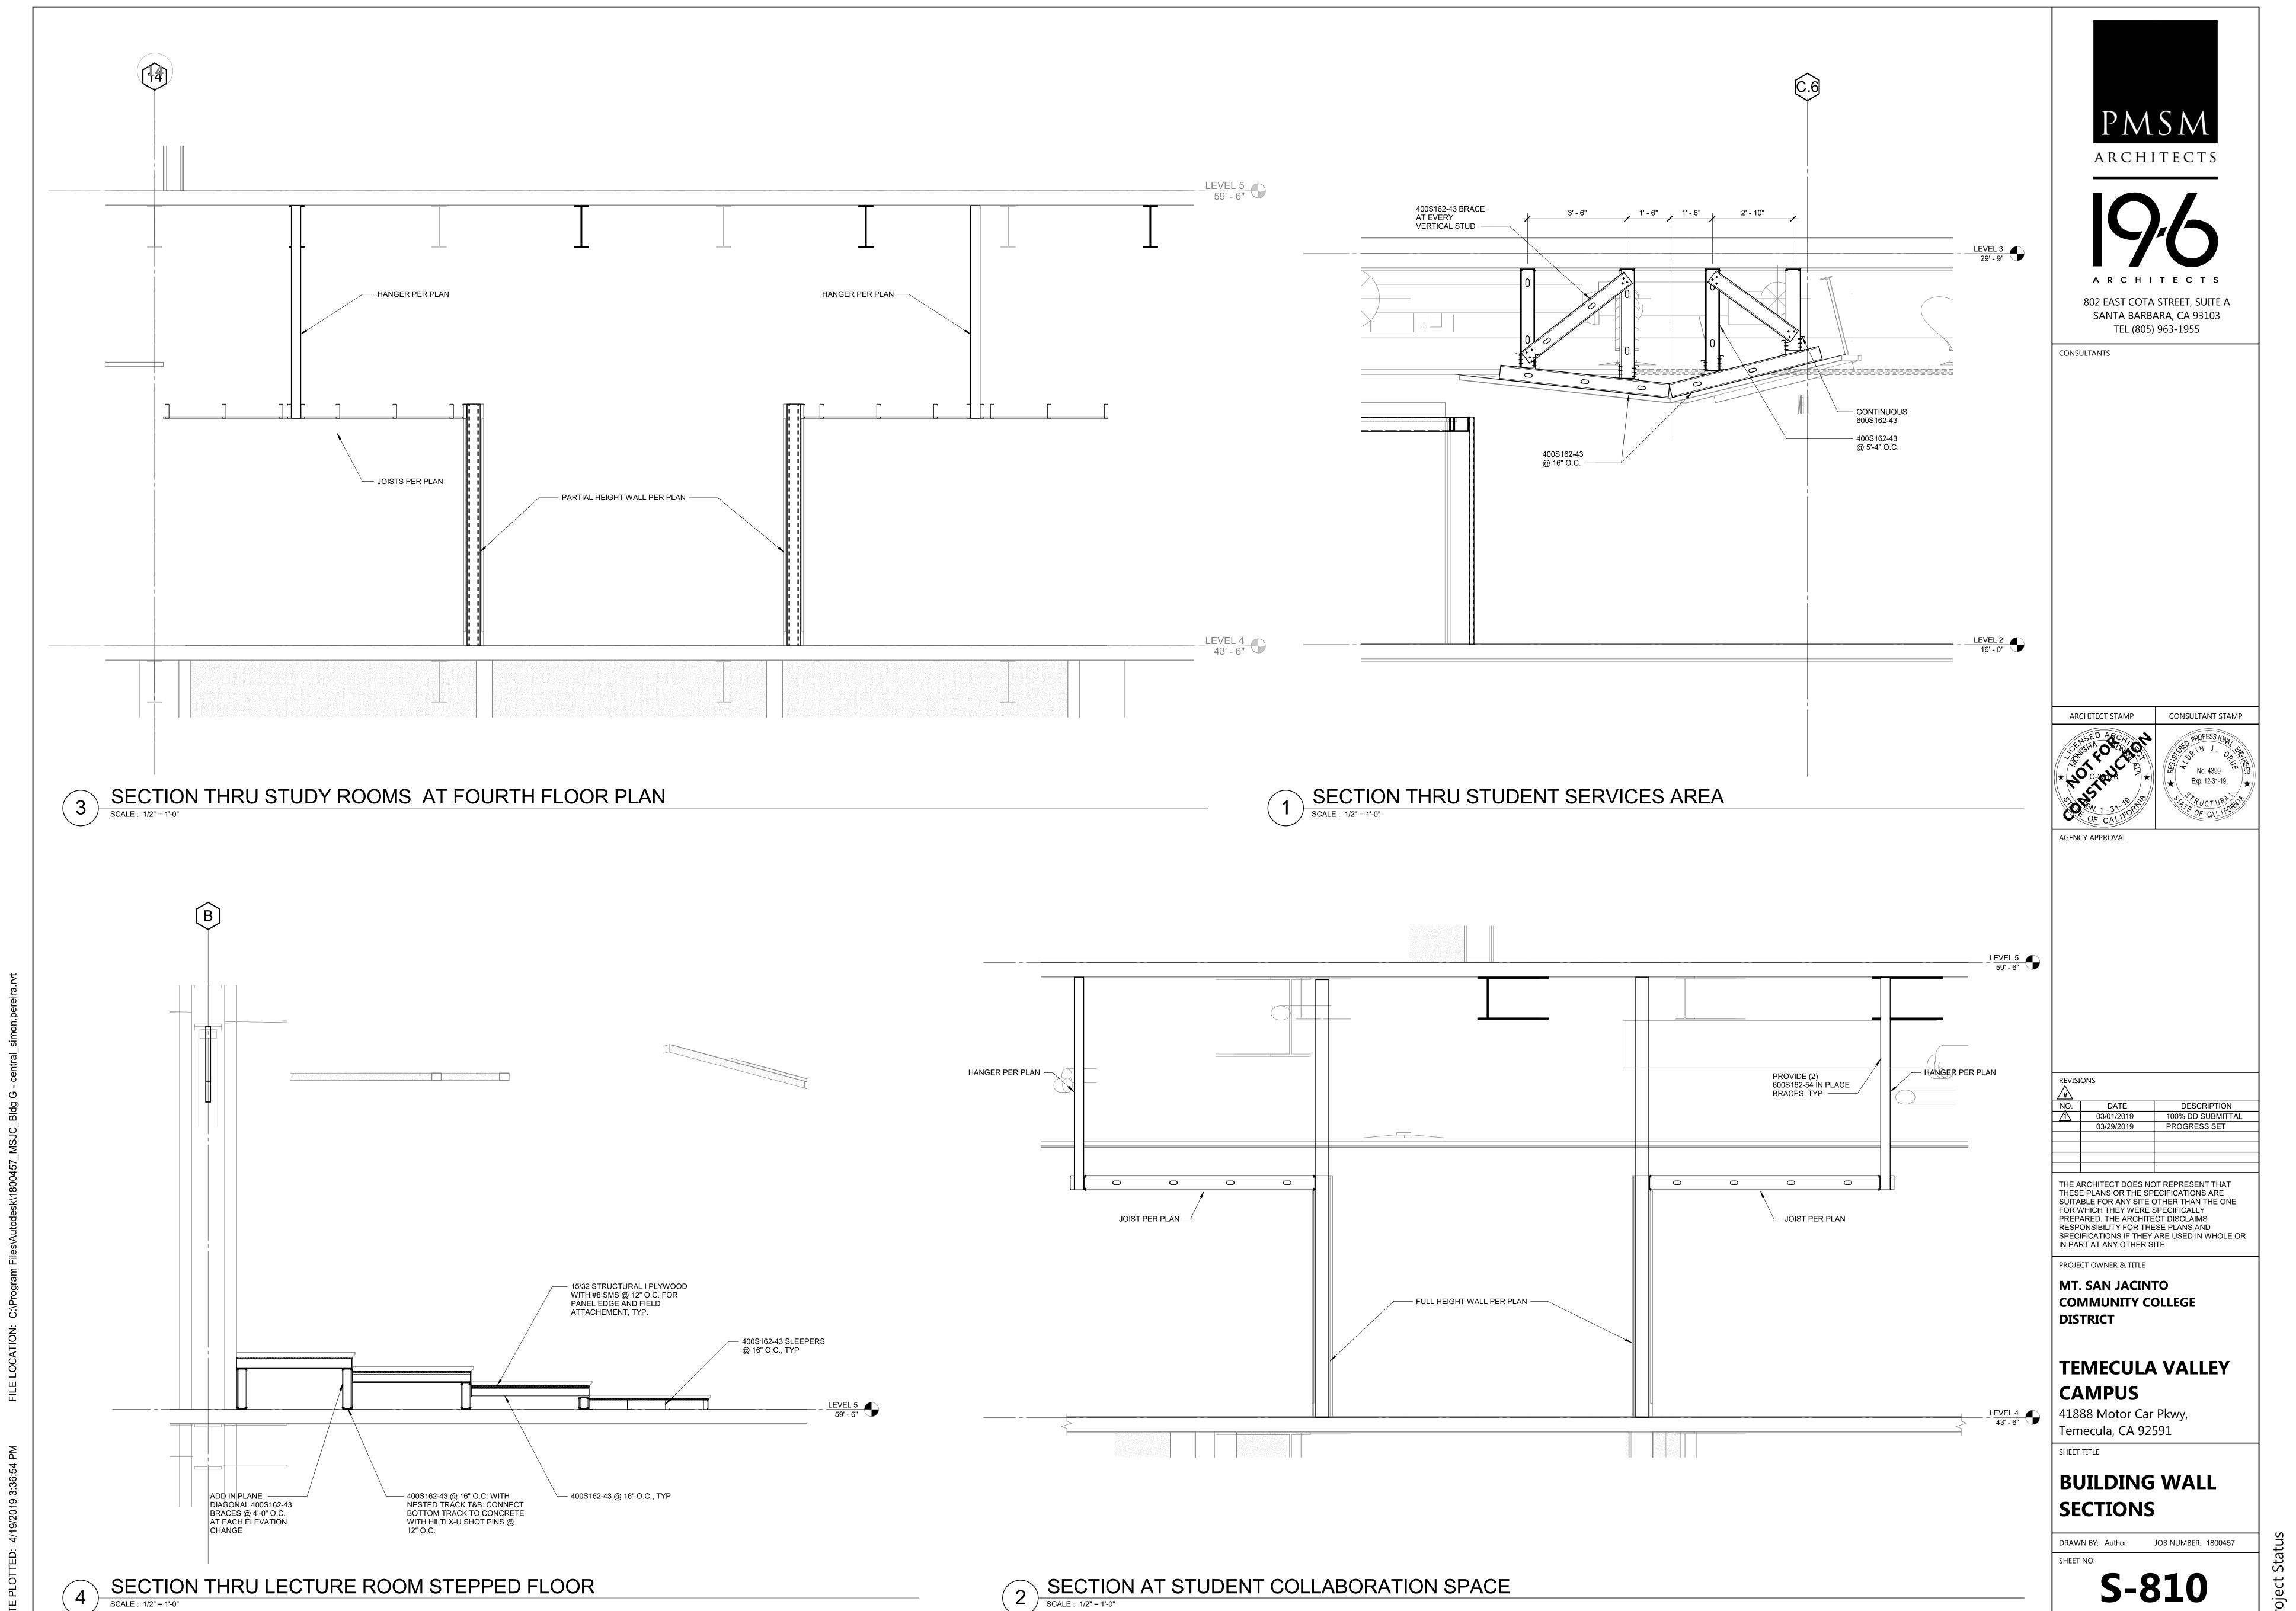
MT. SAN JACINTO COMMUNITY COLLEGE DISTRICT

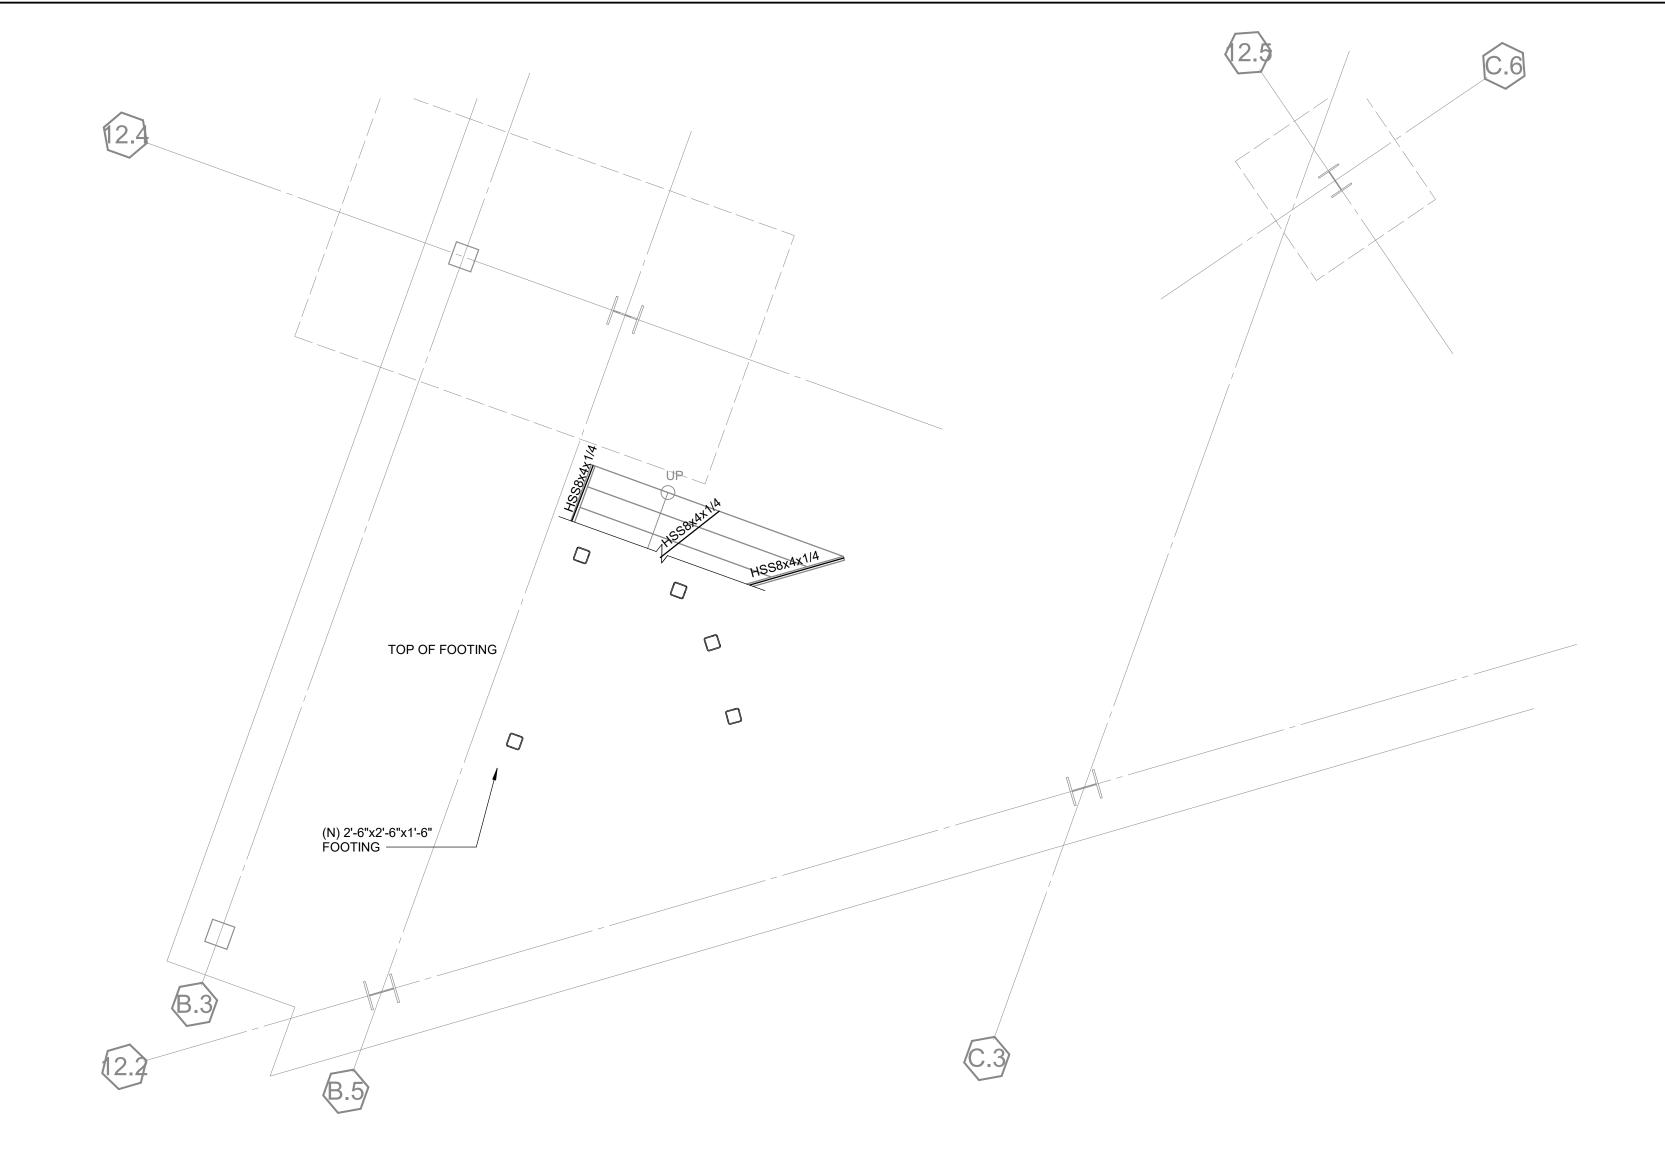
TEMECULA VALLEY CAMPUS

41888 Motor Car Pkwy, Temecula, CA 92591

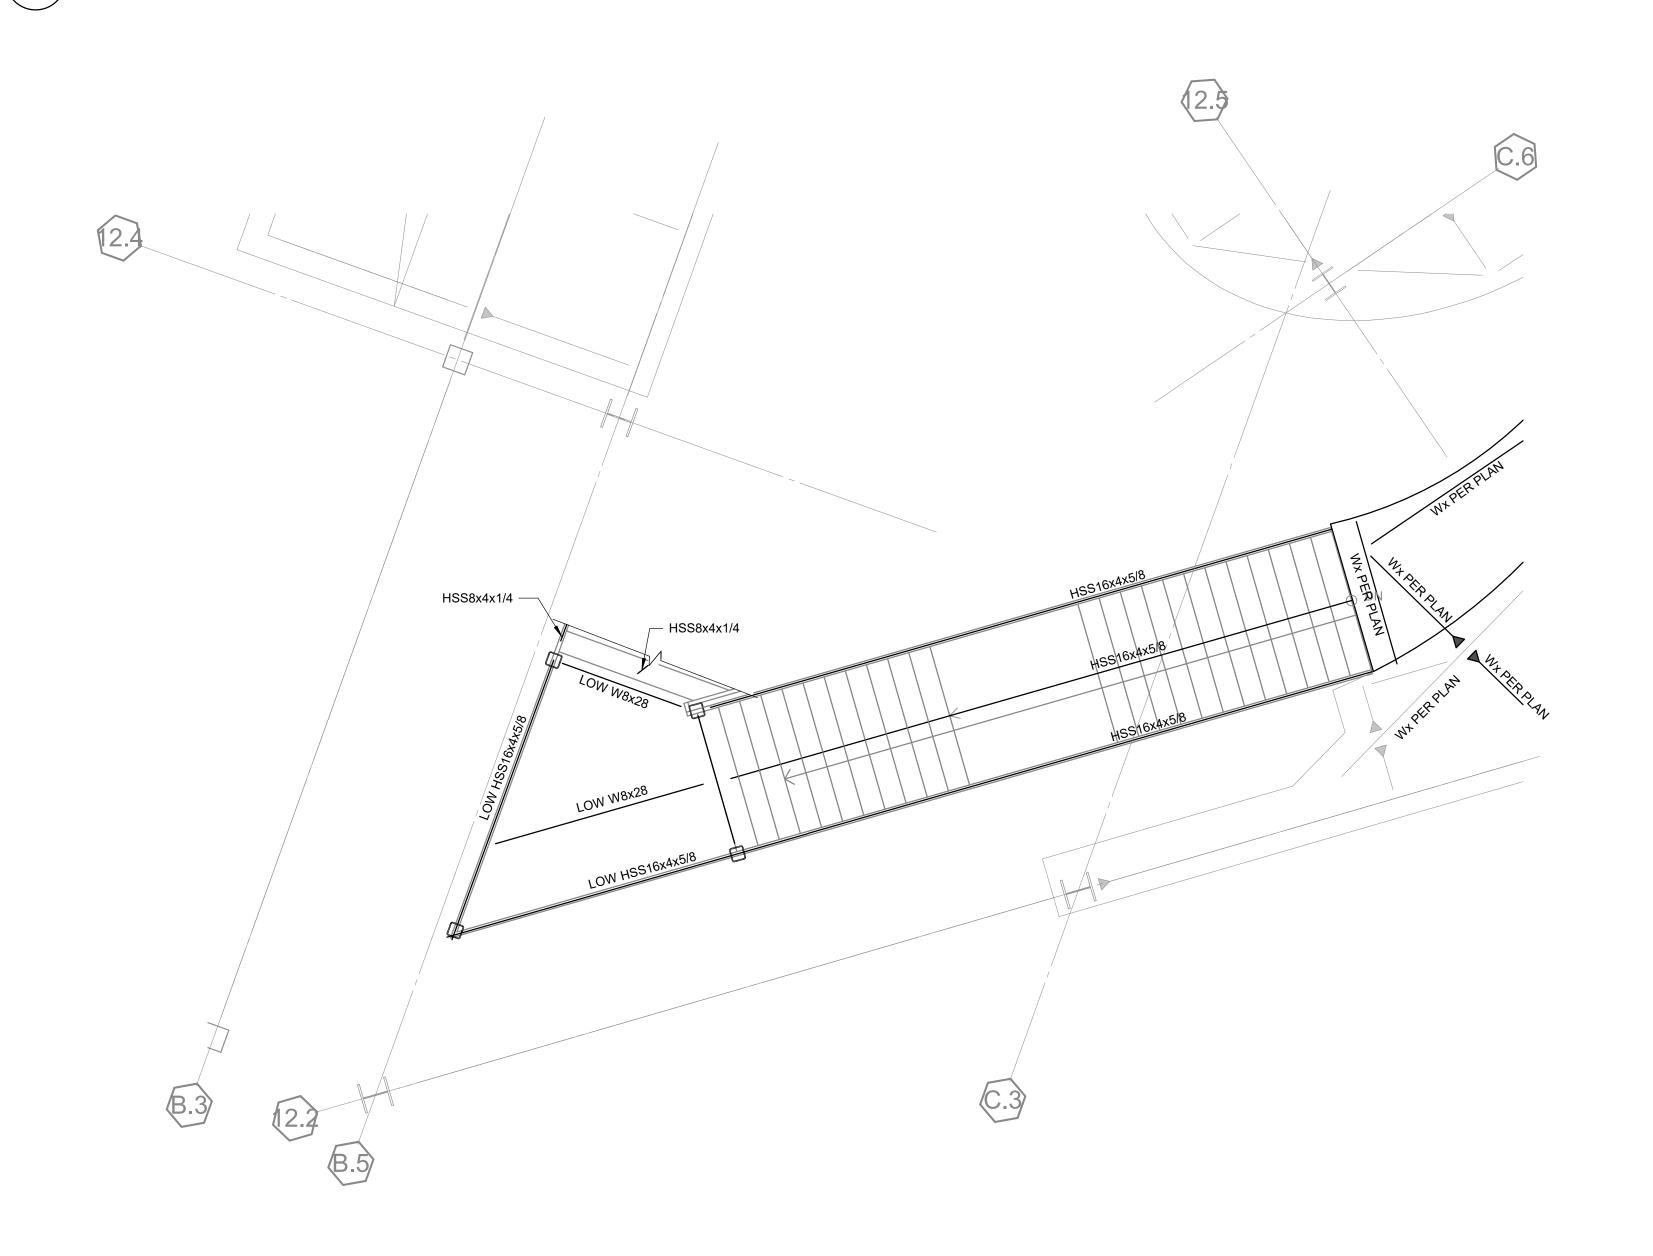
TYPICAL METAL STUD WALL DETAILS

DRAWN BY: Author JOB NUMBER: 1800457 **S-803**













802 EAST COTA STREET, SUITE A SANTA BARBARA, CA 93103 TEL (805) 963-1955

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TEE (013) 730-2001	
ARCHITECT STAMP	CONSULTANT STAMP
CENSED ARCHIVES	PROFESS IONAL CERTIFICATION OF CALIFORNIA
AGENCY APPROVAL	

REVISI	ONS	
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PROJECT OWNER & TITLE

MT. SAN JACINTO
COMMUNITY COLLEGE
DISTRICT

TEMECULA VALLEY CAMPUS

41888 Motor Car Pkwy, Temecula, CA 92591

HEET TITLE

PARTIAL STAIR PLAN

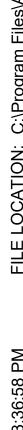
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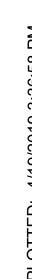
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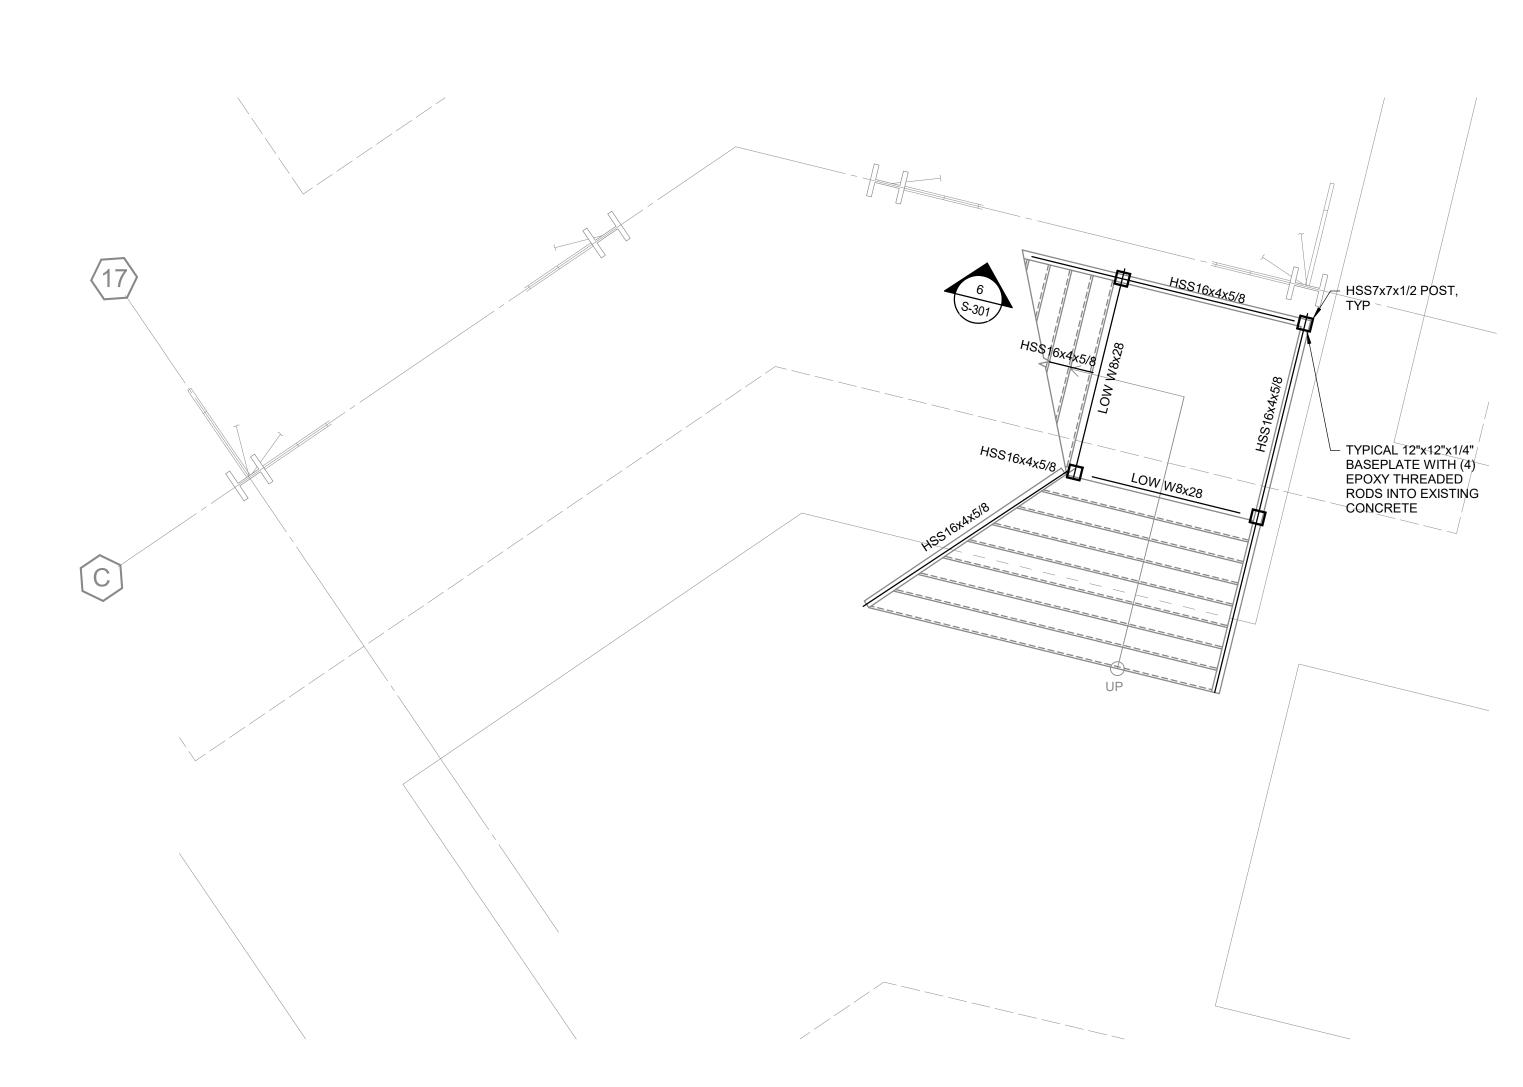
S-900

DATE: Issue Date









STAIR #5 PARTIAL PLAN - LEVEL 1

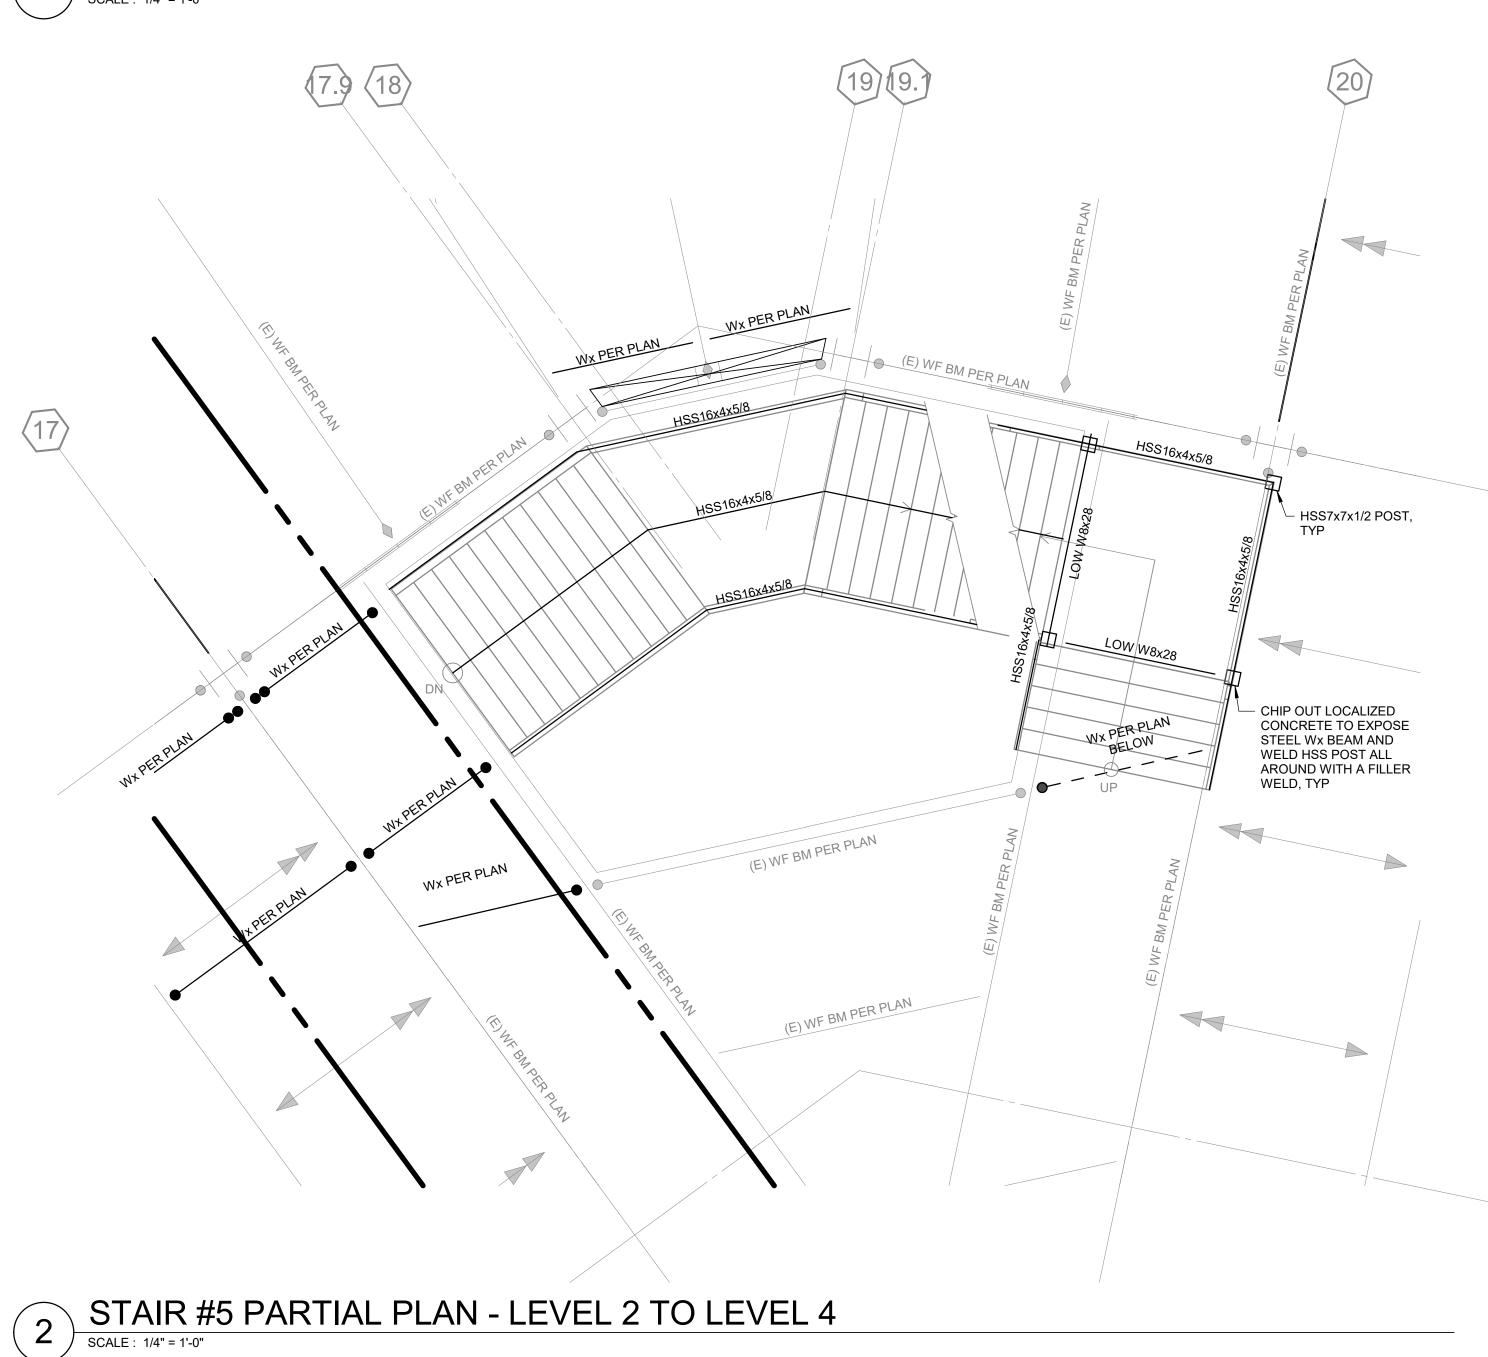
SCALE: 1/4" = 1'-0"

WX PER PLAN

(E) WF BM PER PLAN

WX PER PLAN

3 STAIR #5 PARTIAL PLAN - LEVEL 5
SCALE: 1/4" = 1'-0"





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> STRUCTURAL ENGINEER KPFF 700 South Flower Street, Suite 2100 Los Angekes, CA 90017

TEL (213) 310-8536 MECHANICAL ENGINEER P2S INC


5000 East Spring Street, Suite 800 Long Beach, CA 90815 TEL (562) 497-2999

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<u>FIRE PROTECTION ENGINEER</u> P2S INC 5000 East Spring Street, Suite 800 Long Beach, CA 90815

TEL (562) 497-2999 LABORATORY DESIGN CONSULTANT

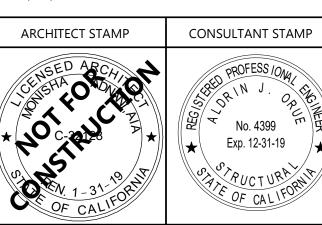San Diego, CA 92103 3965 Fifth Avenue, Suite 400 TEL (619) 756-2681



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PROJECT OWNER & TITLE

MT. SAN JACINTO COMMUNITY COLLEGE DISTRICT

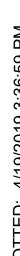
TEMECULA VALLEY CAMPUS

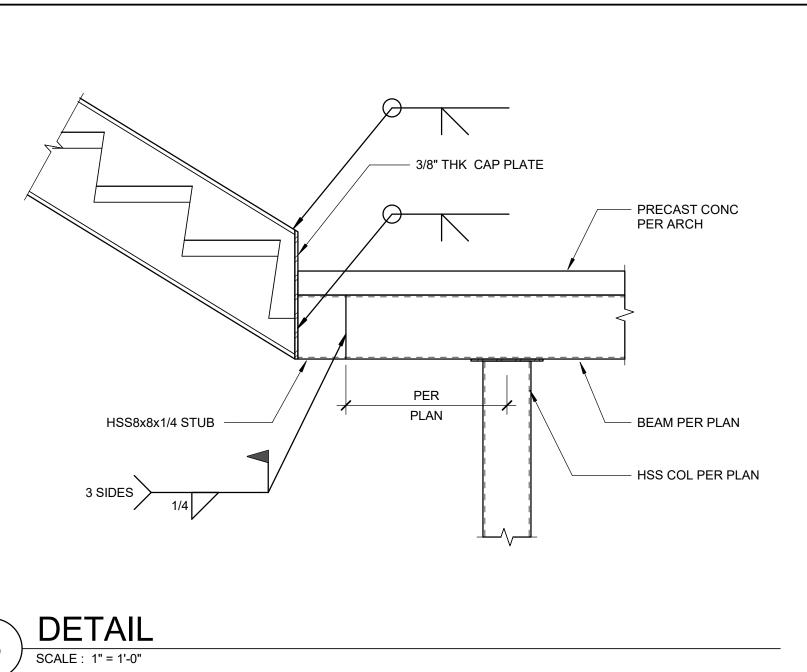
41888 Motor Car Pkwy, Temecula, CA 92591

PARTIAL STAIR PLAN

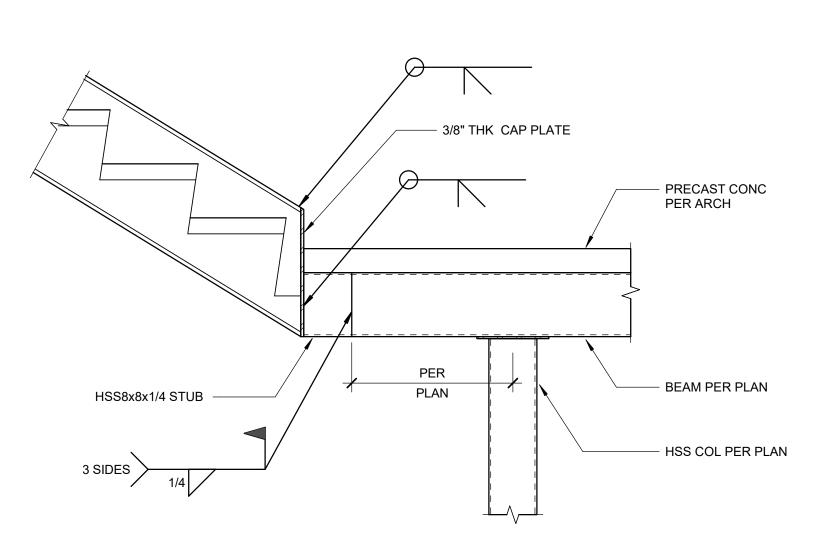
DRAWN BY: Author JOB NUMBER: 1800457

S-901 DATE: Issue Date











6 DETAIL

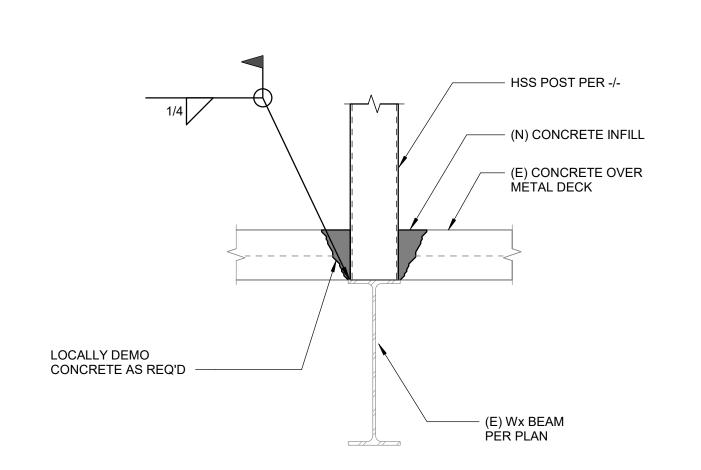SCALE: 1" = 1'-0"




DETAIL

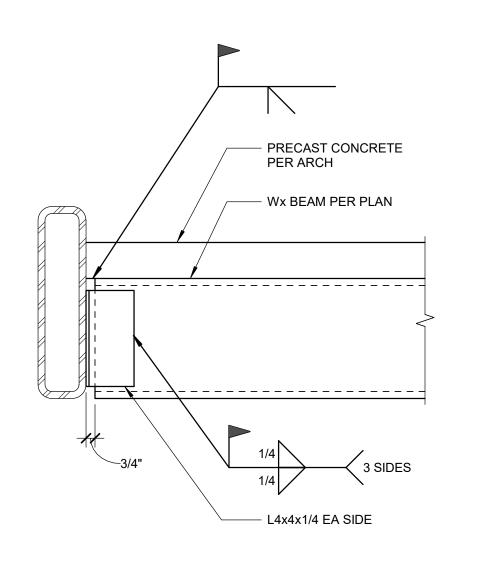SCALE: 1" = 1'-0"




8 DETAIL
SCALE: 1 1/2" = 1'-0"

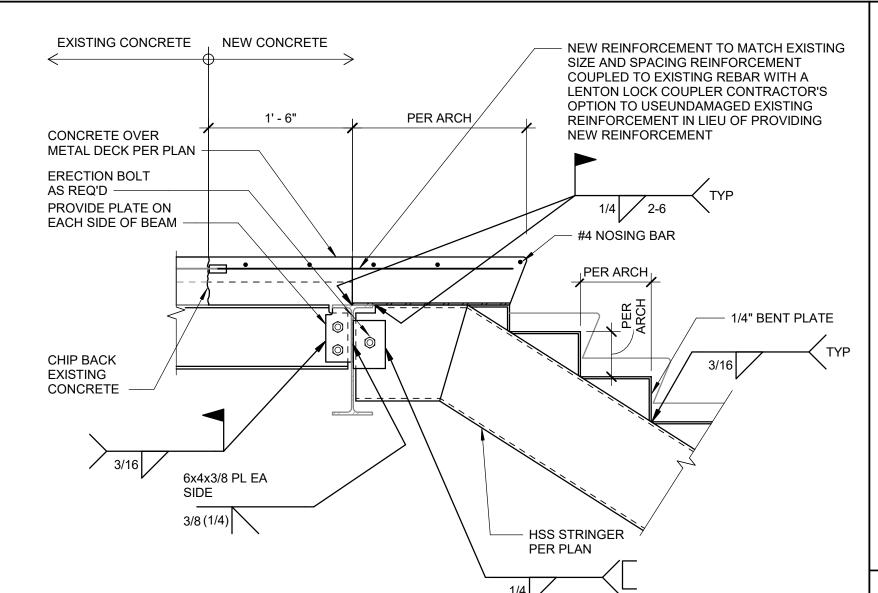


1 NEW STAIR STRINGER TO WX CONNECTION

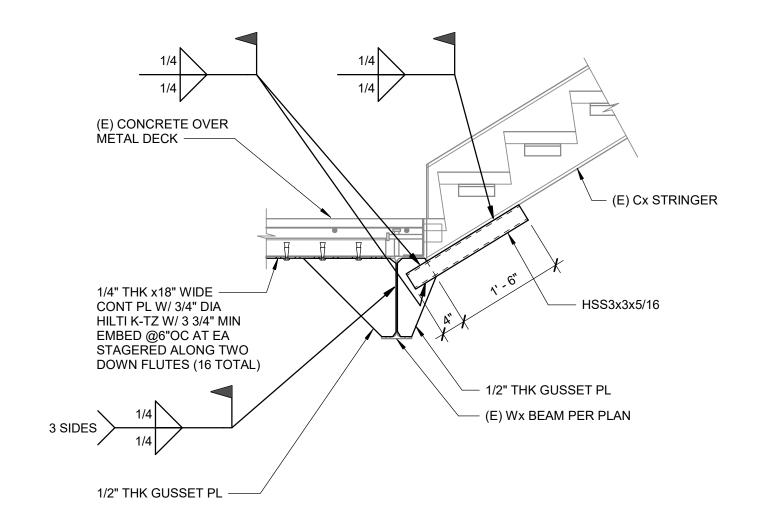SCALE: 1" = 1'-0"




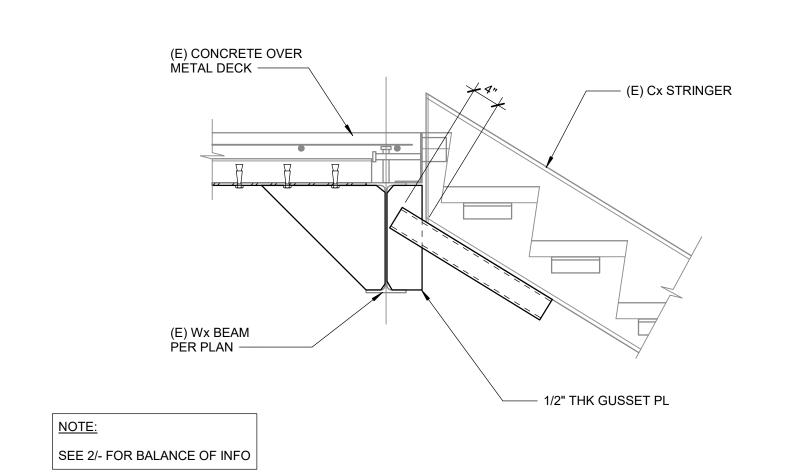STRENGTHENING EXISTING STAIR CONNECTION AT FLOOR



STRENGTHENING EXISTING STRINGER 3 CONNECTION AT FLOOR

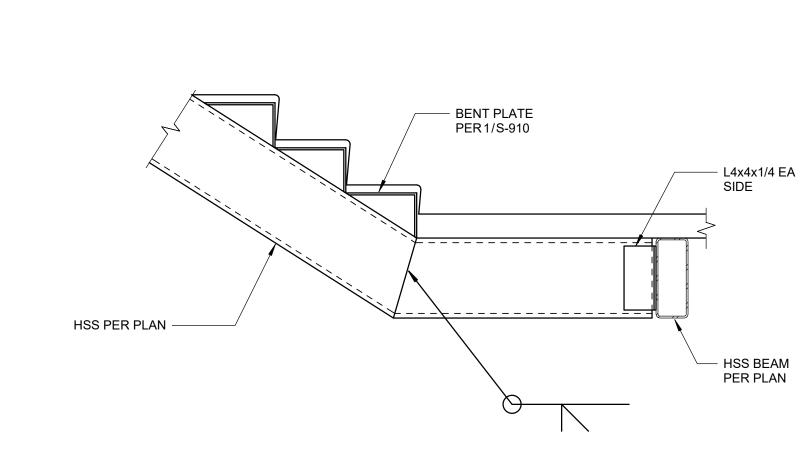SCALE: 1" = 1'-0"



4 DETAIL

SCALE: 1" = 1'-0"



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STRUCTURAL ENGINEER 700 South Flower Street, Suite 2100 Los Angekes, CA 90017


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TEMECULA VALLEY CAMPUS

41888 Motor Car Pkwy, Temecula, CA 92591

SHEET TITLE

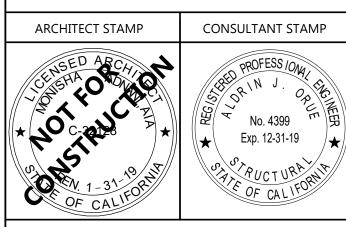STAIR DETAILS

DRAWN BY: Author JOB NUMBER: 1800457 **S-910** DATE: Issue Date